COMMERCIAL SITE PLAN "ROCK IRON REPAIR" TAX MAP 265, LOT 11 & 12 CALEF HIGHWAY, BARRINGTON, NH

SHEET INDEX

COVER SHEET

EXISTING CONDITIONS PLAN

C2 SITE PLAN

C1

E1

C3 GRADING AND DRAINAGE PLAN

1.1 LIGHTING AND LANDSCAPE PLAN

HA1 HIGHWAY ACCESS PLAN


TM1 SITE CIRCULATION PLAN

D1-D2 **DETAIL SHEETS**

EROSION AND SEDIMENT CONTROL DETAILS

S1 SEPTIC SYSTEM PLAN

ARCH1 BUILDING PLAN

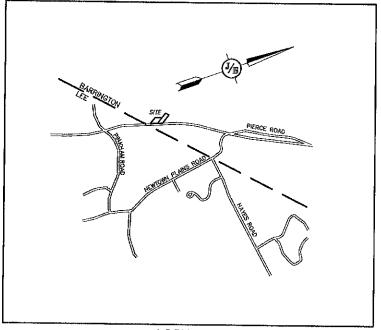

LOCUS MAP SCALE 1" = 2000'

APPLICANT / DEVELOPER JEFFREY SULLIVAN

P.O. BOX 144 224 OLD TURNPIKE ROAD WEST NOTTINGHAM, NH 03291 (603) 817-1030 EMAIL: ROCKIRONREPAIR@YAHOO.COM

CIVIL ENGINEER / SURVEYOR JONES & BEACH ENGINEERS, INC. 85 PORTSMOUTH AVENUE

PO BOX 219 STRATHAM, NH 03885 (603) 772-4746

CONTACT: BARRY GIER EMAIL: BGIER@JONESANDBEACH.COM

OWNER OF RECORD JEFFREY SULLIVAN P.O. BOX 144

224 OLD TURNPIKE ROAD WEST NOTTINGHAM, NH 03291 (603)-817-1030 EMAIL: ROCKIRONREPAIR@YAHOO.COM

WETLAND CONSULTANT

GOVE ENVIRONMENTAL SERVICES, INC. 8 CONTINENTAL DR. BLDG 2, UNIT H EXETER, NH 03833 (603)-778-0644

- FRONT SETBACK = 78'
 SIDE SETBACK = 30'
 REAR SETBACK = 30'
 WETLAND SETBACK = 50'
- 3. LOT COVERAGE CALCULATIONS: LOT AREA = 162,210 SF MAX. LOT COVERAGE = 50% = 76,105 SF PROPOSED LOT COVERAGE = 23,57% = 35,875 SF
- 4. PARKING CALCULATIONS:

REQUIRED:
NAME:
NA

PROVIDED: TOTAL SPACES PROVIDED= 9 SPACES

- 5. THE EXISTING SITE IS CURRENTLY UNDEVELOPED.
- 6. PROJECT TO BE SERVICED BY ON-SITE WELL AND ON-SITE SEPTIC SYSTEM
- 7. EXPECTED TIME OF CONSTRUCTION: JUNE 2022 TO DEC. 2022
- 8. THE SUBJECT PARCEL NOT IS LOCATED WITHIN AN AREA HAVING A SPECIAL FLOOD HAZARD ZONE DESIGNATION BY THE FEDERAL EMERGENCY MANAGEMENT AGENCY (FEMA), ON HOLOD INSUBANCE RATE MAP NO. 3301700205D, WITH EFFECTIVE DATE OF MAY 17, 2005.

- 11. ALL MATERIALS AND METHODS OF CONSTRUCTION SHALL CONFORM TO TOWN REGULATIONS AND THE LATEST EDITION OF THE NEW HAMPSHIRE DEPARTMENT OF TRANSPORTATION'S STANDARD SPECIFICATIONS FOR ROAD AND BRIDGE CONSTRUCTION
- 2. REQUIRED EROSION CONTROL MEASURES SHALL BE INSTALLED PRIOR TO ANY DISTURBANCE OF THE SITE'S SURFACE AREA AND SHALL BE MAINTAINED THROUGH THE GOMENTETON OF ALL CONSTRUCTION ACTIVITIES. IF, DURING CONSTRUCTION, IT BECOMES APPAIRENT THAT ADDITIONAL EROSION CONTROL MEASURES ARE REQUIRED TO STOP ANY EROSION ON THE CONSTRUCTION STEP DUE TO ACTUAL SITE CONSTROME, THE OWNER SHALL BE REQUIRED TO INSTALL THE NECESSARY EROSION PROTECTION AT NO EXPENSE TO THE TOWN.

PERMITS

TYPE OF PERMIT

STATUS

NHDOT DRIVEWAY PERMIT: P.O. BOX 740 **DURHAM. NEW HAMPSHIRE 03824**

PERMIT NO DATED: EXPIRATION:

SUBMITTED:

RESPONSIBLE CONSULTANT. JONES & BEACH ENGINEERS, INC.

333 CALEF HIGHWAY

SUBMITTED: PERMIT NO. DATED:

BARRINGTON, NEW HAMPSHIRE 038: (603)-664-5476 RESPONSIBLE CONSULTANT: JONES & BEACH ENGINEERS, INC.

EXPIRATION

NHDES INDIVIDUAL SEPTIC PERMIT: NEW HAMPSHIRE DEPARTMENT OF ENVIRONMENTAL SERVICES -SUBSURFACE SYSTEMS BUREAU 29 HAZEN DRIVE, P.O. BOX 95

PERMIT NO.

CONCORD, NEW HAMPSHIRE 03302-0095, DATED:

EXPIRATION

RESPONSIBLE CONSULTANT: JONES & BEACH ENGINEERS, INC.

USEPA NPDES PHASE II CONSTRUCTION GENERAL PERMIT, NOTICE OF INTENT (NOI), AND NOTICE OF TERMINATION (NOT) TO BE FILED IN ACCORDANCE WITH FEDERAL AND LOCAL REGULATIONS PRIOR TO AND FOLLOWING CONSTRUCTION: **EPA STORMWATER NOTICE PROCESSING CENTER** MAIL CODE 4203M. 1200 PENNSYLVANIA AVENUE, NW WASHINGTON, DC 20460 JONES & BEACH ENGINEERS INC.

OWNER: JEFFREY SULLIVAN

TOWN OF BARRINGTON TAX MAP 265, LOTS 11 & 12

APPLICANT/OWNER
JEFFREY SULLIVAN
224 OLD TURNPIKE ROAD WEST NOTTINGHAM, NH 0329

TOTAL LOT AREA

APPROVED - BARRINGTON, NH PLANNING BOARD

LAND USE OFFICE

DATE:

Direct Direct Direct Date, 06/14/22
Checked: BWG Scale: AS NOTED Project No.; 21206
Drawing Name: 21206-PLAN.dwg
THIS PLAN SHALL NOT BE MODIFIED WITHOUT WRITTEN
PERMISSION FROM JONES & BEACH ENGINEERS, INC. (JBE).
ANY ALTERATIONS, AUTHORIZED OR OTHERWISE, SHALL BE
AT THE LIGEDIS SOLE DICK AND INTUINITE LABOURS TO

Design: Divid | Dreft DED


2	6/14/22	REVISED PER CMA REVIEW	BWG
1	5/2/22	REVISED PER PB COMMENTS	BWG
D	3/15/22	ISSUED FOR REVIEW	BWG
REV.	DATE	REVISION	BY


1/		De	signed and Pro	duced in NH		
/B	Jones	&	Beach	ı Engir	neers,	Inc.
85 Portsmouth Ave PO Box 219 Strathern, NH 0388		Eng	ineering	Services	FAX: 603	3-772-474 0 3-772-0227


E-MAIL: JBE@JONESANDBEACH.COM

· · · · · · · · · · · · · · · · · · ·		
Plan Name:	COVER SHEET	$\neg \vdash$
Project:	ROCK IRON REPAIR CALEF HIGHWAY, BARRINGTON, NH	
Owner of Record:	JEFFREY SULLIVAN 224 OLD TURNPIKE RD., WEST NOTTINGHAM, NH 03291	- - .

DRAWING No.

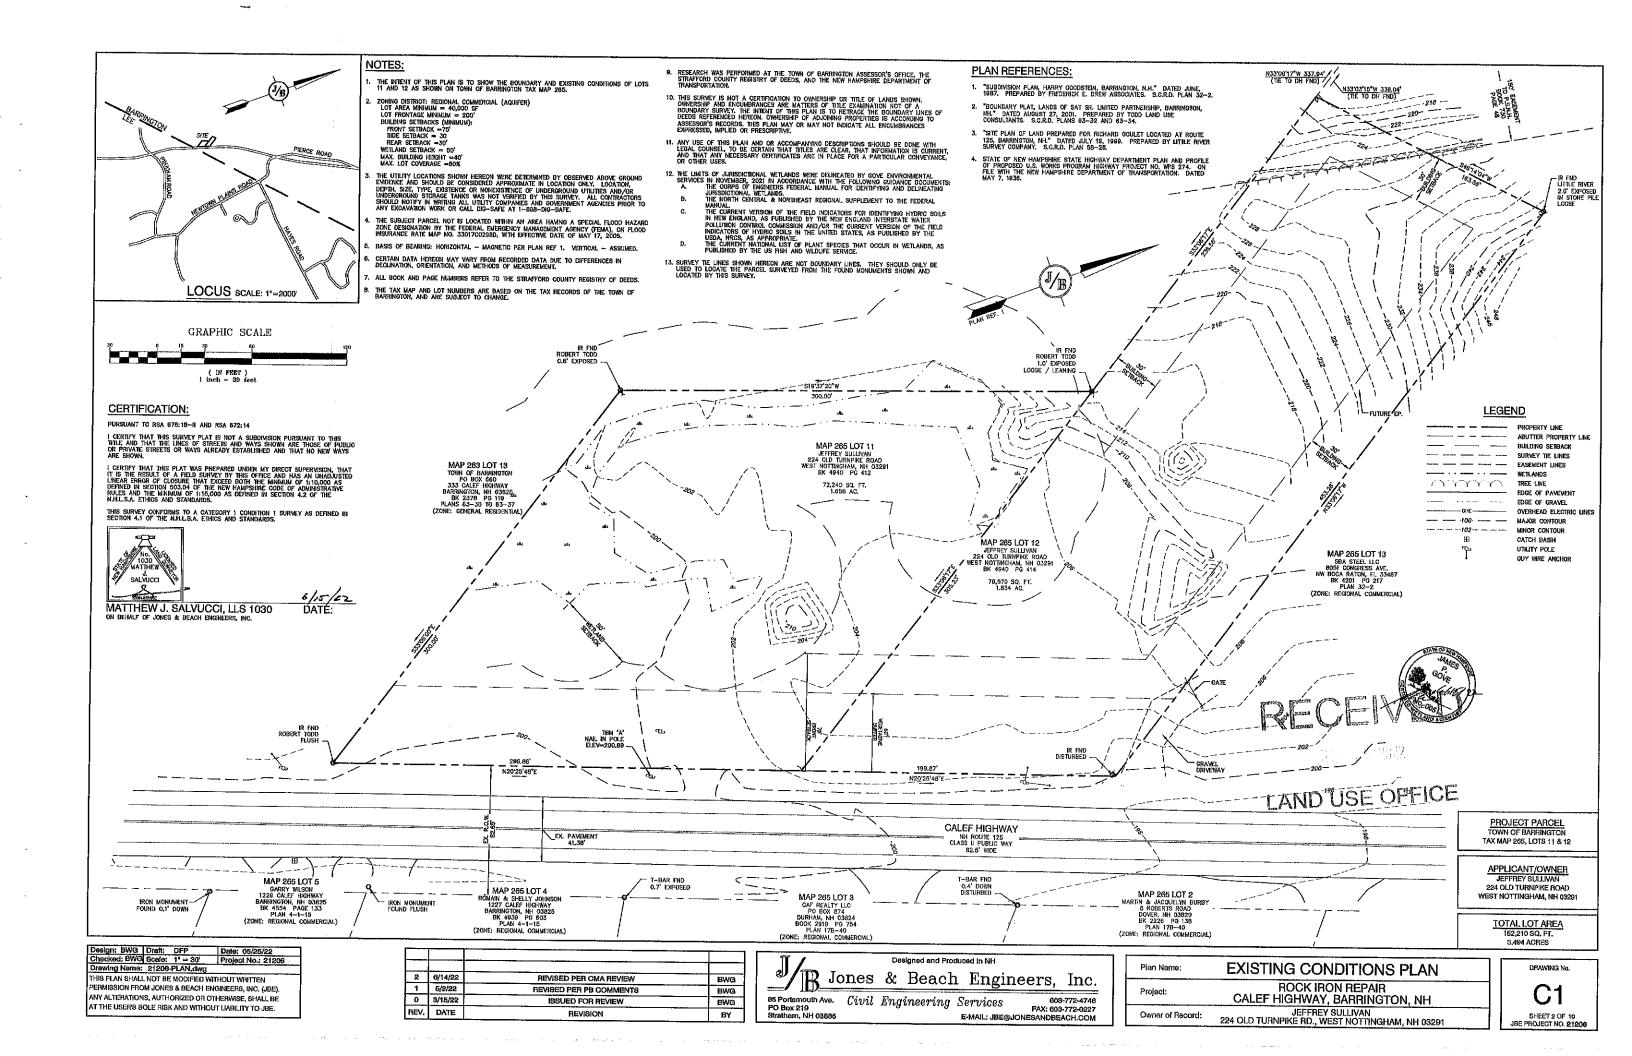

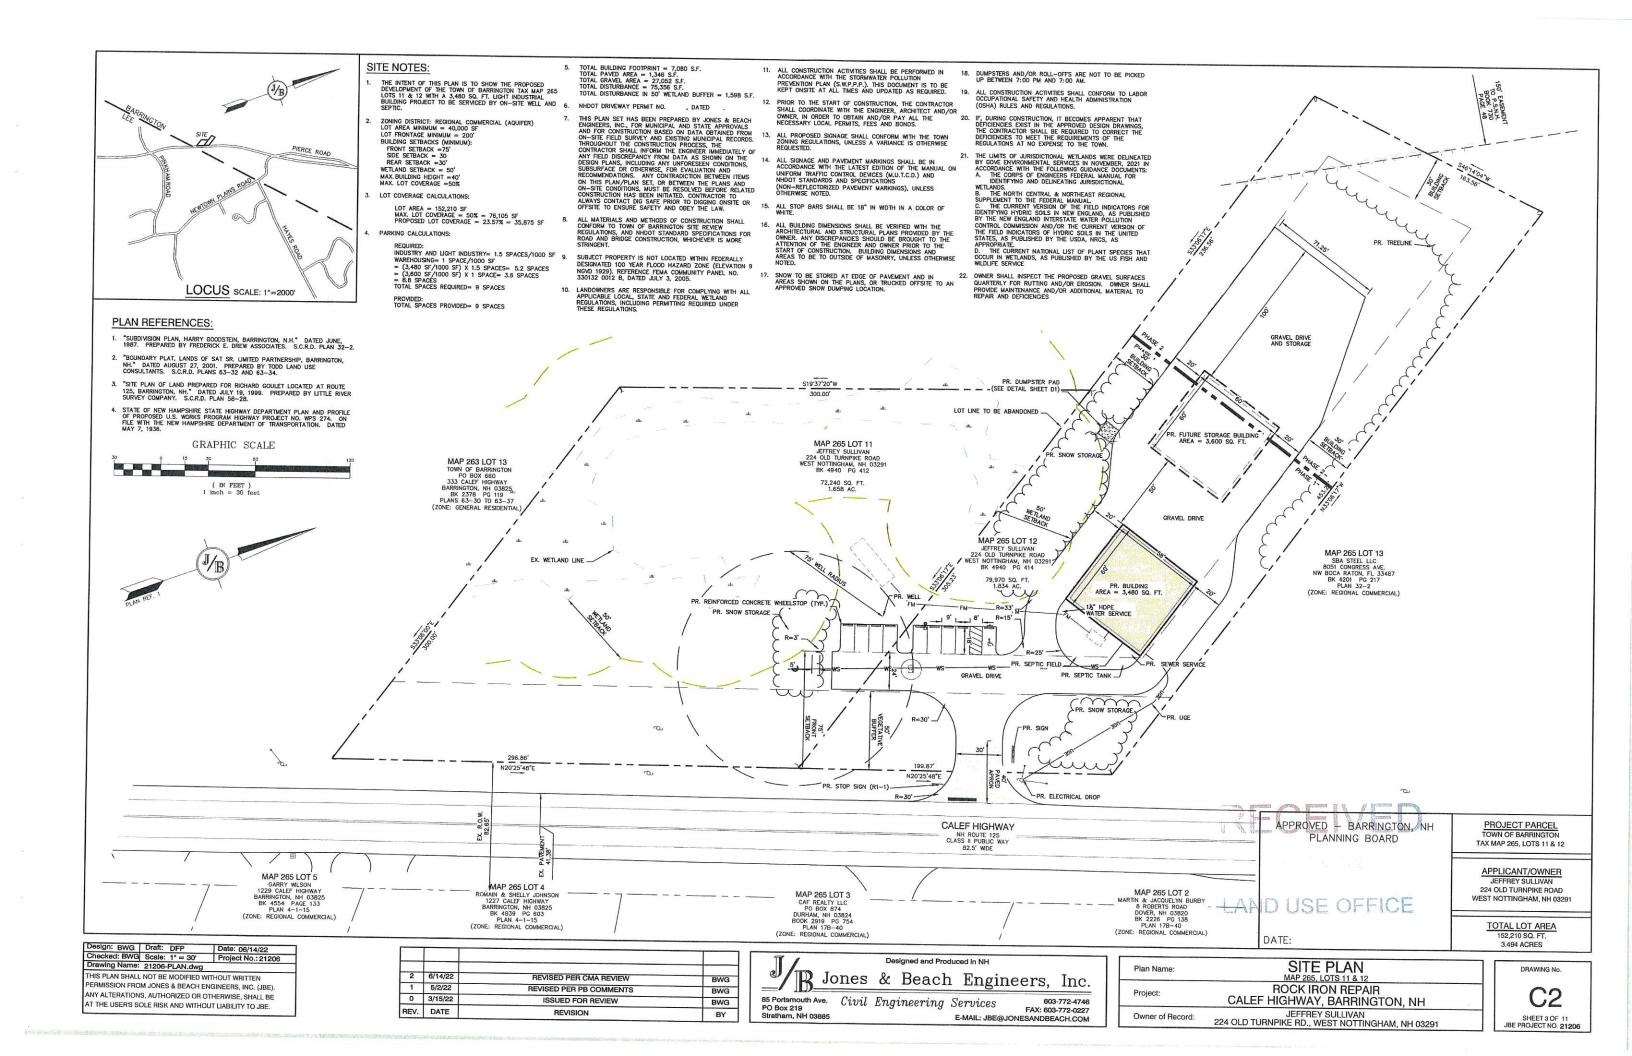

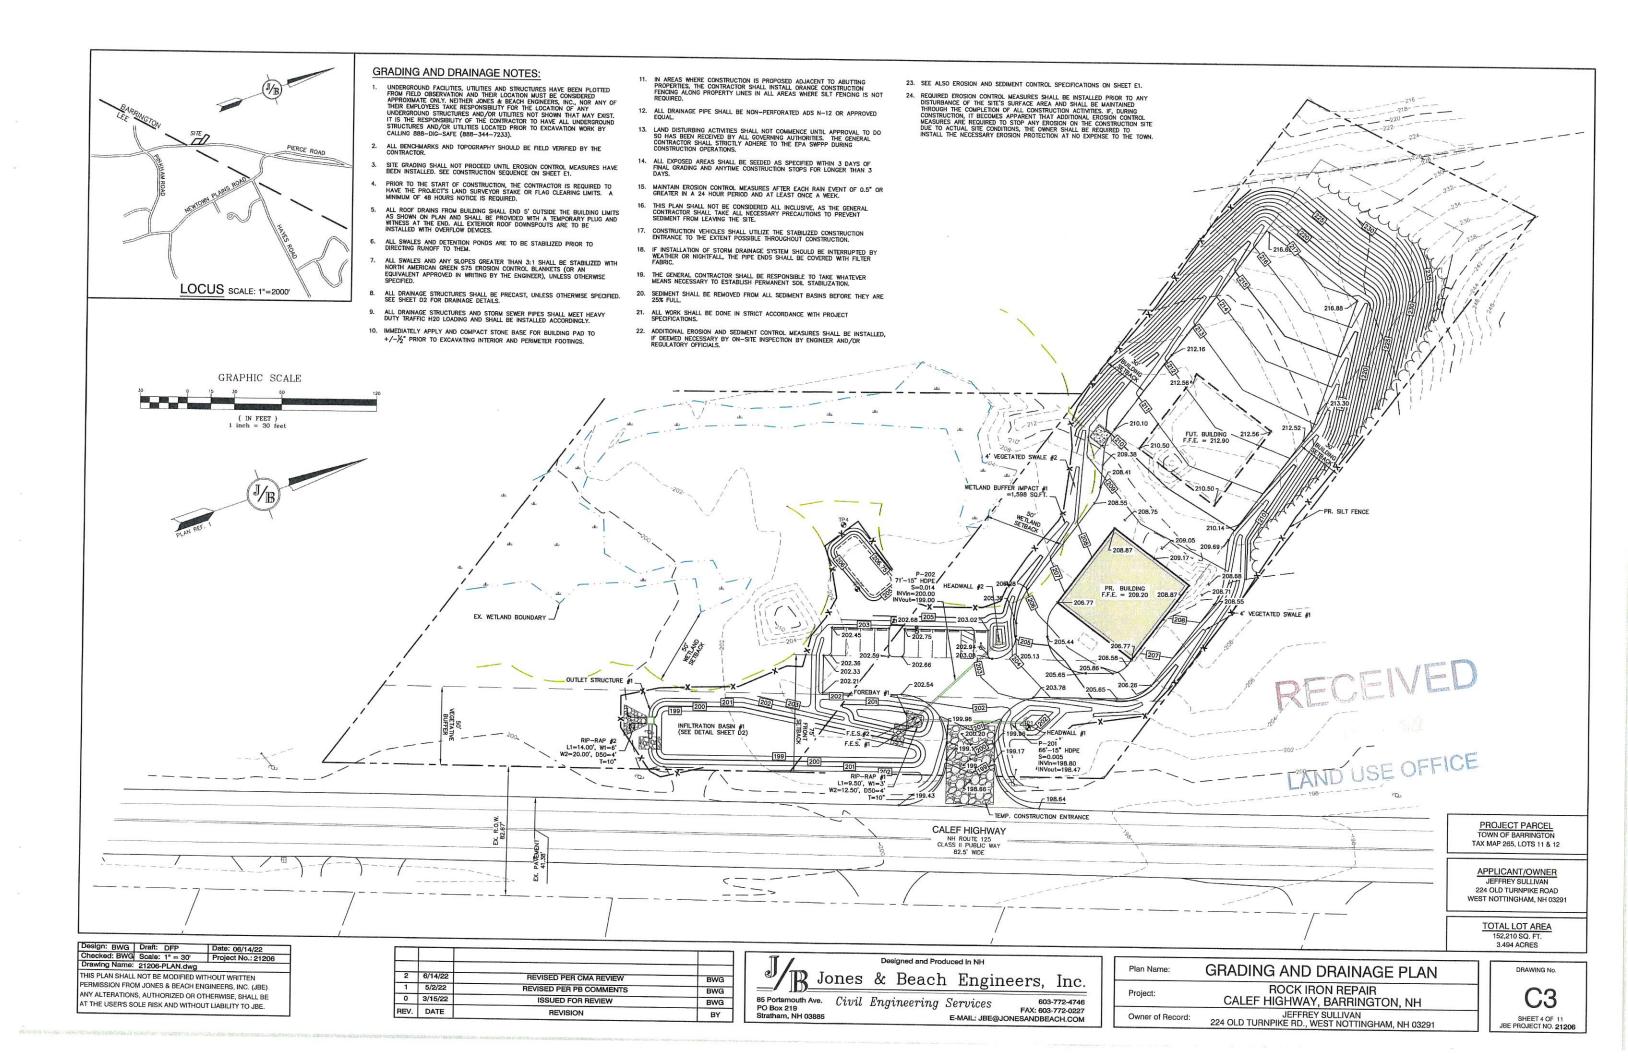

LANDSCAPE NOTES:

- THE CONTRACTOR SHALL LOCATE AND VERIFY THE EXISTENCE OF ALL UTILITIES PRIOR TO STARTING WORK.
- THE CONTRACTOR SHALL SUPPLY ALL PLANT MATERIALS IN QUANTITIES SUFFICIENT TO COMPLETE THE PLANTINGS SHOWN ON THE DRAWNGS.
- PLANTS FURNISHED IN CONTAINERS SHALL HAVE THE ROOTS WELL ESTABLISHED IN THE SOIL MASS AND SHALL HAVE AT LEAST ONE (1) GROWING SEASON. ROOT-BOUND PLANTS OR INADEQUATELY SIZED CONTAINERS TO SUPPORT THE PLANT MAY BE DEEMED UNACCEPTABLE.
- ALL PLANTS SHALL BE WATERED THOROUGHLY TWICE DURING THE FIRST 24—HOUR PERIOD AFTER PLANTING. ALL PLANTS SHALL BE WATERED WEEKLY, OR MORE OFTEN IF NECESSARY, DURING THE FIRST GROWING SEASON.
- ALL LANDSCAPE AREAS TO BE GRASS COMMON TO REGION, EXCEPT FOR INTERIOR LANDSCAPED ISLANDS OR WHERE OTHER PLANT MATERIAL IS SPECIFIED.
- THE CONTRACTOR SHALL REMOVE WEEDS, ROCKS, CONSTRUCTION ITEMS, ETC. FROM ANY LANDSCAPE AREA SO DESIGNATED TO REMAIN, WHETHER ON OR OFF-SITE. GRASS SEED OR PINE BARK MULCH SHALL BE APPLIED AS DEPICTED ON PLANS.
- ALL LANDSCAPING SHALL MEET THE TOWN STANDARDS AND REGULATIONS.
- ALL LANDSCAPED AREAS SHALL HAVE SELECT MATERIALS REMOVED TO A DEPTH OF AT LEAST 9" BELOW FINISH GRADE. THE RESULTING VOID IS TO BE FILLED WITH A MINIMUM OF 9" HIGH-QUALITY SCREENED LOAM AMENDED WITH 3" OF AGED ORGANIC COMPOST.



LIGHTING AND ELECTRICAL NOTES:

- SITE ELECTRICAL CONTRACTOR SHALL COORDINATE LOCATION OF EASEMENTS, UNDERGROUND UTILITIES AND DRAINAGE BEFORE DRILLING POLE BASES.
- CONTRACTOR SHALL INSTALL PROPOSED LIGHT POLES ACCORDING TO TOWN REGULATIONS.
- LIGHTING CONDUIT SHALL BE SCHEDULE 40 PVC, AND SHALL BE INSTALLED IN CONFORMANCE WITH THE NATIONAL ELECTRICAL CODE. CONTRACTOR SHALL PROVIDE EXCAVATION AND BACKFLL.
- ILLUMINATION READINGS SHOWN ARE BASED ON A TOTAL LLF OF 0.75 AT GRADE. ILLUMINATION READINGS SHOWN ARE IN UNITS OF FOOT—CANDLES.
- LIGHTING CALCULATIONS SHOWN ARE NOT A SUBSTITUTE FOR INDEPENDENT ENGINEERING ANALYSIS OF LIGHTING SYSTEM AND SAFETY.
- ALL LIGHTING FIXTURES SHALL BE FULL CUT-OFF DARK-SKY COMPLIANT, UNLESS OTHERWISE NOTED.
- NL INDICATES THAT THIS LUMINAIRE SHALL BE ON A NIGHT LIGHT CIRCUIT. FL INDICATES THAT THIS LUMINAIRE SHALL BE A FLOOD LIGHT FIXTURE. MOUNTING BRACKET FOR THIS FL FIXTURE SHALL BE MOUNTED 25' ABOVE BOTTOM OF POLE BASE FOR ALL LIGHT POLES CLOSEST TO STOREFRONT. THESE DESIGNATIONS INDICATE WHAT PHASE LIGHTS ARE
- THE PROPOSED LIGHTING CALCULATIONS AND DESIGN WAS PERFORMED BY CHARRON, INC., P.O. BOX 4550, MANCHESTER, NH 03108, ATTENTION KEN SWEENEY. ALLIGHTS SHOULD BE PURCHASED FROM THIS COMPANY, OR AN EQUAL LIGHTING DESIGN SHOULD BE SUBMITTED FOR REVIEW IF EQUAL SUBSTITUTIONS ARE PROPOSED BY THE CONTRACTOR OR OWNER.

LANDSCAPE CALCULATIONS:

- PERIMETER SHADE TREE:
 REQUIRED: 1 TIREE / 20' OF PARKING LOT PERIMETER
 PARKING LOT PERIMETER = 290'
 PROVIDED: (1 TREE / 20') X (290') = 14.5 = 15 TREES
- SCREENING FROM PUBLIC ROW: REQUIRED: 50% VERTICAL OPACITY AVERAGE UP TO HEIGHT OF 3.5'
- INTERIOR PARKING LOT LANDSCAPING:

 TOTAL PARKING AREA = 2020 SQ.FT.
 REQUIRED: 10% OF TOTAL PARKING AREA DEDICATED AS LANDSCAPED AREA

 = (1609 SQ.FT.) X (10%) = 160.9 SQ.FT.
 PROVIDED: = 176 SQ.FT.



LIGHTING TABLE:

Luminaire Schedule						
Symbol	Qty	Label	Arrangement	Description		
⊕ □	1	S3	Single	PRV-C25-D-UNV-T3-BZ-HSS / SSS4A20SFN1 (20' AFG)		
	6	W	Single	AXCS2A / WALL MTD 12' AFG		

LANDSCAPING TABLE:

#	SYMBOL	LABEL	COMMON NAME	BOTANICAL NAME	SIZE
1	•	TG	ARBORVITAE	THUJA GREEN GIANT	6'
2	3	AR	RED MAPLE	ACER RUBRUM	3" CAL
3	•	FP	WHITE ASH	FRAXINUS PENNSYLVANICA	3" CAL
4	€	LS	SWEET GUM	LIQUIDAMBAR STYRACIFLUA	3" CAL

PROJECT PARCEL TAX MAP 265, LOTS 11 & 12

APPLICANT/OWNER 224 OLD TURNPIKE ROAD

> TOTAL LOT AREA 152,210 SQ. FT. 3.494 ACRES

Design: BWG	Draft: DFP	Date: 06/14/22
Checked: BWG	Scale: 1" = 30'	Project No.: 21206
Drawing Name:	21206-PLAN.dwg	9
THIS PLAN SHALL	NOT BE MODIFIED	WITHOUT WRITTEN
PERMISSION FRO	M JONES & BEACH	ENGINEERS, INC. (JBE).
ANY ALTERATION	S. AUTHORIZED OF	OTHERWISE, SHALL BE
AT THE USER'S S	OLE BISK AND WITH	OUT LIABILITY TO JBE.

2	6/14/22	REVISED PER CMA REVIEW	BWG
1	5/2/22	REVISED PER PB COMMENTS	BWG
0	3/15/22	ISSUED FOR REVIEW	BWG
REV.	DATE	REVISION	BY




E-MAIL: JBE@JONESANDBEACH.COM


LANDSCAPE AND LIGHTING PLAN Plan Name: **ROCK IRON REPAIR** Project: CALEF HIGHWAY, BARRINGTON, NH


Owner of Record:

JEFFREY SULLIVAN 224 OLD TURNPIKE RD., WEST NOTTINGHAM, NH 03291

SHEET 5 OF11 JBE PROJECT NO. 21206

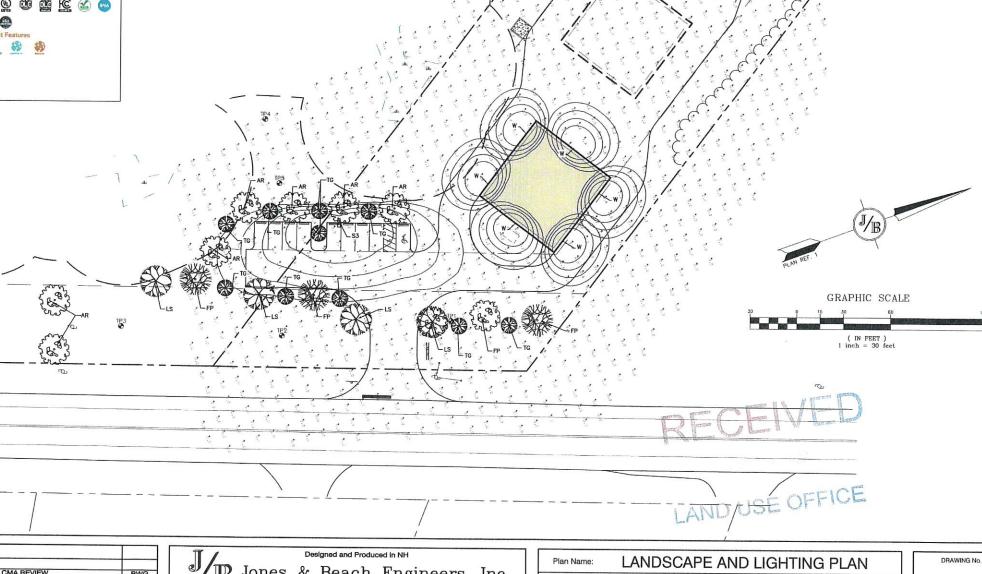

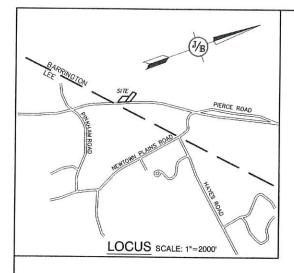

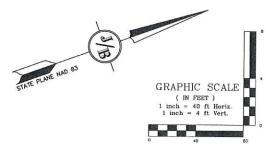



NOTES:

1. SIGNS SHALL BE TO THE MANUAL OF UNIFORM TRAFFIC CONTROL DEVICES (MUTCD) STANDARDS AND NHDOT STANDARDS.

2. SIGN, HARDWARE, AND INSTALLATION TO CONFORM TO 2016 NHDOT STANDARD SPECIFICATIONS, SECTION 615 - TRAFFIC SIGNS.

3. STOP BAR TO CONFORM TO NHDOT PM-9 STOP BAR DETAIL

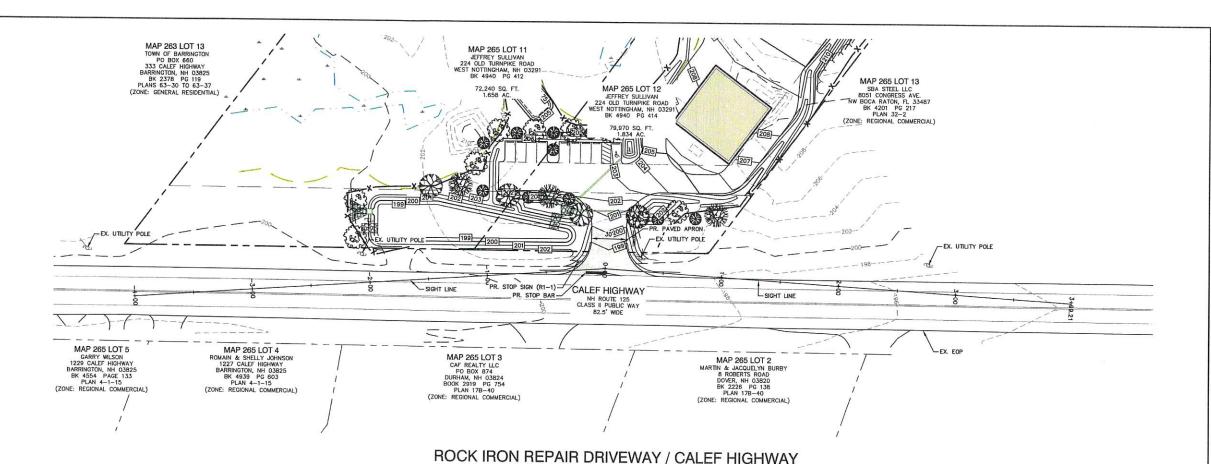

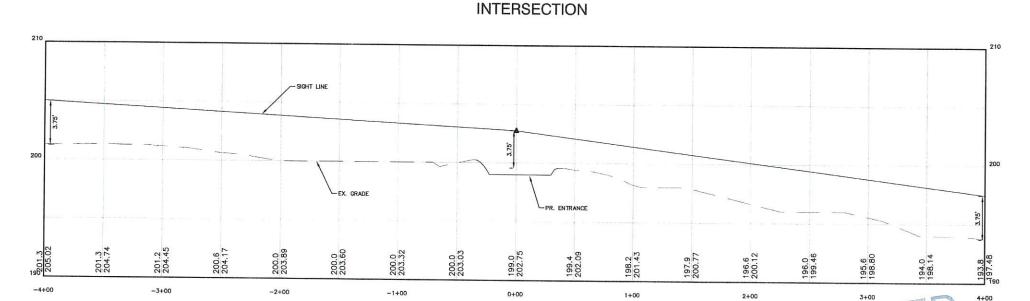

TRAFFIC CONTROL SCHEDULE SIZE OF SIGN WIDTH HEIGHT MOUNT TYPE MOUNT HEIGHT DESCRIPTION REMARKS NUMBER STOP R1-1 30" 30" WHITE ON RED CHANNEL 7'-0" REFLECTORIZED SIGN PROJECT PARCEL TOWN OF BARRINGTON

TAX MAP 265, LOTS 11 & 12

APPLICANT/OWNER
JEFFREY SULLIVAN 224 OLD TURNPIKE ROAD WEST NOTTINGHAM, NH 03291

> TOTAL LOT AREA 152,210 SQ. FT. 3.494 ACRES

Design: BWG Draft: DFP Date: 06/14/22
Checked: BWG Scale: AS NOTED Project No.: 21206
Drawing Name: 21206-PLAN.dwg

THIS PLAN SHALL NOT BE MODIFIED WITHOUT WRITTEN PERMISSION FROM JONES & BEACH ENGINEERS, INC. (JBE). ANY ALTERATIONS, AUTHORIZED OR OTHERWISE, SHALL BE AT THE USER'S SOLE RISK AND WITHOUT LIABILITY TO JBE.


2	6/14/22	REVISED PER CMA REVIEW	BWG
1	5/2/22	REVISED PER PB COMMENTS	BWG
0	3/15/22	ISSUED FOR REVIEW	BWG
REV.	DATE	REVISION	BY


ers,	Inc.
FAX: 603	3-772-4746 3-772-0227
	FAX: 603 SANDBE


Plan Name:	HIGHWAY ACCESS PLAN	
Project:	ROCK IRON REPAIR CALEF HIGHWAY, BARRINGTON, NH	
Owner of Record:	JEFFREY SULLIVAN 224 OLD TURNPIKE RD., WEST NOTTINGHAM, NH 03291	


LAND USE OFFICE


DRAWING No. HA1 SHEET 6 OF 11 JBE PROJECT NO. 21206

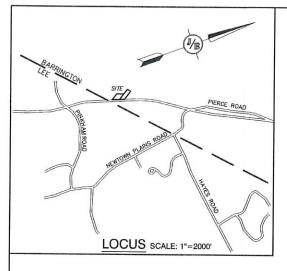


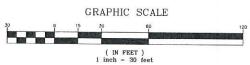

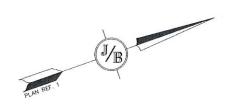

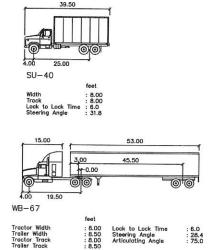

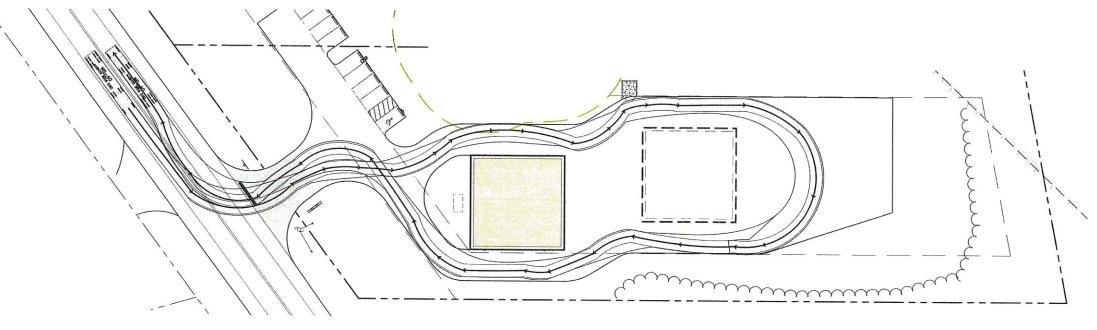

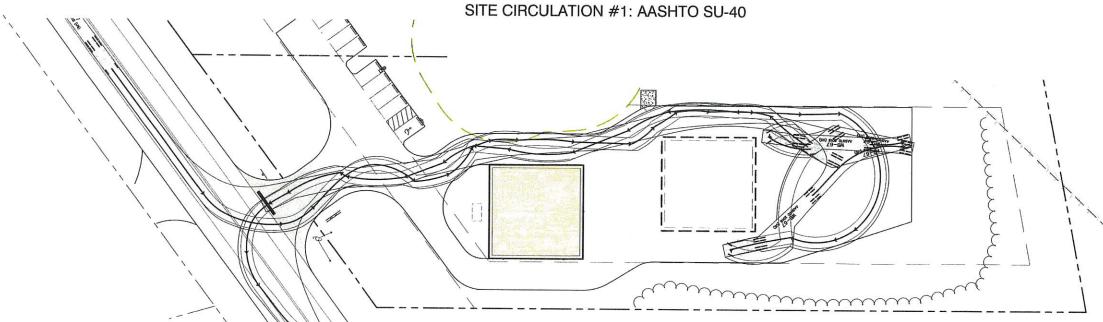

SITE CIRCULATION #2: AASHTO WB-67

APPROVED - BARRINGTON, NH
PLANNING BOARD

DATE: OFFICE

| Design: BWG | Draft: DFP | Date: 06/14/22 |
| Checked: BWG | Scale: 1" = 30' | Project No.: 21206 |
| Drawing Name: 21206-PLAN.dwg | THIS PLAN SHALL NOT BE MODIFIED WITHOUT WRITTEN PERMISSION FROM JONES & BEACH ENGINEERS, INC. (JBE). ANY ALTERATIONS, AUTHORIZED OR OTHERWISE, SHALL BE AT THE USER'S SOLE RISK AND WITHOUT LIABILITY TO JBE.

2	6/14/22	REVISED PER CMA REVIEW	BWG
1	5/2/22	REVISED PER PB COMMENTS	BWG
0	3/15/22	ISSUED FOR REVIEW	BWG
REV.	DATE	REVISION	BY
HEV.	DATE	REVISION	

Designed and Produced in NH B Jones & Beach Engineers, Inc.


B5 Portsmouth Ave. Civil Engineering Services
PO Box 219
Stratham, NH 03885
E-MAIL: JBE@ FAX: 603-772-0227 E-MAIL: JBE@JONESANDBEACH.COM

DATE OFFICE	TOTAL LOT AREA 152,210 SQ. FT. 3.494 ACRES
Plan Name: SITE CIRCULATION PI	LAN DRAWING No.
Project: ROCK IRON REPAIR CALEF HIGHWAY, BARRINGTO	DN, NH TM
Owner of Record: JEFFREY SULLIVAN 224 OLD TURNPIKE RD., WEST NOTTINGHAI	SHEET 7 OF 1 M, NH 03291 SHEET 7 OF 1 JBE PROJECT NO. 2

DRAWING No. TM₁

PROJECT PARCEL TOWN OF BARRINGTON TAX MAP 265, LOTS 11 & 12

APPLICANT/OWNER
JEFFREY SULLWAN
224 OLD TURNPIKE ROAD
WEST NOTTINGHAM, NH 03291

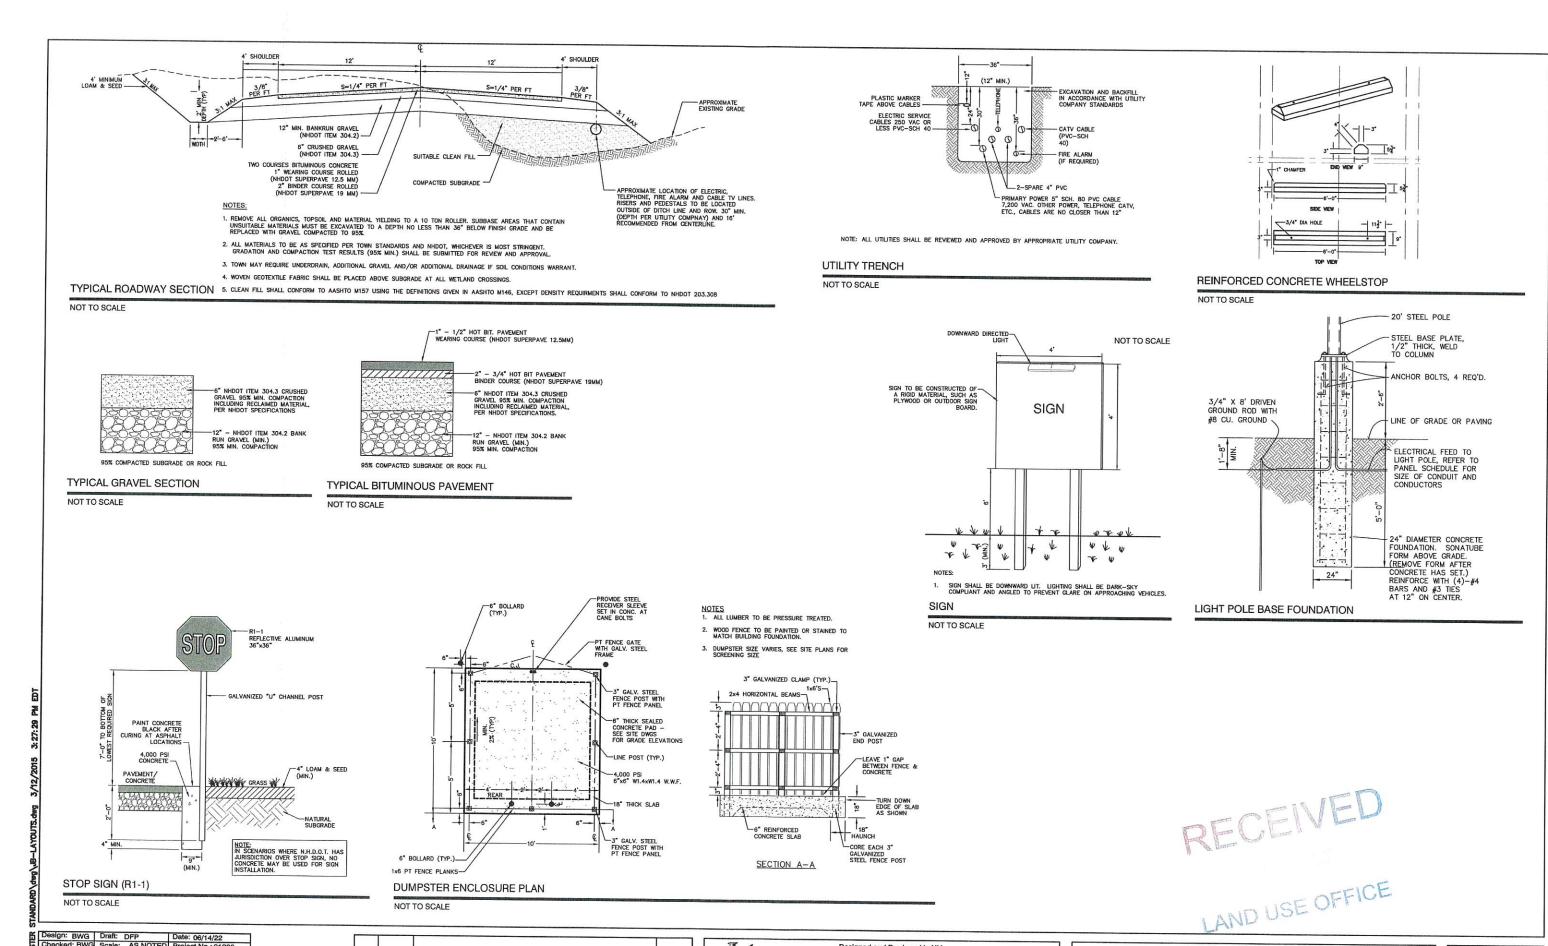

Design: BWG				
Checked: BWG Scale: AS NOTED Project No.: 21206 Drawing Name: 21206-PLAN.dwg	Design: BWG	Draft:	DFP	Date: 06/14/22
THIS PLAN SHALL NOT BE MODIFIED WITHOUT WOLTEN	Checked: BWG	Scale:	AS NOTED	Project No.: 21206
THIS PLAN SHALL NOT BE MODIFIED WITHOUT WOLTEN	Drawing Name:	21206-	PLAN.dwa	
DEDMISSION EDOM JONES & DEAGUENOUSERS AND AREA	THIS PLAN SHALL	NOT BE	MODIEJED WITH	LIOUT MODITIEM
	DEDMISSION EDO	M IONEC	MODIFIED WITH	HOUT WHITEN
	ANY ALTERATION:	S. AUTHO	DRIZED OR OTH	HERWISE SHALL BE

AT THE USER'S SOLE RISK AND WITHOUT LIABILITY TO JBE.

BWG	REVISED PER CMA REVIEW	6/14/22	2
BWG	REVISED PER PB COMMENTS	5/2/22	1
BWG	ISSUED FOR REVIEW	3/15/22	0
BY	REVISION	DATE	REV.

Jones & Beach Engineers, Inc.

B5 Portsmouth Ave. Civil Engineering Services

FAX: 603-772-4746
FAX: 603-772-0227

E-MAIL: JBE@JONESANDBEACH.COM

Stratham, NH 0388


Plan Name: DETAIL SHEET				
Project:	ROCK IRON REPAIR CALEF HIGHWAY, BARRINGTON, NH			
Owner of Record:	JEFFREY SULLIVAN 224 OLD TURNPIKE RD., WEST NOTTINGHAM, NH 03291			

DRAWING No.

D1

SHEET 8 OF 11

JBE PROJECT NO. 21206

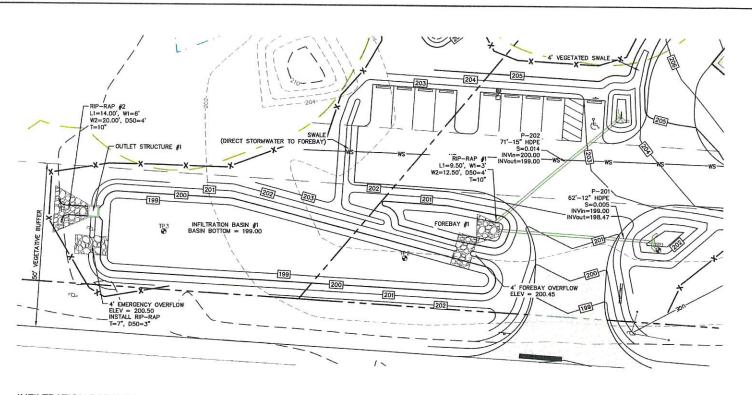

INFILTRATION BASIN #1

SCALE: 1" = 20'


WATERTIGHT ORIFICE PLATE (SEE DETAIL) 4" LOAM AND SEED EMERG. OVERFLOW 3. REMOVE SANDY LAYERS TO 18" BELOW BASIN FLOOR ELEVATION. = 200.50 4 BIO_INCH TRATION AND STOCKPILE (SCREEN LARGE ROOTS). BIO-INFILTRATION MIX (SEE NOTES) RIP RAP -NATIVE SOILS INFILTRATION BASIN #1

BIO-INFILTRATION MIX AND PROCEDURE:

- 1. REMOVE EXISTING FOREST LITTER FROM INFILTRATION BASIN SITE. PROP. BERM 2. REMOVE SANDY LOAM AND STOCKPILE (SCREEN LARGE ROOTS).

 - 4. BIO-INFILITRATION MIX: (BY VOLUME)
 4.1. 50%-55% ASTM C-33 CONCRETE SAND.
 4.2. 20%-50% LOANY SAND TOPSOIL WITH 15%-25% FINES PASSING A #200 SIEVE
 4.3. 20%-30% MODERATELY FINE SHREDDED BARK OR WOOD FIBER MULCH WITH LESS THAN 5% PASSING THE #200 SIEVE.
 - 5. INSTALL TO BIO-INFILTRATION MIX TO BASIN BOTTOM ELEVATION
 - BY NEW ENGLAND WARM SEASON GRASS MIX" AS SOLD
 BY NEW ENGLAND WETLAND PLANTS, INC. OR EQUAL AS
 APPROVED BY ENGINEER. APPLICATION RATE = 1900 SQ.FT. /
 IR APPROVED BY ENGINEER. APPLICATION RATE LB.
 6.1. LIGHTLY MULCH WITH WEED FREE STRAW.


NOT TO SCALE

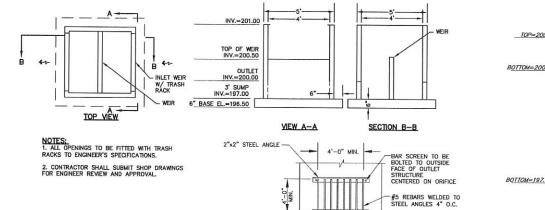


TOP=200.50 0.5' BOTTOM=200.10 BOTTOM=197.00 BAFFLE/WEIR

OUTLET STRUCTURE #1 (OS #1)


NOT TO SCALE

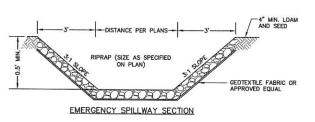

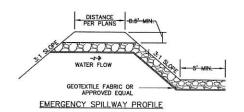

EMERGENCY SPILLWAY

NOT TO SCALE

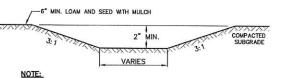


1. STABILIZED PRIOR TO DIRECTING RUN OFF TO SWALE 2. CONSTRUCT SWALE AT 0.005 FT/FT SLOPE (MIN.)

VEGETATED SWALE

NOT TO SCALE

BAR SCREEN DETAIL

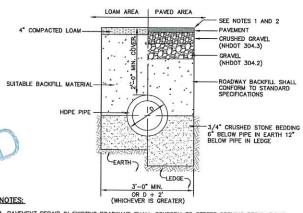

- 1. PAVEMENT REPAIR IN EXISTING ROADWAYS SHALL CONFORM TO STREET OPENING REGULATIONS. 2. NEW ROADWAY CONSTRUCTION SHALL CONFORM WITH PROJECT AND TOWN SPECIFICATIONS.
 3. ALL MATERIALS ARE TO BE COMPACTED TO 95% OF ASTM D-1557.

DRAINAGE TRENCH

NOT TO SCALE

Design: BWG	Draft: DFP	Date: 06/14/22
Checked: BWG	Scale: AS NOTED	Project No.: 21206
Drawing Name:	21206-PLAN.dwg	

E LIZOU I Daviding	
THIS PLAN SHALL NOT BE MODIFIED WITHOUT WRITTEN	
PERMISSION FROM JONES & BEACH ENGINEERS, INC. (JBE)	Ü
ANY ALTERATIONS, AUTHORIZED OR OTHERWISE, SHALL BE	
AT THE USER'S SOLE RISK AND WITHOUT LIADIUTY TO JOE	

2	6/14/22	REVISED PER CMA REVIEW	BWG
1	5/2/22	REVISED PER PB COMMENTS	BWG
0	3/15/22	ISSUED FOR REVIEW	BWG
REV.	DATE	REVISION	BY

Designed and Produced in NH /B Jones & Beach Engineers, Inc.


B5 Portsmouth Ave. Civil Engineering Services
PO Box 219 S'ervices FAX: 603-772-4746 FAX: 603-772-0227 E-MAIL: JBE@JONESANDBEACH.COM Stratham, NH 03885

		-	
Plan Name: DETAIL SHEET			
Project:	ROCK IRON REPAIR CALEF HIGHWAY, BARRINGTON, NH		
Owner of Record:	JEFFREY SULLIVAN 224 OLD TURNPIKE RD., WEST NOTTINGHAM, NH 03291		

DRAWING No. SHEET 9 OF 11 JBE PROJECT NO. 21206

- TEMPORARY EROSION CONTROL NOTES

 1. THE SMALLEST PRACTICAL AREA OF LAND SHALL BE EXPOSED AT ANY ONE TIME. AT NO TIME SHALL AN AREA IN EXCESS OF 5 ACRES BE EXPOSED AT ANY ONE TIME BEFORE DISTURBED AREAS ARE STABILIZED.
- EROSION, SEDIMENT AND DETENTION MEASURES SHALL BE INSTALLED AS SHOWN ON THE PLANS AND AT LOCATIONS AS REQUIRED, DIRECTED BY THE ENGINEER.
- ALL DISTURBED AREAS (INCLUDING POND AREAS BELOW THE PROPOSED WATERLINE) SHALL BE RETURNED TO PROPOSED GRADES AND ELEVATIONS, DISTURBED AREAS SHALL BE LOAMED WITH A MINIMUM OF 6° OF SCREENED ORGANIC LOAM AND SEEDED WITH SEED MIXTURE "C" AT A RATE NOT LESS THAN 1.10 POUNDS OF SEED PER 1,000 S.F. OF AREA (48 LBS. / ACRE).
- SILT FENCES AND OTHER BARRIERS SHALL BE INSPECTED EVERY SEVEN CALENDAR DAYS AND WITHIN 24 HOURS OF A RAINFALL OF 0.5° OR GREATER. ALL DAMAGED AREAS SHALL BE REPAIRED, AND SEDIMENT DEPOSITS SHALL PERIODICALLY BE REMOVED AND DISPOSED OF.
- AFTER ALL DISTURBED AREAS HAVE BEEN STABILIZED, THE TEMPORARY EROSION CONTROL MEASURES SHALL BE REMOVED AND THE AREA DISTURBED BY THE REMOVAL SMOOTHED AND RE-VEGETATED.
- AREAS MUST BE SEEDED AND MULCHED OR OTHERWISE PERMANENTLY STABILIZED WITHIN 3 DAYS OF FINAL GRADING, OR TEMPORARILY STABILIZED WITHIN 14 DAYS OF THE INITIAL DISTURBANCE OF SOIL ALL AREAS SHALL BE STABILIZED WITHIN 45 DAYS OF INITIAL DISTURBANCE.
- ALL PROPOSED VEGETATED AREAS THAT DO NOT EXHIBIT A MINIMUM OF 85 PERCENT VEGETATIVE GROWTH BY OCTOBER 15, OR WHICH ARE DISTURBED AFTER OCTOBER 15, SHALL BE STABILIZED BY SEEDING AND INSTALLING NORTH AMERICAN GREEN S75 REGOISON CONTROL BLANKETS (OR AN EQUIVALENT APPROVED IN WRITING BY THE PIGNIMER?) ON SLOPES GREATER THAN 3-1, AND SEEDING AND PLACING 3 TO 4 TONS OF MULCH PER ACRE, SECURED WITH ANCHORED NETTING, ELSEWHERE. THE INSTALLATION OF EROSION CONTROL BLANKETS OR MULCH AND NETTING SHALL NOT OCCUR OVER ACCUMULATED SNOW OR ON FROZEN GROUND AND SHALL BE COMPLETED IN ADVANCE OF THAW OR SPRING MELT EVENTS.
- ALL DITCHES OR SWALES WHICH DO NOT EXHIBIT A MINIMUM OF 85 PERCENT VEGETATIVE GROWTH BY OCTOBER 15, OR WHICH ARE DISTURBED AFTER OCTOBER 15, SHALL BE STABILIZED TEMPORARILY WITH STONE OR EROSION CONTROL BLANKETS APPROPRIATE FOR THE DESIGN FLOW CONDITIONS.
- AFTER OCTOBER 15th, INCOMPLETE ROAD OR PARKING SURFACES, WHERE WORK HAS STOPPED FOR THE WINTER SEASON, SHALL BE PROTECTED WITH A MINIMUM OF 3" OF CRUSHED GRAVEL PER NHDOT ITEM 304.3.
- 10. AN AREA SHALL BE CONSIDERED STABLE IF ONE OF THE FOLLOWING HAS OCCURRED:
 - BASE COURSE GRAVELS HAVE BEEN INSTALLED IN AREAS TO BE PAVED;
 - b. A MINIMUM OF 85% VEGETATED GROWTH HAS BEEN ESTABLISHED:
 - c. A MINIMUM OF 3" OF NON-EROSIVE MATERIAL SUCH STONE OR RIPRAP HAS BEEN INSTALLED; OR
 - d. EROSION CONTROL BLANKETS HAVE BEEN PROPERLY INSTALLED.
- FUGITIVE DUST CONTROL IS REQUIRED TO BE CONTROLLED IN ACCORDANCE WITH ENV-A 1000, AND THE PROJECT IS TO MEET THE REQUIREMENTS AND INTENT OF RSA 430:53 AND AGR 3800 RELATIVE TO INVASIVE SPECIES.
- 12. PRIOR TO BEGINNING CONSTRUCTION, THE CONTRACTOR'S NAME, ADDRESS, AND PHONE NUMBER SHALL BE SUBMITTED TO DES
- 13. PRIOR TO CONSTRUCTION, A PHASING PLAN THAT DELINEATES EACH PHASE OF THE PROJECT SHALL BE SUBMITTED. ALL TEMPORARY SEDIMENT BASINS THAT WILL BE NEEDED FOR DEWATERING WORK AREAS SHALL BE LOCATED AND IDENTIFIED ON THIS
- IN ORDER TO ENSURE THE STABILITY OF THE SITE AND EFFECTIVE IMPLEMENTATION OF THE SEDIMENT AND EROSION CONTR MEASURES SPECIFIED IN THE PLANS FOR THE DURATION OF CONSTRUCTION, THE CONTRACTOR SHALL BE IN STRICT COMB WITH THE FOLLOWING INSPECTION AND MAINTENANCE REQUIREMENTS IN ADDITION TO THOSE CALLED FOR IN THE SWPPP:
 - a. A CERTIFIED PROFESSIONAL IN EROSION AND SEDIMENT CONTROL <u>OR</u> A PROFESSIONAL ENGINEER LICENSED IN THE STATE OF NEW HAMPSHIRE ("MONITOR") SHALL BE EMPLOYED TO INSPECT THE SITE FROM THE START OF ALTERATION OF TERRAIN ACTIVITIES UNTIL THE SITE IS IN FULL COMPLIANCE WITH THE SITE SPECIFIC PERMIT ("PERMIT").
 - DURING THIS PERIOD, THE MONITOR SHALL INSPECT THE SUBJECT SITE AT LEAST ONCE A WEEK, AND IF POSSIBLE, DURING ANY 1/2 INCH OR GREATER RAIN EVENT (I.E. 1/2 INCH OF PRECIPITATION OR MORE WITHIN A 24 HOUR PERIOD). IF UNABLE TO BE PRESENT DURING SUCH A STORM, THE MONITOR SHALL INSPECT THE SITE WITHIN 24 HOURS OF THIS EVENT.
 - THE MONITOR SHALL PROVIDE TECHNICAL ASSISTANCE AND RECOMMENDATIONS TO THE CONTRACTOR ON THE APPROPRIATE BEST MANAGEMENT PRACTICES FOR EROSION AND SEDIMENT CONTROLS REQUIRED TO MEET THE REQUIREDNESS OF FSA 455 £-17

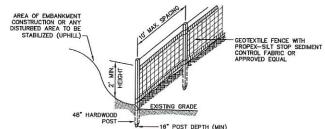


- WOVEN FABRIC FENCE TO BE FASTENED SECURELY TO FENCE POSTS WITH WIRE ITES OR STAPLES. FILTER CLOTH SHALL BE FASTEND TO WOVEN WIRE EVERY 24" AT TOP, MID AND BOTTOM AND EMBEDDED IN THE GROUND A MINIMUM OF 8" AND THEN COVERED WITH SOIL.
- THE FENCE POSTS SHALL BE A MINIMUM OF 48" LONG, SPACED A MAXIMUM 10' APART, AND DRIVEN A MINIMUM OF 16" INTO THE GROUND.
- WHEN TWO SECTIONS OF FILTER CLOTH ADJOIN EACH OTHER, THE ENDS OF THE FABRIC SHALL BE OVERLAPPED 6", FOLDED AND STAPLED TO PREVENT SEDIMENT FROM BY-PASSING.
- 4. MAINTENANCE SHALL BE PERFORMED AS NEEDED AND SEDIMENT REMOVED AND PROPERLY DISPOSED OF WHEN IT IS 6" DEEP OR VISIBLE 'BULGES' DEVELOP IN THE SILT FENCE.
- 5. PLACE THE ENDS OF THE SILT FENCE UP CONTOUR TO PROVIDE FOR SEDIMENT STORAGE.
- 6. SILT FENCE SHALL REMAIN IN PLACE FOR 24 MONTHS.

SILT FENCE

NOT TO SCALE

Design: BWG Draft: DFP Date: 06/14/22 Checked: BWG Scale: AS NOTED Project No.: 21206 Drawling Name: 21206-PLAN.dwg PERMISSION FROM JONES & BEACH ENGINEERS, INC. (JBE) ANY ALTERATIONS, AUTHORIZED OR OTHERWISE, SHALL BE

AT THE USER'S SOLE RISK AND WITHOUT LIABILITY TO JBE

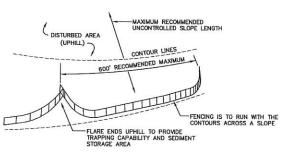

7. SILT FENCES SHALL BE REMOVED WHEN NO LONGER NEEDED AND THE SEDIMENT COLLECTED SHALL BE DISPOSED AS DIRECTED BY THE ENGINEER. THE AREA DISTURBED BY THE REMOVAL SHALL BE SMOOTHER AND REVEGETATED.

2 6/14/22

1 5/2/22

0 3/15/22

REV. DATE

- SILT FENCES SHALL BE INSPECTED IMMEDIATELY AFTER EACH RAINFALL AND AT LEAST DAILY DURING PROLONGED RAINFALL. ANY REPAIRS THAT ARE REQUIRED SHALL BE DONE IMMEDIATELY.
- IF THE FABRIC ON A SILT FENCE SHOULD DECOMPOSE OR BECOME INEFFECTIVE DURING THE EXPECTED LIFE OF THE FENCE, THE FABRIC SHALL BE REPLACED PROMPTLY.
- SEDIMENT DEPOSITS SHOULD BE INSPECTED AFTER EVERY STORM EVENT. THE DEPOSITS SHOULD BE REMOVED WHEN THEY REACH APPROXIMATELY ONE HALF THE HEIGHT OF THE BARRIER.

REVISED PER CMA REVIEW

REVISED PER PB COMMENTS

ISSUED FOR REVIEW

REVISION

SEEDING SPECIFICATIONS

- GRADING AND SHAPING

 A. SLOPES SHALL NOT BE STEEPER THAN 2:1 WITHOUT APPROPRIATE EROSION CONTROL MEASURES AS
- SPECIFIED ON THE PLANS (3:1 SLOPES OR FLATTER ARE PREFERRED).

 B. WHERE MOWING WILL BE DONE, 3:1 SLOPES OR FLATTER ARE RECOMMENDED.

- SEEDBED PREPARATION
 A. SURFACE AND SEEPAGE WATER SHOULD BE DRAINED OR DIVERTED FROM THE SITE TO PREVENT DROWNING OR WINTER KILLING OF THE PLANTS.
 B. STONES LARGER THAN 4 INCHES AND TRASH SHOULD BE REMOVED BECAUSE THEY INTERFERE WITH SEEDING AND FUTURE MAINTENANCE OF THE AREA. WHERE FEASIBLE, THE SOIL SHOULD BE TILLED TO A DEPTH OF ABOUT 4 INCHES TO PREPARE A SEEDBED AND FERTILIZER AND LIME MIXED INTO THE SOIL. THE SEEDBED SHOULD BE LEFT IN A REASONABLY FIRM AND SMOOTH CONDITION. THE LAST TILLAGE OPERATION SHOULD BE PERFORMED ACROSS THE SLOPE WHEREVER PRACTICAL.

- 3. <u>Establishing a Stand</u>

 A. Lime and Fertilizer should be applied prior to or at the time of seeding and incorporated into the soil types and amounts of lime and Fertilizer should be based on an evaluation of soil tests. When a soil test is not available, the following minimum amounts should be applied:
 - APPLIED: AGRICULTURAL LIMESTONE, 2 TONS PER ACRE OR 100 LBS. PER 1,000 SQ.FT. NITROGEN(N), 50 LBS. PER ACRE OR 1.1 LBS. PER 1,000 SQ.FT.
 PHOSPHATE(P205), 100 LBS. PER ACRE OR 2.2 LBS. PER 1,000 SQ.FT.
 POTASH(K20), 100 LBS. PER ACRE OR 2.2 LBS. PER 1,000 SQ.FT.
 (NOTE: THIS IS THE EQUIVALENT OF 500 LBS. PER ACRE OF 10-20-20 FERTILIZER OR 1,000 LBS. PER
- ACRE OF 5-10-10)

 B. SEED SHOULD BE SPREAD UNIFORMLY BY THE METHOD MOST APPROPRIATE FOR THE SITE. METHODS INCLUDE BROADCASTING, DRILLING AND HYDROSEEDING, WHERE BROADCASTING IS USED, COVER SEED WITH .25 INCH OF SOIL OR LESS, BY CULTIPACKING OR RAKING.
- Z. BINCH OF SOIL OR LESS, BY COLLIP/SCONIG OR RAKING.

 C. REFER TO THE 'SEEDING GUIDE' AND 'SEEDING RATES' TABLES ON THIS SHEET FOR APPROPRIATE SEED MIXTURES AND RATES OF SEEDING. ALL LEGUMES (CROWN/ETCH, BIRDSFOOT, TREFOIL AND FLATPEA) MUST BE INCOLLATED WITH THEIR SPECIFIC INCOLLANT PRIOR TO THEIR INITRODUCTION TO THE SITE.

 D. WHEN SEEDED AREAS ARE MULCHED, PLANTINGS MAY BE MADE FROM EARLY SPRING TO EARLY OCTOBER. WHEN SEEDED AREAS ARE NOT MULCHED, PLANTINGS SHOULD BE MADE FROM EARLY SPRING TO MAY 20th OR FROM AUGUST 10th TO SEPTEMBER 1at.

MULCH
 A. HAY, STRAW, OR OTHER MULCH, WHEN NEEDED, SHOULD BE APPLIED IMMEDIATELY AFTER SEEDING.
 B. MULCH WILL BE HELD IN PLACE USING APPROPRIATE TECHNIQUES FROM THE BEST MANAGEMENT PRACTICE FOR MULCHING. HAY OR STRAW MULCH SHALL BE PLACED AT A RATE OF 90 LBS PER 1000 S.F.

- 5. MAINTENANCE TO ESTABLISH A STAND

 A. PLANTED AREAS SHOULD BE PROTECTED FROM DAMAGE BY FIRE, GRAZING, TRAFFIC, AND DENSE WEED
- GROWTH.
 FERTILIZATION NEEDS SHOULD BE DETERMINED BY ONSITE INSPECTIONS. SUPPLEMENTAL FERTILIZER IS
 USUALLY THE KEY TO FULLY COMPLETE THE ESTABLISHMENT OF THE STAND BECAUSE MOST PERENNIALS
 TAKE 2 TO 3 YEARS TO BECOME FULLY ESTABLISHED.

 TAKE 2 TO 3 YEARS TO BECOME FULLY ESTABLISHED.
- C. IN WATERWAYS, CHANNELS, OR SWALES WHERE UNIFORM FLOW CONDITIONS ARE ANTICIPATED, ANNUAL MOWING MAY BE NECESSARY TO CONTROL GROWTH OF WOODY VEGETATION.

USE	SEEDING MIXTURE 1/	DROUGHTY	WELL DRAINED	MODERATELY WELL DRAINED	POORLY DRAINED
STEEP CUTS AND	Α	FAIR	GOOD	GOOD	FAIR
FILLS, BORROW	В	POOR	GOOD	FAIR	FAIR
AND DISPOSAL AREAS	С	POOR	GOOD	EXCELLENT	GOOD
	D	FAIR	EXCELLENT	EXCELLENT	POOR
WATERWAYS, EMERGENC	Y A	GOOD	GOOD	GOOD	FAIR
SPILLWAYS, AND OTHER CHANNELS WITH FLOWING WATER.	С	GOOD	EXCELLENT	EXCELLENT	FAIR
LIGHTLY USED PARKING	A	GOOD	GOOD	GOOD	FAIR
LOTS, ODD AREAS,	В	GOOD	GOOD	FAIR	POOR
UNUSED LANDS, AND LOW INTENSITY USE RECREATION SITES.	С	GOOD	EXCELLENT	EXCELLENT	FAIR
PLAY AREAS AND	E	FAIR	EXCELLENT	EXCELLENT	2/
ATHLETIC FIELDS. (TOPSOIL IS ESSENTIAL FOR GOOD TURF.)	E	FAIR	EXCELLENT	EXCELLENT	2/


GRAVEL PIT, SEE NH-PM-24 IN APPENDIX FOR RECOMMENDATION REGARDING RECLAMATION OF SAND AND GRAVEL PITS.

- $1\!\!/$ refer to seeding mixtures and rates in Table Below. $2\!\!/$ Poorly drained soils are not desirable for use as playing area and athletic fields.
- NOTE: TEMPORARY SEED MIX FOR STABILIZATION OF TURF SHALL BE WINTER RYE OR OATS AT A RATE OF 2.5 LBS. PER 1000 S.F. AND SHALL BE PLACED PRIOR TO OCTOBER 15th, IF PERMANENT SEEDING NOT STEED OF THE PRIOR OF THE PRIO

SEEDING GUIDE

MIXTURE	POUNDS PER ACRE	POUNDS PER 1.000 Sq. Ft
A. TALL FESCUE	20	0.45
CREEPING RED FESCUE	20	0.45
RED TOP	_2_	0.05
TOTAL	42	0.95
B. TALL FESCUE	15	0.35
CREEPING RED FESCUE	10	0.25
CROWN VETCH OR	15	0.35
FLAT PEA	30	0.75
TOTAL	40 OR 55	0.95 OR 1.35
C. TALL FESCUE	20	0.45
CREEPING RED FESCUE	20	0.45
BIRDS FOOT TREFOIL	_8_	0.20
TOTAL	48	1.10
D. TALL FESCUE	20	0.45
FLAT PEA	30	0.75
TOTAL	50	1.20
E. CREEPING RED FESCUE 1/	50	1.15
KENTUCKY BLUEGRASS 1/	50	1.15
TOTAL	100	2.30
F. TALL FESCUE 1	150	3.60
1/FOR HEAVY USE ATHLETIC FIEL NEW HAMPSHIRE COOPERATIVE EX CURRENT VARIETIES AND SEEDING	TENSION TURF SPE	UNIVERSITY OF CIALIST FOR

SEEDING RATES

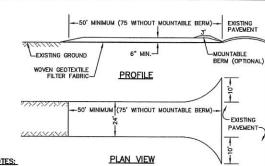

- STONE FOR STABILIZED CONSTRUCTION ENTRANCE SHALL BE 3 INCH STONE, RECLAIMED STONE, OR RECYCLED CONCRETE EQUIVALENT.
- THE LENGTH OF THE STABILIZED ENTRANCE SHALL NOT BE LESS THAN 50 FEET, 75' WITHOUT A MOUNTABLE BERM, AND EXCEPT FOR A SINGLE RESIDENTIAL LOT WHERE A 30 FOOT MINIMUM LENGTH

- MOUNTABLE BERM, AND EXCEPT FOR A SINGLE RESIDENTIAL LOT WHERE A 30 FOOT MINIMUM LENGTH WOULD APPLY.

 3. HICKNESS OF THE STONE FOR THE STABILIZED ENTRANCE SHALL NOT BE LESS THAN 6 INCHES.

 4. THE WIDTH OF THE ENTRANCE SHALL NOT BE LESS THAN THE FULL WIDTH OF THE ENTRANCE WHERE INGRESS OR EGRESS OCCURS, OR 10 FEET, WHICHEVER IS GREATER.

 5. GEOTENTILE FILTER FABRIC SHALL BE PLACED OVER THE ENTRE AREA PRIOR TO PLACING THE STONE.

 FILTER FABRIC IS NOT REQUIRED FOR A SINGLE FAMILY RESIDENTIAL LOT.

 6. ALL SURFACE WATER THAT IS FLOWING TO OR DIVERTED TOWARD THE CONSTRUCTION ENTRANCE SHALL BE PIPED BENEATH THE ENTRANCE. IF PIPING IS IMPRACTICAL, A STONE BERM WITH 5:1 SLOPES THAT CAN BE CROSSED BY VEHICLES MAY BE SUBSTITUTED FOR THE PIPE.

 7. THE ENTRANCE SHALL BE MAINTAINED IN A CONDITION THAT WILL PREVENT TRACKING OR FLOWING OF SEDIMENT ONTO THE PUBLIC RIGHT-OF—WAY. THIS MAY REQUIRE PERIODIC TOP DRESSING WITH ADDITIONAL STONE AS CONDITIONS DEMAND AND REPAIR AND/OR CLEAN OUT OF ANY MEASURES USED TO TRAP SEDIMENT. ALL SEDIMENT SPILLED, WASHED, OR TRACKED ONTO THE PUBLIC RIGHT-OF—WAY MUST BE REMOVED PROMPTLY.

STABILIZED CONSTRUCTION ENTRANCE

NOT TO SCALE

CONSTRUCTION SEQUENCE

- PRIOR TO THE START OF ANY ACTIVITY, IT IS THE RESPONSIBILITY OF THE SITE'S SITE DEVELOPER (OR OWNER) TO FILE A NOTICE OF INTENT (NOI) FORM WITH THE ENVIRONMENTAL PROTECTION AGENCY (EPA) IN ORDER TO GAIN COVERAGE UNDER THE NPDES GENERAL PERMIT FOR STORM WATER DISCHARGES FROM CONSTRUCTION ACTIVITIES. A PRE CONSTRUCTION MEETING IS TO BE HELD WITH ALL DEPARTMENT HEADS PRIOR TO THE START OF CONSTRUCTION.
- WETLAND BOUNDARIES ARE TO BE CLEARLY MARKED PRIOR TO THE START OF CONSTRUCTION.
- 3. CUT AND REMOVE TREES IN CONSTRUCTION AREA AS REQUIRED OR DIRECTED.
- INSTALL SILT FENCING, HAY BALES AND CONSTRUCTION ENTRANCES PRIOR TO THE START OF CONSTRUCTION. THESE ARE TO BE MAINTAINED UNTIL THE FINAL PAVEMENT SURFACING AND LANDSCAPING AREAS ARE ESTABLISHED.
- 5. CLEAR, CUT, GRUB AND DISPOSE OF DEBRIS IN APPROVED FACILITIES.
- CONSTRUCT AND/OR INSTALL TEMPORARY OR PERMANENT SEDIMENT AND/OR DETENTION BASIN(S) AS REQUIRED. THESE FACILITIES SHALL BE INSTALLED AND STABILIZED PRIOR TO DIRECTING RUN-OFF TO THEM.
- STRIP LOAM AND STOCKPILE EXCESS MATERIAL STABILIZE STOCKPILE AS NECESSARY
- PREPARE BUILDING PAD(S) TO ENABLE BUILDING CONSTRUCTION TO BEGIN.
- INSTALL THE SEWER AND DRAINAGE SYSTEMS FIRST, THEN ANY OTHER UTILITIES IN ACCORDANCE WITH THE PLAN AND DETAILS. ANY
 CONFLICTS BETWEEN UTILITIES ARE TO BE RESOLVED WITH THE INVOLVEMENT AND APPROVAL OF THE ENGINEER.
- 11. ALL SWALES AND DRAINAGE STRUCTURES ARE TO BE CONSTRUCTED AND STABILIZED PRIOR TO HAVING RUN-OFF DIRECTED TO THEM.
- 12. DAILY, OR AS REQUIRED, CONSTRUCT TEMPORARY BERMS, DRAINAGE DITCHES, CHECK DAMS, SEDIMENT TRAPS, ETC., TO PREVENT EROSION ON THE SITE AND PREVENT ANY SILTATION OF ABUTTING WATERS AND/OR PROPERTY.
- 14. PERFORM ALL REMAINING SITE CONSTRUCTION (i.e. BUILDING, UTILITY CONNECTIONS, ETC.).
- LOAM AND SEED ALL DISTURBED AREAS AND INSTALL ANY REQUIRED SEDIMENT AND EROSION CONTROL FACILITIES (I.e. RIP RAP, EROSION CONTROL BLANKETS, ETC.).
- 16. ALL ROADWAYS AND PARKING LOTS SHALL BE STABILIZED WITHIN 72 HOURS OF ACHIEVING FINISHED GRADE.
- 17. ALL CUT AND FILL SLOPES SHALL BE SEEDED/LOAMED WITHIN 72 HOURS OF ACHIEVING FINISHED GRADE.
- 18. COMPLETE PERMANENT SEEDING AND LANDSCAPIN
- REMOVE TEMPORARY EROSION CONTROL MEASURES, AFTER SEEDING AREAS HAVE BEEN 75%-85% ESTABLISHED AND SITE IMPROVEMENTS ARE COMPLETE. SMOOTH AND RE-VEGETATE ALL DISTURBED AREAS.
- 20. CLEAN SITE AND ALL DRAINAGE STRUCTURES, PIPES AND SUMPS OF ALL SILT AND DEBRIS.
- 21. ALL EROSION CONTROLS SHALL BE INSPECTED WEEKLY AND AFTER EVERY HALF-INCH OF RAINFALL.
- 22. UPON COMPLETION OF CONSTRUCTION, IT IS THE RESPONSIBILITY OF THE CONTRACTOR TO NOTIFY ANY RELEVANT PERMITTING AGENCIES THAT THE CONSTRUCTION HAS BEEN FINISHED IN A SATISFACTORY MAINER.



Plan Name: EROSION AND SEDIMENT CONTROL DETAILS

Owner of Record:

Project:

ROCK IRON REPAIR CALEF HIGHWAY, BARRINGTON, NH JEFFREY SULLIVAN 224 OLD TURNPIKE RD., WEST NOTTINGHAM, NH 03291

SHEET 10 OF 11 JBE PROJECT NO. 21206

Jones & Beach Engineers, Inc. 85 Portsmouth Ave.

PO Box 219

BWG

BWG

BY

Civil Engineering Services

FAX: 603-772-0227 E-MAIL: JBE@JONESANDBEACH.COM

