COMMERCIAL SITE PLAN "ROCK IRON REPAIR" TAX MAP 265, LOT 11 & 12 CALEF HIGHWAY, BARRINGTON, NH

SHEET INDEX

CS **COVER SHEET**

C1 EXISTING CONDITIONS PLAN


C2 SITE PLAN

СЗ GRADING AND DRAINAGE PLAN

HA1 HIGHWAY ACCESS PLAN

D1-D2 DETAIL SHEETS

EROSION AND SEDIMENT CONTROL DETAILS

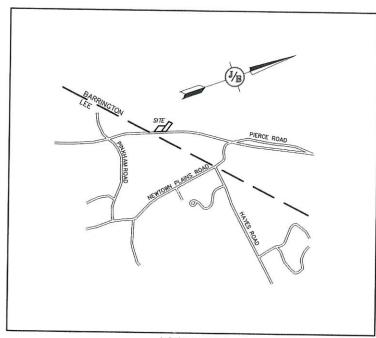

LOCUS MAP SCALE 1" = 2000'

TYPE OF PERMIT

STATUS

NEW HAMPSHIRE DEPARTMENT OF TRANSPORTATION, DISTRICT SIX

SUBMITTED: PERMIT NO.

P.O. BOX 740 DURHAM, NEW HAI (603) 868-1133

DATED:

RESPONSIBLE CONSULTANT-

EXPIRATION:

BARRINGTON SITE PLAN APPROVAL:
TOWN OF BARRINGTON PLANNING BOARD 333 CALEF HIGHWAY

SUBMITTED: PERMIT NO.

BARRINGTON, NEW HAMPSHIRE 03825 RESPONSIBLE CONSULTANT:

DATED:

JONES & BEACH ENGINEERS, INC. EXPIRATION USEPA NPDES PHASE II CONSTRUCTION GENERAL PERMIT, NOTICE OF INTENT (NOI), AND NOTICE OF TERMINATION

(NOT) TO BE FILED IN ACCORDANCE WITH FEDERAL AND LOCAL REGULATIONS PRIOR TO AND FOLLOWING CONSTRUCTION: EPA STORMWATER NOTICE PROCESSING CENTER MAIL CODE 4203M.

1200 PENNSYLVANIA AVENUE, NW WASHINGTON, DC 20460 JONES & BEACH ENGINEERS, INC.

OWNER: JEFFREY SULLIVAN

APPLICANT / DEVELOPER

JEFFREY SULLIVAN P.O. BOX 144 224 OLD TURNPIKE ROAD WEST NOTTINGHAM, NH 03291 (603) 817-1030 EMAIL: ROCKIRONREPAIR@YAHOO.COM

CIVIL ENGINEER / SURVEYOR JONES & BEACH ENGINEERS, INC. 85 PORTSMOUTH AVENUE PO BOX 219 STRATHAM, NH 03885 (603) 772-4746 CONTACT: BARRY GIER

EMAIL: BGIER@JONESANDBEACH.COM

OWNER OF RECORD

JEFFREY SULLIVAN P.O. BOX 144 224 OLD TURNPIKE ROAD WEST NOTTINGHAM, NH 03291 (603)-817-1030 EMAIL: ROCKIRONREPAIR@YAHOO.COM

WETLAND CONSULTANT GOVE ENVIRONMENTAL SERVICES, INC. 8 CONTINENTAL DR. BLDG 2, UNIT H EXETER, NH 03833 (603)-778-0644

APPLICANT/OWNER
JEFFREY SULLIVAN
224 OLD TURNPIKE ROAD WEST NOTTINGHAM, NH 032

PROJECT PARCEL

TAX MAP 265, LOTS 11 & 12

TOTAL LOT AREA

APPROVED - BARRINGTON, NH PLANNING BOARD

LAND USE OFFICE

DATE:


	Design: BWG Dram:		Date: 03/15/22				
2	Checked: BWG Scale:	AS NOTED	Project No.: 21206				
	Drawing Name: 21206-F	PLAN.dwg					
8	THIS PLAN SHALL NOT BE	MODIFIED WITH	HOUT WRITTEN				
9	PERMISSION FROM JONES & REACH ENGINEEDS INC. (IDE)						
ッ	ANY ALTERATIONS, AUTHO	RIZED OR OTH	IERWISE SHALL BE				
ij.	AT THE USER'S SOLE RISK	AND WITHOUT	LIABILITY TO JBE.				


0	3/15/22	ISSUED FOR REVIEW	BWG
REV.	DATE	REVISION	BY


Jones & Beach Engineers, Inc. 85 Portsmouth Ave. Civil Engineering Services FAX: 603-772-0227


E-MAIL: JBE@JONESANDBEACH.COM


Plan Name:	COVER SHEET
Project:	ROCK IRON REPAIR CALEF HIGHWAY, BARRINGTON, NH
Owner of Record:	JEFFREY SULLIVAN 224 OLD TURNPIKE RD. WEST NOTTINGHAM NIL 02201

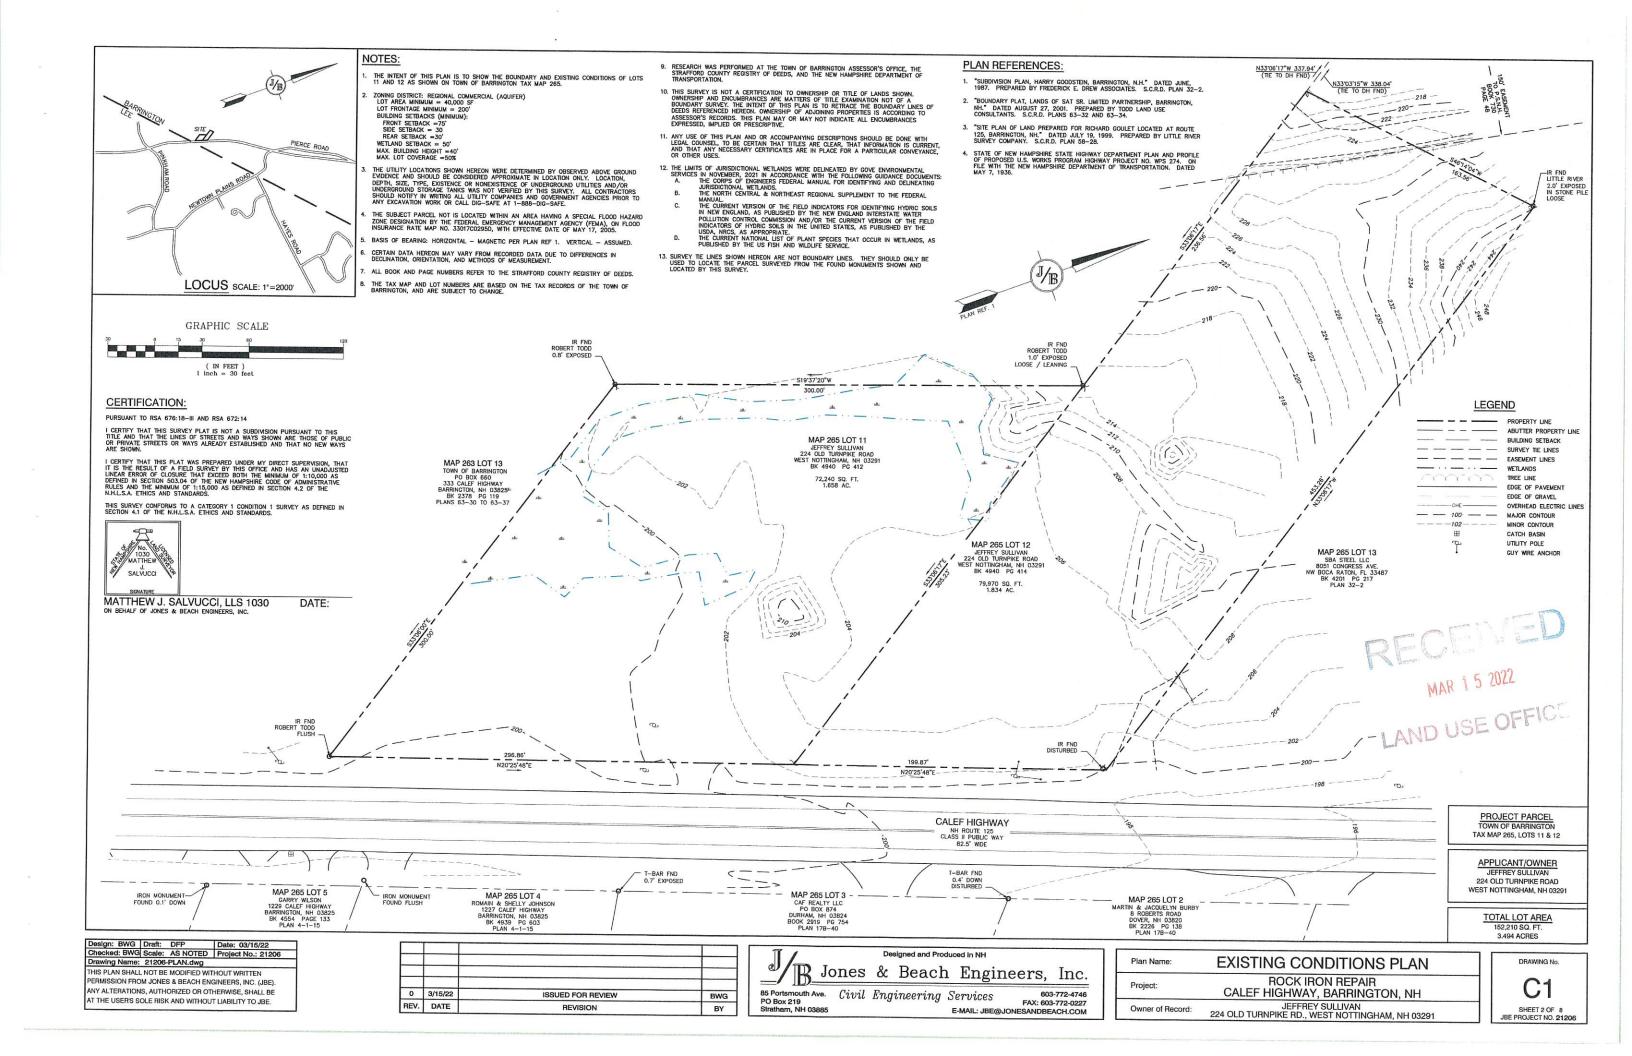

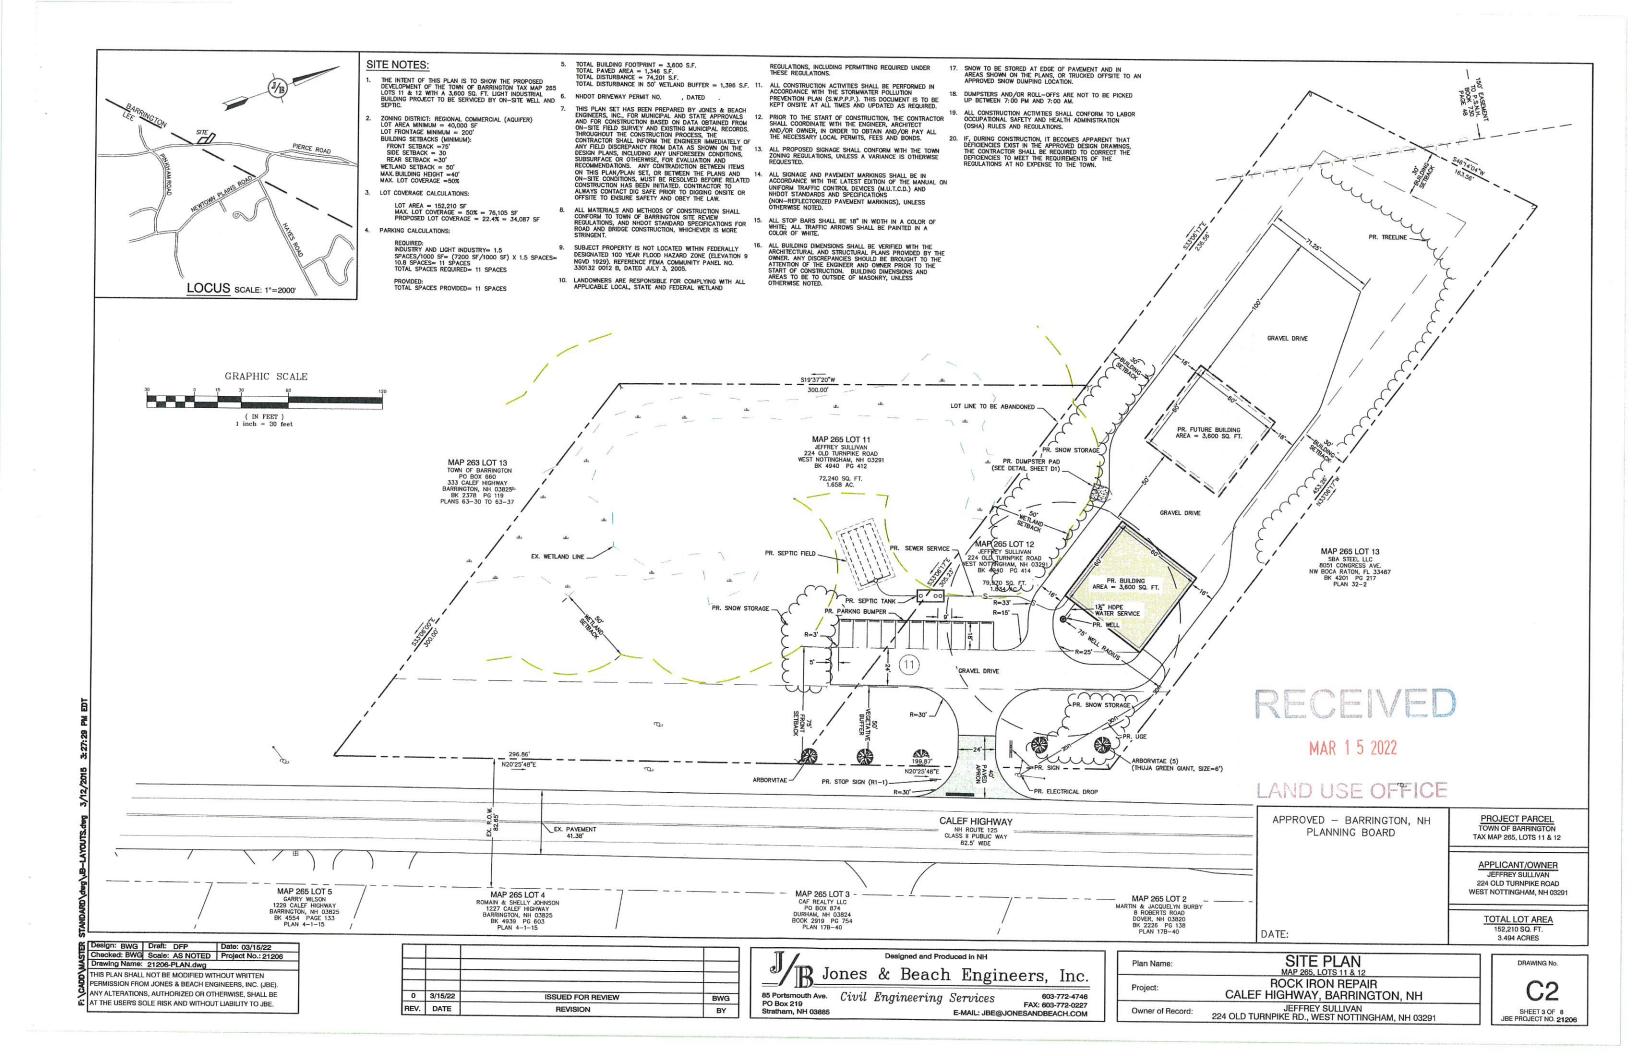

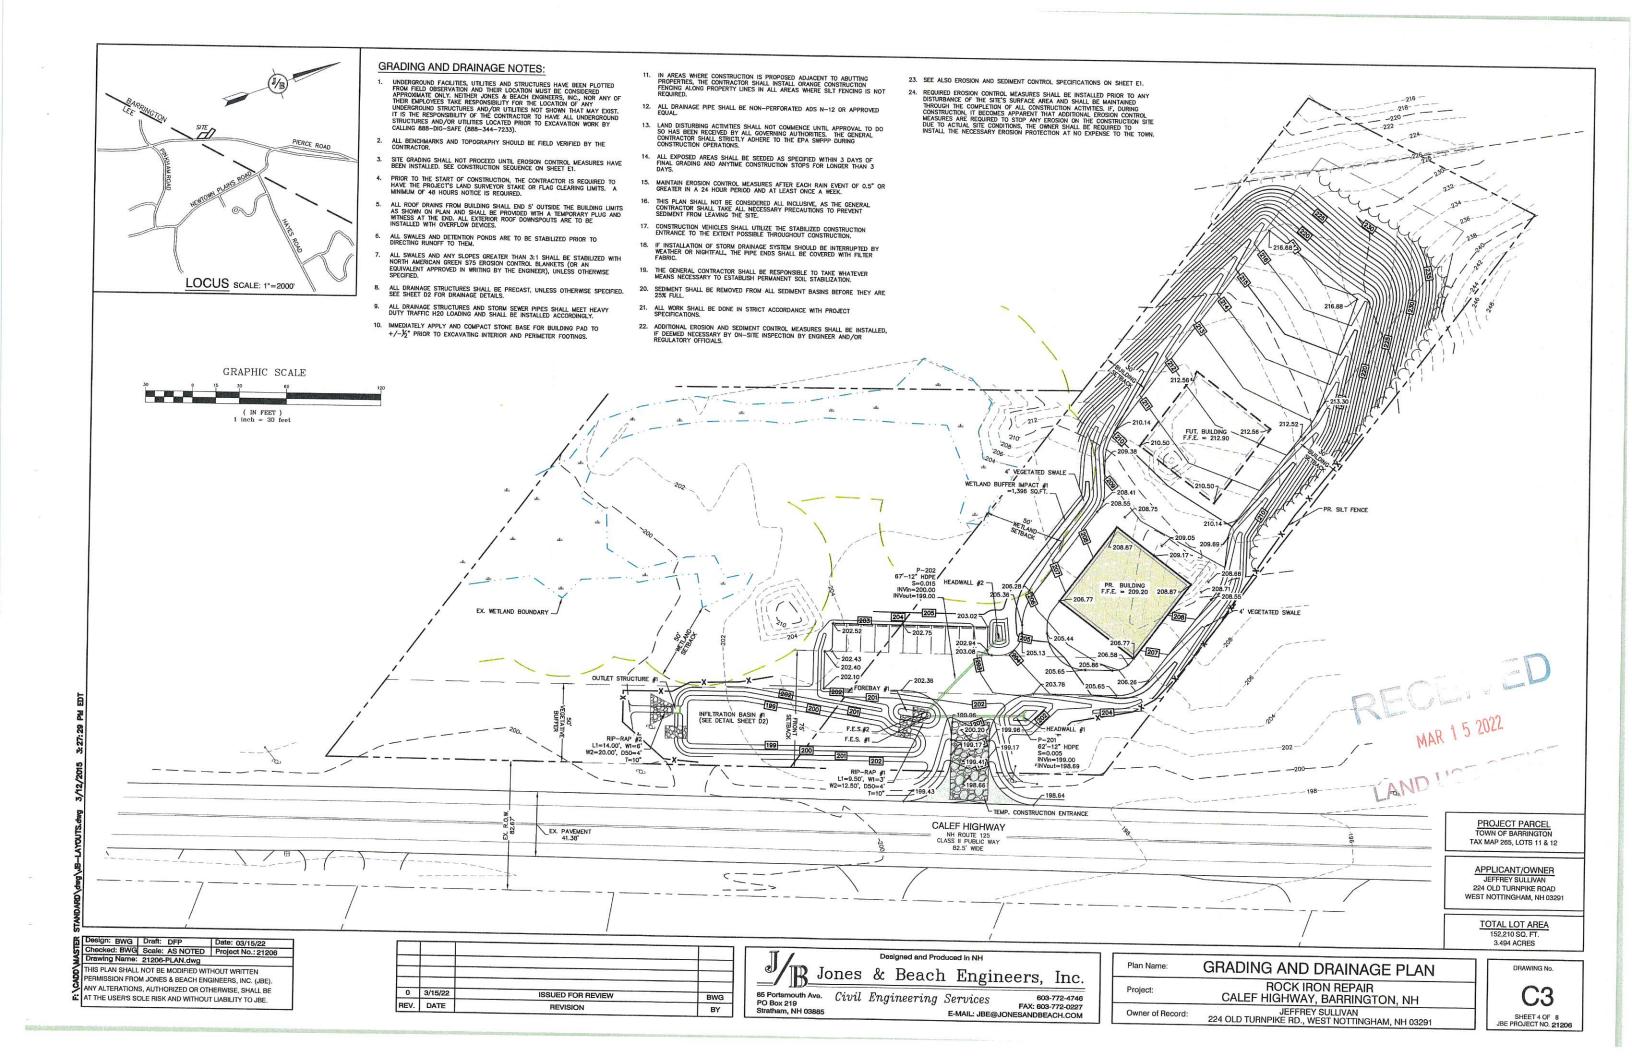

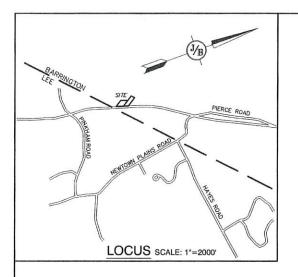

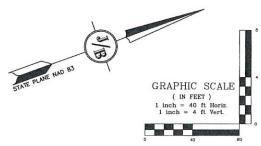

MAP 265 LOT 4

ROMAN & 2951 LY JORDON
PREATY LIC
ROMAN & 2951 LY JORDON
ROMAN & 2951

MAP 265 LOT :

NOTES


1. SIGNS SHALL BE TO THE MANUAL OF UNIFORM TRAFFIC CONTROL DEVICES (MUTCD) STANDARDS AND NHDOT STANDARDS.

2. SIGN, HARDWARE, AND INSTALLATION TO CONFORM TO 2016 NHDOT STANDARD SPECIFICATIONS, SECTION 615 - TRAFFIC SIGNS.

3. STOP BAR TO CONFORM TO NHDOT PM-9 STOP BAR DETAIL

ROCK IRON REPAIR DRIVEWAY / CALEF HIGHWAY INTERSECTION

MAP 265 LOT 11 JEFFREY SULLIVAN 224 OLD TURNPIKE ROAD WEST NOTTINGHAM, NH 0329 BK 4940 PG 412

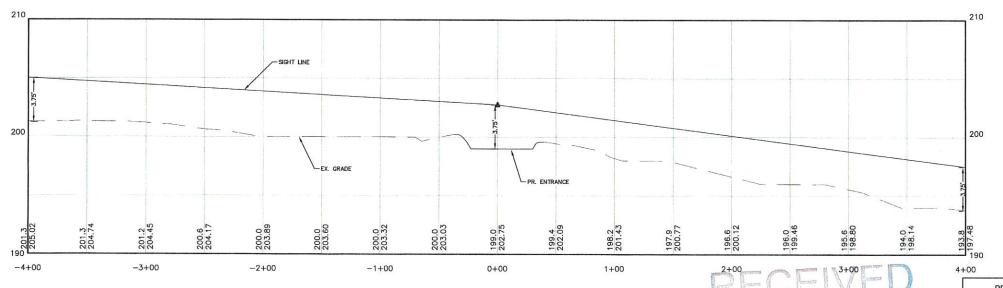

TRAFFIC CONTROL SCHEDULE

NUMBER SIGN SIZE OF SIGN WIDTH HEIGHT DESCRIPTION MOUNT TYPE HEIGHT REMARKS

R1-1 STOP 30" 30" WHITE ON RED CHANNEL 7'-0" REFLECTORIZED SIGN

MAR 1 5 2022

MAP 265 LOT 13 SBA STEEL LLC 8051 CONGRESS AVE. W BOCA RATON, FL 33487 BK 4201 PG 217 PLAN 32-2

ND USE OFFICE

JEFFREY SULLIVAN 224 OLD TURNPIKE RD., WEST NOTTINGHAM, NH 03291 PROJECT PARCEL TOWN OF BARRINGTON TAX MAP 265, LOTS 11 & 12

APPLICANT/OWNER
JEFFREY SULLIVAN
224 OLD TURNPIKE ROAD
WEST NOTTINGHAM, NH 0329

TOTAL LOT AREA 152,210 SQ. FT. 3.494 ACRES

Design: BWG Draft: DFP Date: 03/15/22
Checked: BWG Scale: AS NOTED Project No.: 21206
Drawing Name: 21206-PLAN.dwg
THIS PLAN SHALL NOT BE MODIFIED WITHOUT WRITTEN
PERMISSION FROM JONES & BEACH ENGINEERS, INC. (JBE).

ANY ALTERATIONS, AUTHORIZED OR OTHERWISE, SHALL BE

AT THE USER'S SOLE RISK AND WITHOUT LIABILITY TO JBE.

0	3/15/22	ISSUED FOR REVIEW	BWG
REV.	DATE	REVISION	BY

MAP 263 LOT 13 TOWN OF BARRINGTON PO BOX 660 333 CALEF HIGHWAY BARRINGTON, NH 03825 BK 2378 PG 119 PLANS 63-30 TO 63-37

MAP 265 LOT 5

MAP 265 LOT 5
GARRY WILSON
1229 CALEF HIGHWAY
BARRINGTON, NH 03825
BK 4554 PAGE 133
PLAN 4-1-15

1		De	signed and Prod	luced in NH	
	Jones	&	Beach	Engineers,	Inc.
85 Portemouth	Nuo Cinvil	Em a	id manarian a	Commisso 60	3-772-4746

85 Portsmouth Ave. Civil Engineering Services 603-772-4746
PO Box 219
Stretham, NH 03885


E-MAIL: JBE@JONESANDBEACH.COM

Plan Name:	HIGHWAY ACCESS PLAN
Project:	ROCK IRON REPAIR CALEF HIGHWAY, BARRINGTON, NH

Owner of Record:

HA1
SHEET 5 OF 8
JBE PROJECT NO. 21206

DRAWING No.

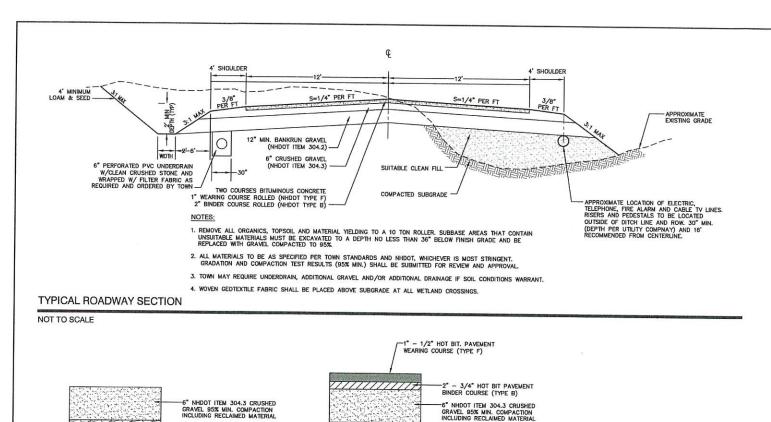

TYPICAL GRAVEL SECTION

95% COMPACTED SUBGRADE OR ROCK FILL


NOT TO SCALE


TYPICAL BITUMINOUS PAVEMENT

95% COMPACTED SUBGRADE OR ROCK FILL

NOT TO SCALE

NHDOT ITEM 304.2 BANK

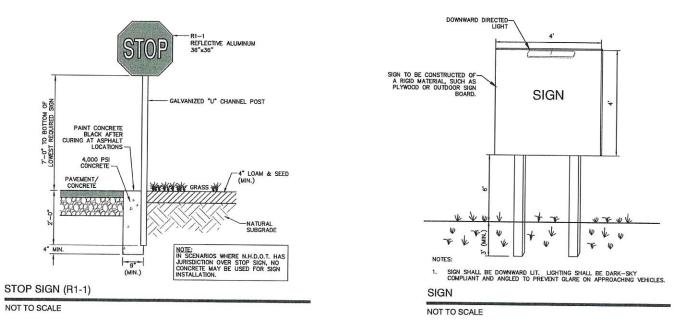


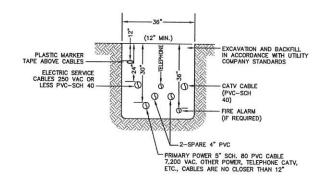

NOTE: ALL UTILITIES SHALL BE REVIEWED AND APPROVED BY APPROPRIATE UTILITY COMPANY.


UTILITY TRENCH

NOT TO SCALE

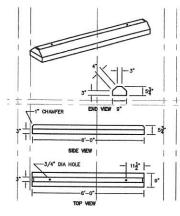

BUMPER CURBING

NOT TO SCALE

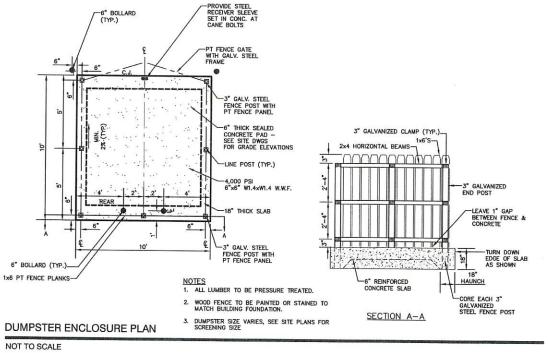

RECEIVED

MAR 1 5 2022

LAND USE OFFICE


Design: BWG Draft: DFP Date: 03/15/22 Checked: BWG Scale: AS NOTED Project No.: 21206 Drawing Name: 21206-PLAN.dwg HIS PLAN SHALL NOT BE MODIFIED WITHOUT WRITTEN PERMISSION FROM JONES & BEACH ENGINEERS, INC. (JBE). ANY ALTERATIONS, AUTHORIZED OR OTHERWISE, SHALL BE AT THE USER'S SOLE RISK AND WITHOUT LIABILITY TO JBE.

0	3/15/22	ISSUED FOR REVIEW	BWG
REV.	DATE	REVISION	BY

Designed and Produced in NH Jones & Beach Engineers, Inc.


85 Portsmouth Ave. Civil Engineering Services
PO Box 219 603-772-4746 FAX: 603-772-0227 E-MAIL: JBE@JONESANDBEACH.COM Plan Name: **DETAIL SHEET ROCK IRON REPAIR** Project: CALEF HIGHWAY, BARRINGTON, NH JEFFREY SULLIVAN 224 OLD TURNPIKE RD., WEST NOTTINGHAM, NH 03291 Owner of Record:

DRAWING No SHEET 6 OF 8 JBE PROJECT NO. 21206

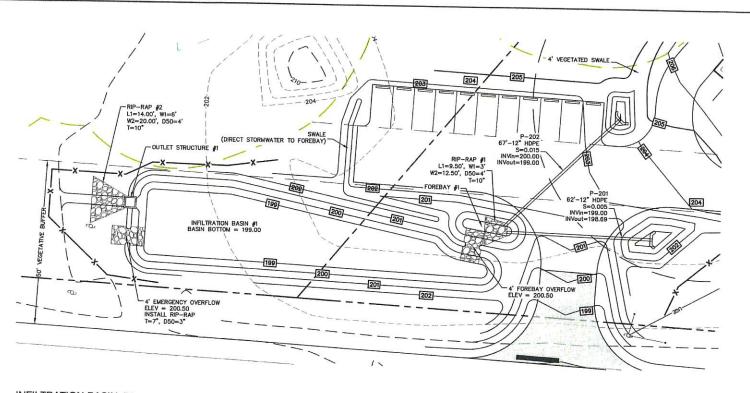

INFILTRATION BASIN #1

SCALE: 1" = 20'

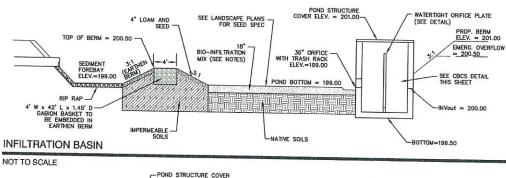


BIO-INFILTRATION MIX AND PROCEDURE:


- REMOVE EXISTING FOREST LITTER FROM INFILTRATION BASIN SITE. PROP. BERM ELEV. = 201.00 2. REMOVE SANDY LOAM AND STOCKPILE (SCREEN LARGE ROOTS).
- EMERG. OVERFLOW 3. REMOVE SANDY LAYERS TO 18" BELOW BASIN FLOOR ELEVATION.

 "200.50
 4. BIO-INFILTRATION MIX- FBV MODIFIED.

 - BIO-INITIRATION MIX: (BY VOLUME)
 4.1. 50%—55% ASTM C-33 CONCRETE SAND.
 4.2. 20%—30% ICOMY SAND TOPSOIL WITH 15%-25% FINES
 PASSING A #200 SIEVE
 4.3. 20%—30% MODERATELY FINE SHREDDED BARK OR WOOD FIBER
 MULCH WITH LESS THAN 5% PASSING THE #200 SIEVE. 4.3.
 - 5. INSTALL TO BIO-INFILTRATION MIX TO BASIN BOTTOM ELEVATION
 - SEED WITH "NEW ENGLAND WARM SEASON GRASS MIX" AS SOLD BY NEW ENGLAND WETLAND PLANTS, INC. OR EQUAL AS APPROVED BY ENGINEER. APPLICATION RATE = 1900 SQ.FT. / LB.
 LIGHTLY MULCH WITH WEED FREE STRAW.

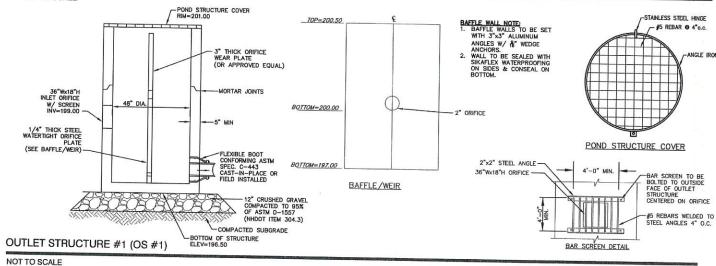

-- DISTANCE PER PLANS-RIPRAP (SIZE AS SPECIFIED EMERGENCY SPILLWAY SECTION

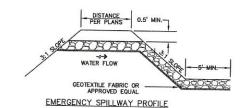


E-MAIL: JBE@JONESANDBEACH.COM

EMERGENCY SPILLWAY

NOT TO SCALE




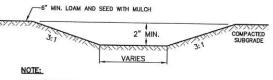

1. STABILIZED PRIOR TO DIRECTING RUN OFF TO SWALE 2. CONSTRUCT SWALE AT 0.005 FT/FT SLOPE (MIN.)

VEGETATED SWALE

NOT TO SCALE

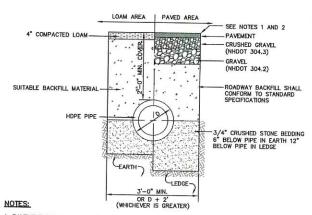

- 1. PAVEMENT REPAIR IN EXISTING ROADWAYS SHALL CONFORM TO STREET OPENING REGULATIONS.
- 2. NEW ROADWAY CONSTRUCTION SHALL CONFORM WITH PROJECT AND TOWN SPECIFICATIONS.
- 3. ALL MATERIALS ARE TO BE COMPACTED TO 95% OF ASTM D-1557.

DRAINAGE TRENCH

NOT TO SCALE

| Design: BWG | Draft: DFP | Date: 03/15/22 | Checked: BWG | Scale: AS NOTED | Project No.: 21206 | Drawing Name: 21206-PLAN.dwg THIS PLAN SHALL NOT BE MODIFIED WITHOUT WRITTEN PERMISSION FROM JONES & BEACH ENGINEERS, INC. (JBE). ANY ALTERATIONS, AUTHORIZED OR OTHERWISE, SHALL BE AT THE USER'S SOLE RISK AND WITHOUT LIABILITY TO JBE.

0	3/15/22	ISSUED FOR REVIEW	BWG
REV.	DATE	REVISION	BY


11/		De	signed and Pro	oduc	ed in NH		
B Jo	ones	&	Beacl	h	Engine	ers,	Inc.
85 Portsmouth Ave. PO Box 219 Stratham, NH 03885	Civil	Eng	ineering	Se	ervices		-772-4746 -772-0227

Plan Name:	DETAIL SHEET	
Project:	ROCK IRON REPAIR CALEF HIGHWAY, BARRINGTON, NH	
Owner of Record:	JEFFREY SULLIVAN 224 OLD TURNPIKE RD., WEST NOTTINGHAM, NH 03291	7.5.5

DRAWING No. SHEET 7 OF 8 JBE PROJECT NO. 21206

- TEMPORARY EROSION CONTROL NOTES

 1. THE SMALLEST PRACTICAL AREA OF LAND SHALL BE EXPOSED AT ANY ONE TIME, AT NO TIME SHALL AN AREA IN EXCESS OF 5 ACRES BE EXPOSED AT ANY ONE TIME BEFORE DISTURBED AREAS ARE STABILIZED.
- EROSION, SEDIMENT AND DETENTION MEASURES SHALL BE INSTALLED AS SHOWN ON THE PLANS AND AT LOCATIONS AS REQUIRED, DIRECTED BY THE ENGINEER.
- ALL DISTURBED AREAS (INCLUDING POND AREAS BELOW THE PROPOSED WATERLINE) SHALL BE RETURNED TO PROPOSED GRADES AND ELEVATIONS. DISTURBED AREAS SHALL BE LOAMED WITH A MINIMUM OF 6" OF SCREENBED ORGANIC LOAM AND SEEDED WITH SEED MIXTURE "O" ATA BATE NOT LESS THAN 1.10 POUNDS OF SEED PET 1,000 S.F. OF AREA (48 LBS. / AORE.)
- SILT FENCES AND OTHER BARRIERS SHALL BE INSPECTED EVERY SEVEN CALENDAR DAYS AND WITHIN 24 HOURS OF A RAINFALL OF 0.5" OR GREATER. ALL DAMAGED AREAS SHALL BE REPAIRED, AND SEDIMENT DEPOSITS SHALL PERIODICALLY BE REMOVED AND DISPOSED OF.
- AFTER ALL DISTURBED AREAS HAVE BEEN STABILIZED, THE TEMPORARY EROSION CONTROL MEASURES SHALL BE REMOVED AND THE AREA DISTURBED BY THE REMOVAL SMOOTHED AND RE-VEGETATED.
- AREAS MUST BE SEEDED AND MULCHED OR OTHERWISE PERMANENTLY STABILIZED WITHIN 3 DAYS OF FINAL GRADING, OR TEMPORABILY STABILIZED WITHIN 14 DAYS OF THE INITIAL DISTURBANCE OF SOIL ALL AREAS SHALL BE STABILIZED WITHIN 45 DAYS OF INITIAL DISTURBANCE.
- ALL PROPOSED VEGETATED AREAS THAT DO NOT EXHIBIT A MINIMUM OF 85 PERCENT VEGETATIVE GROWTH BY COTOBER 18, OR WHICH ARE DISTURBED AFTER OCTOBER 15, SHALL BE STABILIZED BY SEEDING AND INSTALLING NORTH AMERICAN GREEN 575 EROSION CONTROL BLANKERS (OR AN EQUIVALENT APPROVED IN WRITING BY THE ENGINEER) ON SLOPES GREATER THAN 3-1, AND SEEDING AND PLACING 3 TO 4 TONS OF MULCH PER ACRE, SECURED WITH ANCHORED NETTING, ELSEWHERE, THE INSTALLATION OF EROSION CONTROL BLANKERS OR MULCH AND NETTING SHALL MOY OCCUR OVER ACCUMULATED SNOW OR ON FROZEN GROUND AND SHALL BE COMPLETED IN ADVANCE OF THAW OR SPRING MELT EVENTS.
- 1. DITCHES OR SWALES WHICH DO NOT EXHIBIT A MINIMUM OF 85 PERCENT VEGETATIVE GROWTH BY OCTOBER 15, OR WHICH BE DISTURBED AFTER OCTOBER 15, SHALL BE STABILIZED TEMPORARILY WITH STONE OR EROSION CONTROL BLANKETS PROPRIATE FOR THE DESIGN FLOW CONDITIONS.
- AFTER OCTOBER 15th, INCOMPLETE ROAD OR PARKING SURFACES, WHERE WORK HAS STOPPED FOR THE WINTER SEASON, SHALL BE PROTECTED WITH A MINIMUM OF 3" OF CRUSHED GRAVEL PER NIDOT ITEM 304.3.
- 10. AN AREA SHALL BE CONSIDERED STABLE IF ONE OF THE FOLLOWING HAS OCCURRED:
 - a. BASE COURSE GRAVELS HAVE BEEN INSTALLED IN AREAS TO BE PAVED:
 - b. A MINIMUM OF 85% VEGETATED GROWTH HAS BEEN ESTABLISHED:
 - O. A MINIMUM OF 3" OF NON-EROSIVE MATERIAL SUCH STONE OR RIPRAP HAS BEEN INSTALLED; OR
- d. EROSION CONTROL BLANKETS HAVE BEEN PROPERLY INSTALLED.
- 11. FUGITIVE DUST CONTROL IS REQUIRED TO BE CONTROLLED IN ACCORDANCE WITH ENV--A 1000, AND THE PROJECT IS TO MEET THE REQUIREMENTS AND INTENT OF RSA 430:53 AND AGR 3800 RELATIVE TO INVASIVE SPECIES.
- 12. PRIOR TO BEGINNING CONSTRUCTION, THE CONTRACTOR'S NAME, ADDRESS, AND PHONE NUMBER SHALL BE SUBMITTED TO DES VIA EMAIL (SEE BELOW).
- 13. PRIOR TO CONSTRUCTION, A PHASING PLAN THAT DELINEATES EACH PHASE OF THE PROJECT SHALL BE SUBMITTED. ALL TEMPORARY SEDIMENT BASINS THAT WILL BE NEEDED FOR DEWATERING WORK AREAS SHALL BE LOCATED AND IDENTIFIED ON THIS
- . In order to ensure the stability of the site and effective implementation of the sediment and erosion control measures specified in the plans for the duration of construction, the contractor shall be in strict compliance with the following inspection and maintenance requirements in addition to those called for in the swppp:
- a. A CERTIFIED PROFESSIONAL IN EROSION AND SECUMENT CONTROL OR A PROFESSIONAL ENGINEER LICENSED IN THE STATE OF NEW HAMPSHIRE ("MONTROF") SHALL BE EMPLOYED TO INSPECT THE SITE FROM THE STATY OF ALTERATION OF TERRAIN ACTIVITIES UNTIL THE SITE IS IN FULL COMPULANCE WITH THE SITE SPECIFIC PERMIT ("PARMIT").
- b. DURING THIS PERIOD, THE MONITOR SHALL INSPECT THE SUBJECT SITE AT LEAST ONCE A WEEK, AND IF POSSIBLE, DURING ANY ½ INCH OR GREATER RAIN EVENT (I.E. ½ INCH OF PRECIPITATION OR MORE WITHIN A 24 HOUR PERIOD). IF UNABLE TO BE PRESENT DURING SUCH A STORM, THE MONITOR SHALL INSPECT THE SITE WITHIN 24 HOURS OF THIS EVENT.
- o. THE MONITOR SHALL PROVIDE TECHNICAL ASSISTANCE AND RECOMMENDATIONS TO THE CONTRACTOR ON THE APPROPRIATE BEST MANAGEMENT PRACTICES FOR EROSION AND SEDIMENT CONTROLS REQUIRED TO MEET THE REQUIREMENTS OF 883 468 A17 AND ALL APPLICABLE DES PERMIT CONDITIONS.
- d. WITHIN 24 HOURS OF EACH INSPECTION, THE MONITOR SHALL SUBMIT A REPORT TO DES VIA EMAIL (RIDGELY MAUCK AT; RIDGELY,MAUCK@DES,NH.GOV).
- THE MONITOR SHALL MEET WITH DES TO DECIDE UPON A REPORT FORMAT. THE REPORT FORMAT SHALL BE REVIEWED AND APPROVED BY DES PRIOR TO THE START OF CONSTRUCTION.

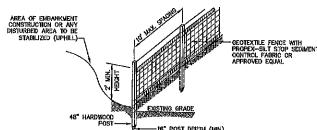


CONSTRUCTION SPECIFICATIONS:

- . Woven fabric fence to be fastened securely to fence posts with wire ties or staples, filter cloth shall be fastened to woven wire every 24° at top, and and bottom and embedded in the ground a minimum of 8" and then covered with soil.
- THE FENCE POSTS SHALL BE A MINIMUM OF 48" LONG, SPACED A MAXIMUM 10' APART, AND DRIVEN A MINIMUM OF 16" INTO THE GROUND.
- . When two sections of filter cloth adjoin each other, the ends of the fabric shall be overlapped 6", folded and stapled to prevent sediment from by—passing.
- MAINTENANCE SHALL, BE PERFORMED AS NEEDED AND SCHIMENT REMOVED AND PROPERLY DISPOSED OF WHIEN IT IS 6" DEEP OR WISIBLE 'BULGES' DEVELOP IN THE SILT FENCE.
- 5. PLACE THE ENDS OF THE SILT FENCE UP CONTOUR TO PROVIDE FOR SEDIMENT STORAGE,
- 6. SILT FENCE SHALL REMAIN IN PLACE FOR 24 MONTHS.

SILT FENCE

NOT TO SCALE

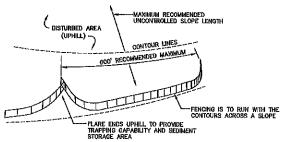

SILT FENGES SHALL BE REMOVED WHEN NO LONGER MEEDED AND THE SEDIMENT COLLECTED SHALL BE DISPOSED AS DIRECTED BY THE ENGINEER. THE AREA DISTURBED BY THE REMOVAL SHALL BE SMOOTHED AND REVEGETATED.

MAINTENANCE:

- SILT FENCES SHALL BE INSPECTED IMMEDIATELY AFTER EACH RAINFALL AND AT LEAST DAILY DURING PROLONGED RAINFALL, ANY REPAIRS THAT ARE REQUIRED SHALL BE DONE IMMEDIATELY.
- IF THE FABRIC ON A SILT FENCE SHOULD DECOMPOSE OR BECOME INEFFECTIVE DURING THE EXPECTED LIFE OF THE FENCE, THE FABRIC SHALL BE REPLACED PROMPTLY.
- 3. SEDIMENT DEPOSITS SHOULD BE INSPECTED AFTER EVERY STORM EVENT. THE DEPOSITS SHOULD BE REMOVED WHEN THEY REACH APPROXIMATELY ONE HALF THE HEIGHT OF THE BARRIER.
- 4. SEDIMENT DEPOSITS THAT ARE REMOVED, OR LEFT IN PLACE AFTER THE FABRIC HAS BEEN REMOVED, SHALL BE GRADED TO CONFORM WITH THE EXISTING TOPOGRAPHY AND VEGETATED.

SEEDING SPECIFICATIONS

- GRADING AND SHAPING.
 A. SLOPES SHALL NOT BE STEEPER THAN 2:1 WITHOUT APPROPRIATE EROSION CONTROL MEASURES AS
 SPECIFIED ON THE PLANS (3:1 SLOPES OR FLATTER ARE PREFERRED).
 B. WHERE MOWING WILL BE DONE, 3:1 SLOPES OR FLATTER ARE RECOMMENDED.

- 2. SECOBED_PREPARATION.
 A. SURFACE AND SECPAGE WATER SHOULD BE DRAINED OR DIVERTED FROM THE SITE TO PREVENT DROWNING OR WINTER KILLING OF THE PLANTS.
 B. SYCKIES LARDER THAN 4 (NOFES AND TRASH SHOULD BE REMOVED BECAUSE THEY INTERFERE WITH SECDING AND FUTURE MAINTENANCE OF THE AREA. WHERE FEASIBLE, THE SOIL SHOULD BE TILLED TO A DEPTH OF ABOUT 4 (NORES TO PREPARE A SECRIBED AND FERTILIZER AND LIME MIXED INTO THE SOIL. THE SEEDBE SHOULD BE LEFT IN A REASONABLY FIRM AND SMOOTH CONDITION. THE LAST TILLAGE OPERATION SHOULD BE PERFORMED ACROSS THE SLOPE WHEREVER PRACTICAL.

- 3. ESTABLISHING A STAND.
 A. LIWE AND FERTULZER SHOULD BE APPLIED PRIOR TO OR AT THE TIME OF SEEDING AND INCORPORATED INTO THE SOIL TYPES AND AMOUNTS OF LAWE AND FERTULIZER SHOULD BE BASED ON AN EVALUATION OF SOIL TESTS. WHEN A SOIL TEST IS NOT AVAILABLE, THE FOLLOWING MINIMUM AMOUNTS SHOULD BE
 - AGRICULTURAL LIMESTONE, 2 TONS PER ACRE OR 100 LBS. PER 1,000 SQ.FT. NITROGEN(N), 50 LBS. PER AORE OR 1.1 LBS. PER 1,000 SQ.FT.
 PHOSPHATE(P205), 100 LBS. PER ACRE OR 2.2 LBS. PER 1,000 SQ.FT.
 POTASH(K2D), 100 LBS. PER ACRE OR 2.2 LBS. PER 1,000 SQ.FT.
 - (NOTE: THIS IS THE EQUIVALENT OF 500 LBS, PER ACRE OF 10-20-20 FERTILIZER OR 1,000 LBS, PER
- ACRE OF 5-10-10.)

 SEED SHOULD BE SPREAD UNIFORMLY BY THE METHOD MOST APPROPRIATE FOR THE SITE, METHODS NCLUBE BROADCASTING, DRELING AND HYDROSEEDING, WHERE BROADCASTING IS USED, COVER SEED WITH .25 INCH OF SOIL OR LESS, BY CULTIPACKING OR RAKING.
 REFERT OF THE 'SEEDING GIDE' AND SEEDING RATE 'TABLES ON THIS SHEET FOR APPROPRIATE SEED MIXTURES AND RATES OF SEEDING. ALL LEGUMES (CROWNVETCH, BIRDSFOOT, TREFOIL AND FLATFEA) MUST BE INCCULATED WITH THEIR SPECIFIC INCOLLANT PRIOR TO THIRR INTRODUCTION TO THE SITE.
 WHEN SEEDED AREAS ARE MULCHED, PLANTINGS WAY BE MADE FROM EARLY SPRING TO EARLY OCTOBER.
 WHEN SEEDED AREAS ARE MULCHED, PLANTINGS WAY BE MADE FROM EARLY SPRING TO MAY 20th OR FROM AUGUST 10th TO SEPTEMBER 1st.

LUI.

HAY, STRAW, OR OTHER MULCH, WHEN NEEDED, SHOULD BE APPLIED IMMEDIATELY AFTER SEEDING.

MULCH WILL BE HELD IN PLACE USING APPROPRIATE TECHNIQUES FROM THE BEST MANAGEMENT PRACTICE
FOR MULCHING, HAY OR STRAW MULCH SHALL BE PLACED AT A RATE OF 90 LBS PER 1000 S.F.

- 6. MAINTENANCE TO ESTABLISH A STAND

 A. PLANTED AREAS SHOULD BE PROTECTED FROM DAMAGE BY FIRE, GRAZING, TRAFFIC, AND DENSE WEED
- GROWTH.

 B. FERTILIZATION NEEDS SHOULD BE DETERMINED BY ONSITE INSPECTIONS. SUPPLEMENTAL FERTILIZER IS

 FERTILIZATION NEEDS SHOULD BE DETERMINED BY ONSITE INSPECTIONS. SUPPLEMENTAL FERTILIZER IS

 FERTILIZATION NEEDS SHOULD BE DETERMINED BY ONSITE INSPECTIONS. USUALLY THE KEY TO FULLY COMPLETE THE ESTABLISHMENT OF THE STAND BECAUSE MOST PERENNIALS TAKE 2 TO 3 YEARS TO BECOME FULLY ESTABLISHED.
- C. IN WATERWAYS, CHANNELS, OR SWALES WHERE UNIFORM FLOW CONDITIONS ARE ANTICIPATED, ANNUAL MOWING MAY BE NECESSARY TO CONTROL GROWTH OF WOODY VEGETATION.

USE	SEEDING MIXTURE 1/	DROUGHTY	WELL DRAINED	MODERATELY WELL DRAINED	POORLY DRAINED
STEEP CUTS AND FILLS, BORROW AND DISPOSAL AREAS	A B C	FAIR POOR POOR	600D 600D	GOOD FAIR EXCELLENT	FAIR FAIR GOOD
	D	FAIR	EXCELLENY	EXCELLENT	POOR
WATERWAYS, EMERGENC' SPILLWAYS, AND OTHER CHANNELS WITH FLOWING WATER.	(Å	GOOD	GOOD EXCELLENT	GOOD EXCELLENT	FAIR FAIR
LIGHTLY USED PARKING LOTS, ODD AREAS, UNUSED LANDS, AND LOW INTENSITY USE RECREATION SITES.	A B C	GOOD GOOD GOOD	GOOD GOOD EXCELLENT	GOOD FAIR EXCELLENT	FAIR POOR FAIR
PLAY AREAS AND ATHLETIC FIELDS. (TOPSOIL IS ESSENTIAL FOR GOOD TURF.)	E F	FAIR FAIR	EXCELLENT EXCELLENT	EXCELLENT EXCELLENT	2/ 2/

GRAVEL PIT, SEE NH-PM-24 IN APPENDIX FOR RECOMMENDATION REGARDING RECLAMATION OF SAND AND GRAVEL PITS.


1/ REFER TO SEEDING MIXTURES AND RATES IN TABLE BELOW,
2/ POORLY DRAINED SOILS ARE NOT DESIRABLE FOR USE AS PLAYING AREA AND ATHLETIC FIELDS.

NOTE: TEMPORARY SEED MIX FOR STABILIZATION OF TURF SHALL BE WINTER RYE OR DATS AT A RATE OF 2.5 LBS. PER 1000 S.F. AND SHALL BE PLACED PRIOR TO OCTOBER 15th, IF PERMANENT SEEDING NOT YET COMPLETE.

SEEDING GUIDE

	MIXTURE	POUNDS PER_ACRE_	POUNDS PER 1,000 Sq. Ft.
	A. TALL FESCUE	20	0.45
	CREEPING RED FESCUE	20	0.45
	RED TOP	2	<u>0.05</u>
	TOTAL	42	0.95
	B. TALL FESCUE CREEPING RED FESCUE CROWN VETCH OR FLAT PEA TOTAL	15 10 15 15 30 40 CR 55	0.35 0.25 0.35 0.76 0.95 OR 1.35
*	G, TALL FESCUE	20	0.45
	CREEPING RED FESCUE	20	0.45
	BIRDS FOOT TREFOIL	8	0.20
	TOTAL	48	1.10
	D. TALL FESCUE	20	0.45
	FLAT PEA	30	0.75
	TOYAL	50	1.20
	E. CREEPING RED FESCUE 1/	50	1.15
	KENTUCKY BLUEGRASS 1/	50	1.15
	TOTAL	100	2.30
	F. TALL FESCUE 1	150	3.60
	1/FOR HEAVY USE ATHLETIC FIELDS NEW HAMPSHIRE COOPERATIVE EXTEN CURRENT VARIETIES AND SEEDING RA	SION TURF SPE	UNIVERSITY OF DIALIST FOR

SEEDING RATES

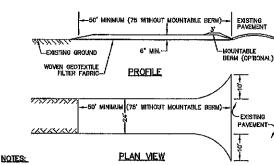

- STONE FOR STABILIZED CONSTRUCTION ENTRANCE SHALL BE 3 INCH STONE, RECLAIMED STONE, OR RECYCLED CONCRETE EQUIVALENT.
- 2. THE LENGTH OF THE STABILIZED ENTRANCE SHALL NOT BE LESS THAN BO FEET, 78" WITHOUT A MOUNTABLE BERM, AND EXCEPT FOR A SINGLE RESIDENTIAL LOT WHERE A 30 FOOT MINIMUM LENGTH

- MOUNTABLE BERN, AND EXCEPT FOR A SINGLE RESIDENTIAL LOT WHERE A 30 FOOT MINIMUM LENGTH WOULD APPLY.

 3. HICKNESS OF THE STONE FOR THE STABILIZED ENTRANCE SHALL NOT BE LESS THAN 6 INCHES.

 4. THE WOITH OF THE ENTRANCE SHALL NOT BE LESS THAN THE FULL WOTH OF THE ENTRANCE WHERE INORESS OF EGRESS OCCURS, OR TO FEET, WHICHEVER IS GREATER.

 INORESS OR EGRESS OCCURS, OR TO FEET, WHICHEVER IS GREATER.

 GETEXTIC FILTER FABRIC IS NOT REQUIRED FOR A SINGLE FAMILY RESIDENTIAL LOT.

 FILTER FABRIC IS NOT REQUIRED FOR A SINGLE FAMILY RESIDENTIAL LOT.

 G. ALL SURFACE WATER THAT IS FLOWING TO OR DIVERTED TOWARD THE CONSTRUCTION ENTRANCE SHALL BE PIPED BENEATH THE ENTRANCE. IF PIPING IS IMPRACTICAL, A STONE BERM WITH EXI SLOPES THAT CAN BE CROSSED BY VEHICLES MAY BE SUBSTITUTED FOR THE PIPE.

 7. THE ENTRANCE SHALL BE MAINTAINED IN A CONDITION THAT WILL PREVENT TRACKING OR FLOWING OF SEDIMENT ONTO THE PUBLIC RIGHT—OF—WAY, THIS WAY REQUIRES PERIODIC TOP DEESSING WITH ADDITIONAL STONE AS CONDITIONS DEMAND AND REPAIR AND/OR CLEAN OUT OF ANY MEASURES USED TO TRAP SEDIMENT. ALL SEDIMENT SPILLED, WASHED, OR TRACKED CNTO THE PUBLIC RIGHT—OF—WAY MUST BE REMOVED PROMPTLY.

STABILIZED CONSTRUCTION ENTRANCE

NOT TO SCALE

CONSTRUCTION SEQUENCE

- PRIOR TO THE START OF ANY ACTIVITY, IT IS THE RESPONSIBILITY OF THE SITE'S SITE DEVELOPER (OR OWNER) TO FILE A NOTICE OF INTENT (NOI) FORM WITH THE ENVIRONMENTAL PROTECTION AGENCY (EPA) IN ORDER TO GAIN COVERAGE UNDER THE INPOSE GENERAL PERMIT FOR STORM WATER DISCHARGES FROM CONSTRUCTION ACTIVITIES. A PRE CONSTRUCTION MEETING IS TO BE HELD WITH ALL. DEPARTMENT HEADS PRIOR TO THE START OF CONSTRUCTION.
- 2. WETLAND BOUNDARIES ARE TO BE CLEARLY MARKED PRIOR TO THE START OF CONSTRUCTION, AT LEAST A TEMPORARY CULVERT OR ROADBED TO BE IN PLACE PRIOR TO THE START OF CONSTRUCTION.
- 3. CUT AND REMOVE TREES IN CONSTRUCTION AREA AS REQUIRED OR DIRECTED.
- 4. INSTALL SILT FENCING, HAY BALES AND CONSTRUCTION ENTRANCES PRIOR TO THE START OF CONSTRUCTION, THESE ARE TO BE MAINTAINED UNTIL THE FINAL PAVEMENT SURFACING AND LANDSCAPING AREAS ARE ESTABLISHED.
- CLEAR, CUT, GRUB AND DISPOSE OF DEBRIS IN APPROVED FACILITIES. THIS INCLUDES ANY REQUIRED DEMOUTION OF EXISTING STRUCTURES, UTILITIES, ETC.
- CONSTRUCT AND/OR INSTALL TEMPORARY OR PERMANENT SEDIMENT AND/OR DETENTION BASIN(S) AS REQUIRED. THESE FACILITIES SHALL BE INSTALLED AND STABILIZED PRIOR TO DIRECTING RUN-OFF TO THEM.
- 7. STRIP LOAM AND STOCKPILE EXCESS MATERIAL STABILIZE STOCKPILE AS NECESSARY
- 8. PERFORM PRELIMINARY SITE GRADING IN ACCORDANCE WITH THE PLANS
- 9. PREPARE BUILDING PAD(S) TO ENABLE BUILDING CONSTRUCTION TO BEGIN.
- 10. INSTALL THE SEWER AND DRAINAGE SYSTEMS FIRST, THEN ANY OTHER UTILITIES IN ACCORDANCE WITH THE PLAN AND DETAILS, ANY CONFLICTS BETWEEN UTILITIES ARE TO BE RESOLVED WITH THE INVOLVEMENT AND APPROVAL OF THE ENGINEER.
- 11. ALL SWALES AND DRAINAGE STRUCTURES ARE TO BE CONSTRUCTED AND STABILIZED PRIOR TO HAVING RUN-OFF DIRECTED TO THEM
- 12. DAILY, OR AS REQUIRED, CONSTRUCT TEMPORARY BERMS, ORAINAGE DITCHES, CHECK DAMS, SEDIMENT TRAPS, ETC., TO PREVENT EROSION ON THE SITE AND PREVENT ANY SILTATION OF ABUTTING WATERS AND/OR PROPERTY.
- 13. PERFORM FINAL FINE GRADING, INCLUDING PLACEMENT OF 'SELECT' SUBGRADE MATERIALS
- 14. PERFORM ALL REMAINING SITE CONSTRUCTION (i.e. BUILDING, UTILITY CONNECTIONS, ETC.).
- LOAM AND SEED ALL DISTURBED AREAS AND INSTALL ANY REQUIRED SEDIMENT AND EROSION CONTROL FACILITIES (i.e. RIP RAP, EROSION CONTROL BLANKETS, ETC.).
- 16. ALL ROADWAYS AND PARKING LOTS SHALL BE STABILIZED WITHIN 72 HOURS OF ACHIEVING FINISHED GRADE.
- 17. ALL CUT AND FILL SLOPES SHALL BE SEEDED/LOAMED WITHIN 72 HOURS OF ACHIEVING FINISHED GRADE,
- 18. COMPLETE PERMANENT SEEDING AND LANDSCAPING.
- REMOVE TEMPORARY EROSION CONTROL MEASURES AFTER SEEDING AREAS HAVE BEEN 75%-85% ESTABLISHED AND SITE IMPROVEMENTS ARE COMPLETE. SMOOTH AND RE-VEGETATE ALL DISTURBED AREAS.

[20, 11 CLEAN SITE (AND ALL DRAINAGE STRUCTURES, DIPES AND SUMPS OF ALL SILT AND DEBRIS. 21: AL EROSION CONTROLS SHALL BE INSPECTED WERLY AND AFTER EVERY HALF-INCH OF RAINFALL

22. UPON COMPLETION OF CONSTRUCTION, IT, IS THE RESPONSIBILITY OF THE CONTRACTOR TO NOTIFY ANY RELEVANT PERMITTING AGENCIES THAT THE CONSTRUCTION HAS BEEN FINISHED IN A SATISFACTORY MAINER,

MAR 1 5 2022

OFFICE

Designed and Produced in NH Jones & Beach Engineers, Inc.

85 Portsmouth Ave. Civil Engineering Services PO Box 219 Stratham, NH 03885 FAX: 603-772-0227 E-MAIL: JBE@JONESANDBEACH.COM

Plan Name: EROSION AND SEDIMENT CONTROL DETAILS ROCK IRON REPAIR Project: CALEF HIGHWAY, BARRINGTON, NH JEFFREY SULLIVAN Owner of Record: 224 OLD TURNPIKE RD., WEST NOTTINGHAM, NH 03291



DRAWING No

Checked: BWG Scale: AS NOTED Project No.: 21206
Drawing Name: 21206-PLAN.dwg THIS PLAN SHALL NOT BE MODIFIED WITHOUT WRITTEN PERMISSION FROM JONES & BEACH ENGINEERS, INC. (JBE). ANY ALTERATIONS, AUTHORIZED OR OTHERWISE, SHALL BE LAT THE USER'S SOLE RISK AND WITHOUT LIABILITY TO JBE.

0 3/15/22 ISSUED FOR REVIEW BWG REV. DATE REVISION





1 inch = 274 Feet



10

13

12

NH-125


Lee

www.cai-tech.com

13

The second of th MAR 1 5 2022

LAND USE OFFICE

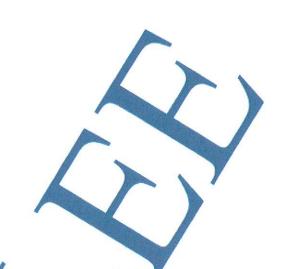

The property data available on this site is updated periodically. The Town of Barrington makes no warranties with regard to its accuracy or completeness and assumes no liability associated with the use of this data.