LAND USE OFFICE

APR 1 9 2017

RECEIVED



VW2-NH-0032A **BARRINGTON 1**


BUMFORD ROAD BARRINGTON, NH 03825

SITE TYPE: RAWLAND MONOPOLE





1600 OSGOOD STREET BUILDING 20 NORTH, SUITE 3090 TEL: (978) 557-5553 N. ANDOVER, MA 01845

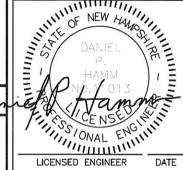

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I	1	03/03/17	ISSUED FOR PERMITTING			
1	A	01/27/17	ISSUED FOR REVIEW			
۱	REV. #	DATE	DESCRIPTION			

DRAWN BY: SB

SITE NAME:

VW2-NH-0032A BARRINGTON '

DESIGNED BY: AT SCALE:

AS SHOWN

SITE ADDRESS:

BUMFORD ROAD BARRINGTON, NH 03825 OWNER OF RECORD:

STEVEN F. LENZI REV. TRUST & PAMELA M. LENZI REV. TRUST

SHEET TITLE:

TITLE SHEET

SHEET NO .:

SHEET INDEX **VICINITY MAP** NOT TO SCALE DESCRIPTION REV TITLE SHEET ABUTTERS PLAN **EXISTING CONDITIONS** SITE PLAN COMPOUND AND ELEVATION **DETAILS** EROSION CONTROL & DETAILS PROJECT INFORMATION: PROPERTY OWNER: STEVEN F. LENZI REV. TRUST & PAMELA M. LENZI REV. TRUST 304 YOUNG ROAD BARRINGTON, NH 03825

VARSITY WIRELESS INVESTORS, LLC 290 CONGRESS STREET, 7TH FLOOR

SITE ADDRESS:

BUMFORD ROAD BARRINGTON, NH 03825

BOSTON, MA 02210

COUNTY:

APPLICANT:

STRAFFORD COUNTY

LATITUDE:

N 43° 11' 42.69" W 70° 59' 27.64"

LONGITUDE: ZONING CLASSIFICATION:

GENERAL RESIDENTIAL & STRATIFIED DRIFT AQUIFER OVERLAY

ZONING JURISDICTION: TOWN OF BARRINGTON

PARCEL ID:

218.251-64 PARCEL AREA: 95± ACRES

ARCHITECT / ENGINEER:

HUDSON DESIGN GROUP LLC 1600 OSGOOD STREET BUILDING 20 NORTH, SUITE 3090 N. ANDOVER, MA 01845

DRIVING DIRECTIONS

DIRECTIONS TO SITE FROM 290 CONGRESS STREET BOSTON, MA:

DEPART CONGRESS ST TOWARD ATLANTIC AVE. 495 FT. TURN RIGHT ONTO ATLANTIC AVE. 0.1 MI. TAKE RAMP FOR I-93 NORTH TOWARD CONCORD NH. 1.5 MI. AT EXIT 27, TAKE RAMP LEFT FOR US-1 NORTH TOWARD REVERE / TOBIN BR. 14.5 MI. TAKE RAMP RIGHT FOR I-95 N. ENTERING NEW HAMPSHIRE. TOLL ROAD 38.3 MI. AT EXIT 4, TAKE RAMP LEFT FOR RT-16 TOWARD NH LAKES / WHITE MTS. 1.8 MI. ROAD NAME CHANGES TO US-4 W / RT-16 N / SPAULDING TPKE. 4.2 MI. AT EXIT 6W, TAKE RAMP RIGHT FOR US-4 WEST TOWARD DURHAM / CONCORD. 9.9 MI. AT ROUNDABOUT, TAKE 1ST EXIT ONTO RT-125 N / CALEF RD. 3.2 MI. TURN RIGHT ONTO BUMFORD RD. ARRIVE AT SITE AT END OF THE ROAD.

APPROVED BY THE BARRINGTON PLANNING BOARD CHAIRMAN RECORDING AGENT

PROJECT DESCRIPTION

THIS FACILITY WILL CONSUME NO UNRECOVERABLE ENERGY.

NO WASTE WATER WILL BE GENERATED AT THIS LOCATION.

NO SOLID WASTE WILL BE GENERATED AT THIS LOCATION

PER MONTH AT ONE HOUR PER VISIT.

NO POTABLE WATER SUPPLY IS TO BE PROVIDED AT THIS LOCATION.

CELLULAR SERVICE.

THIS IS AN UNMANNED AND RESTRICTED ACCESS EQUIPMENT SITE AND WILL BE USED FOR THE TRANSMISSION OF RADIO SIGNALS FOR THE PURPOSE OF PROVIDING PUBLIC

MAINTENANCE CREW (TYPICALLY ONE PERSON) WILL MAKE AN AVERAGE OF ONE TRIP

DO NOT SCALE DRAWINGS


LAND USE OFFICE


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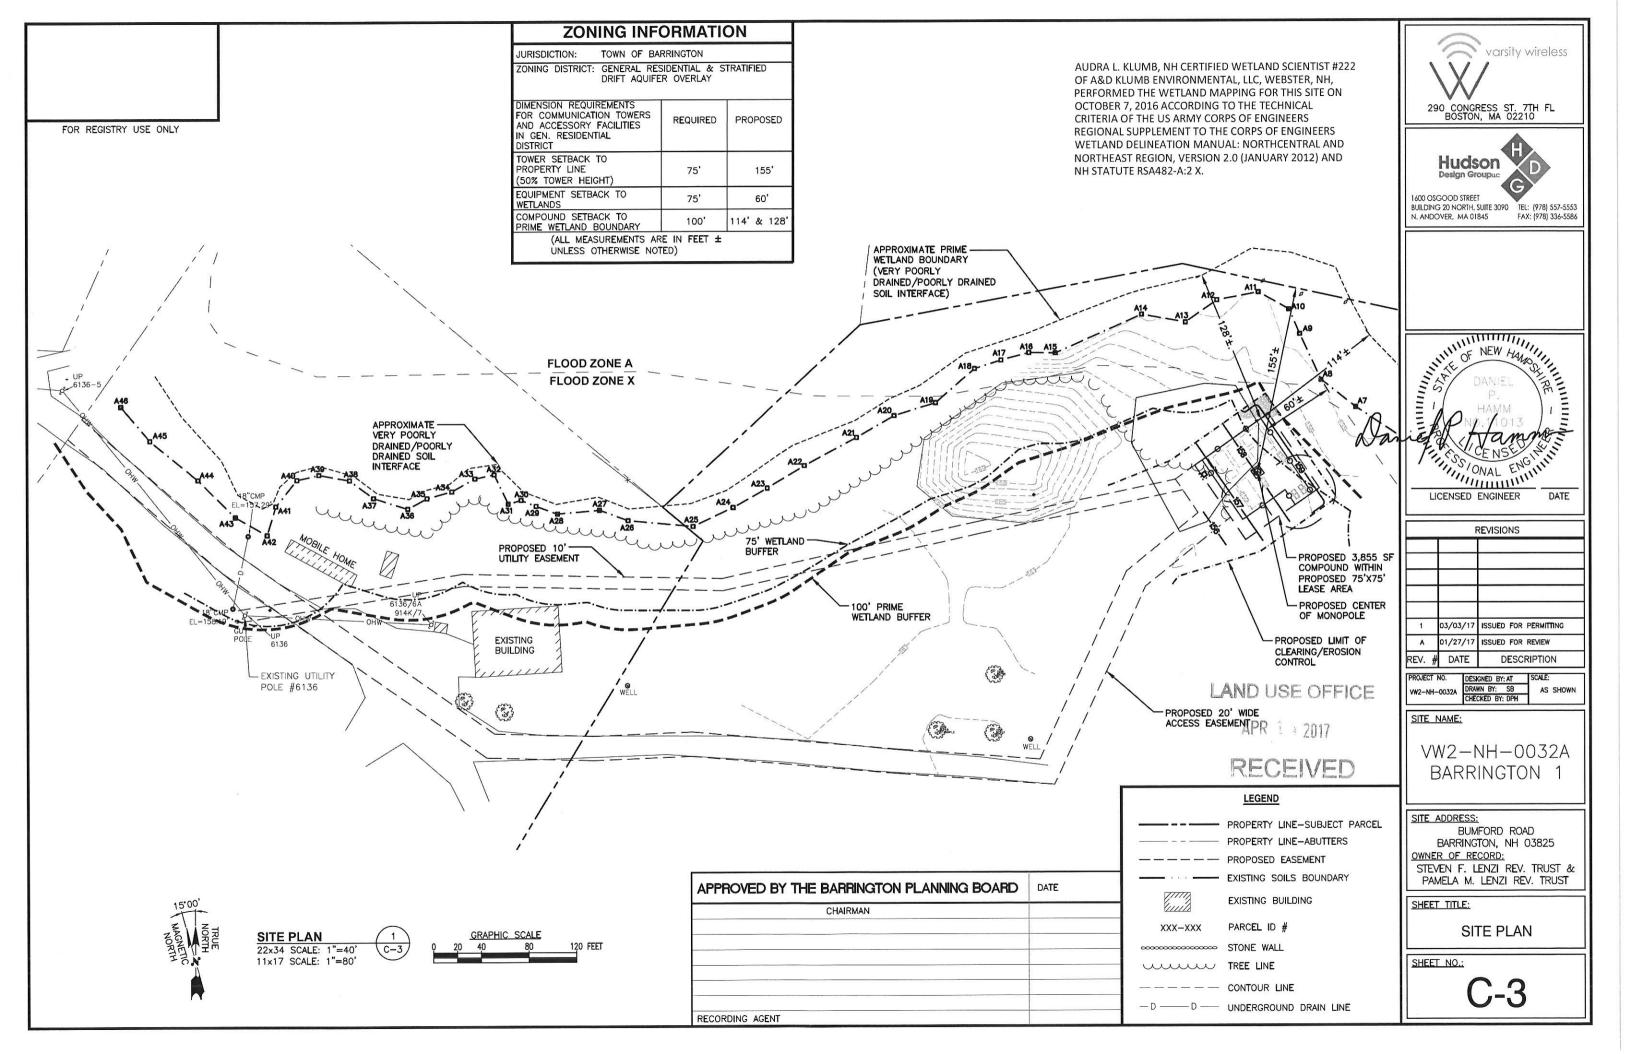
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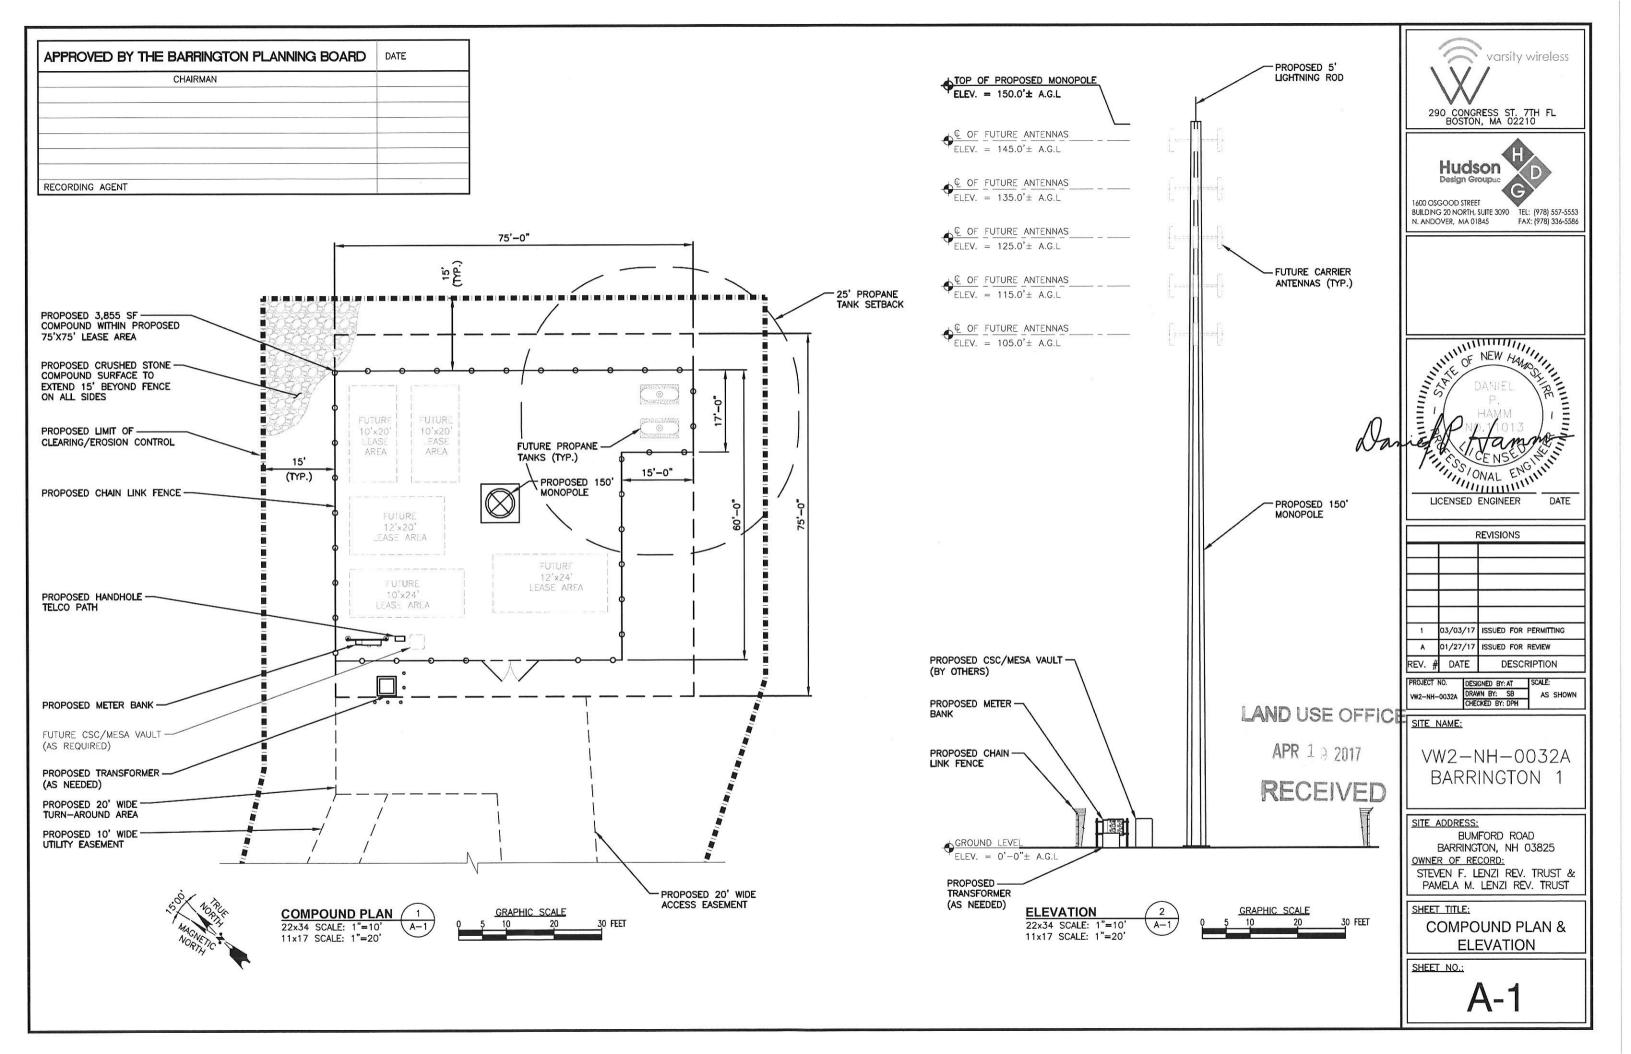
CONTRACTOR SHALL VERIFY ALL PLANS AND EXISTING DIMENSIONS AND


CONDITIONS ON THE JOB SITE AND SHALL IMMEDIATELY NOTIFY THE PROJECT OWNER'S REPRESENTATIVE IN WRITING OF DISCREPANCIES BEFORE PROCEEDING WITH THE WORK OR BE RESPONSIBLE FOR SAME.






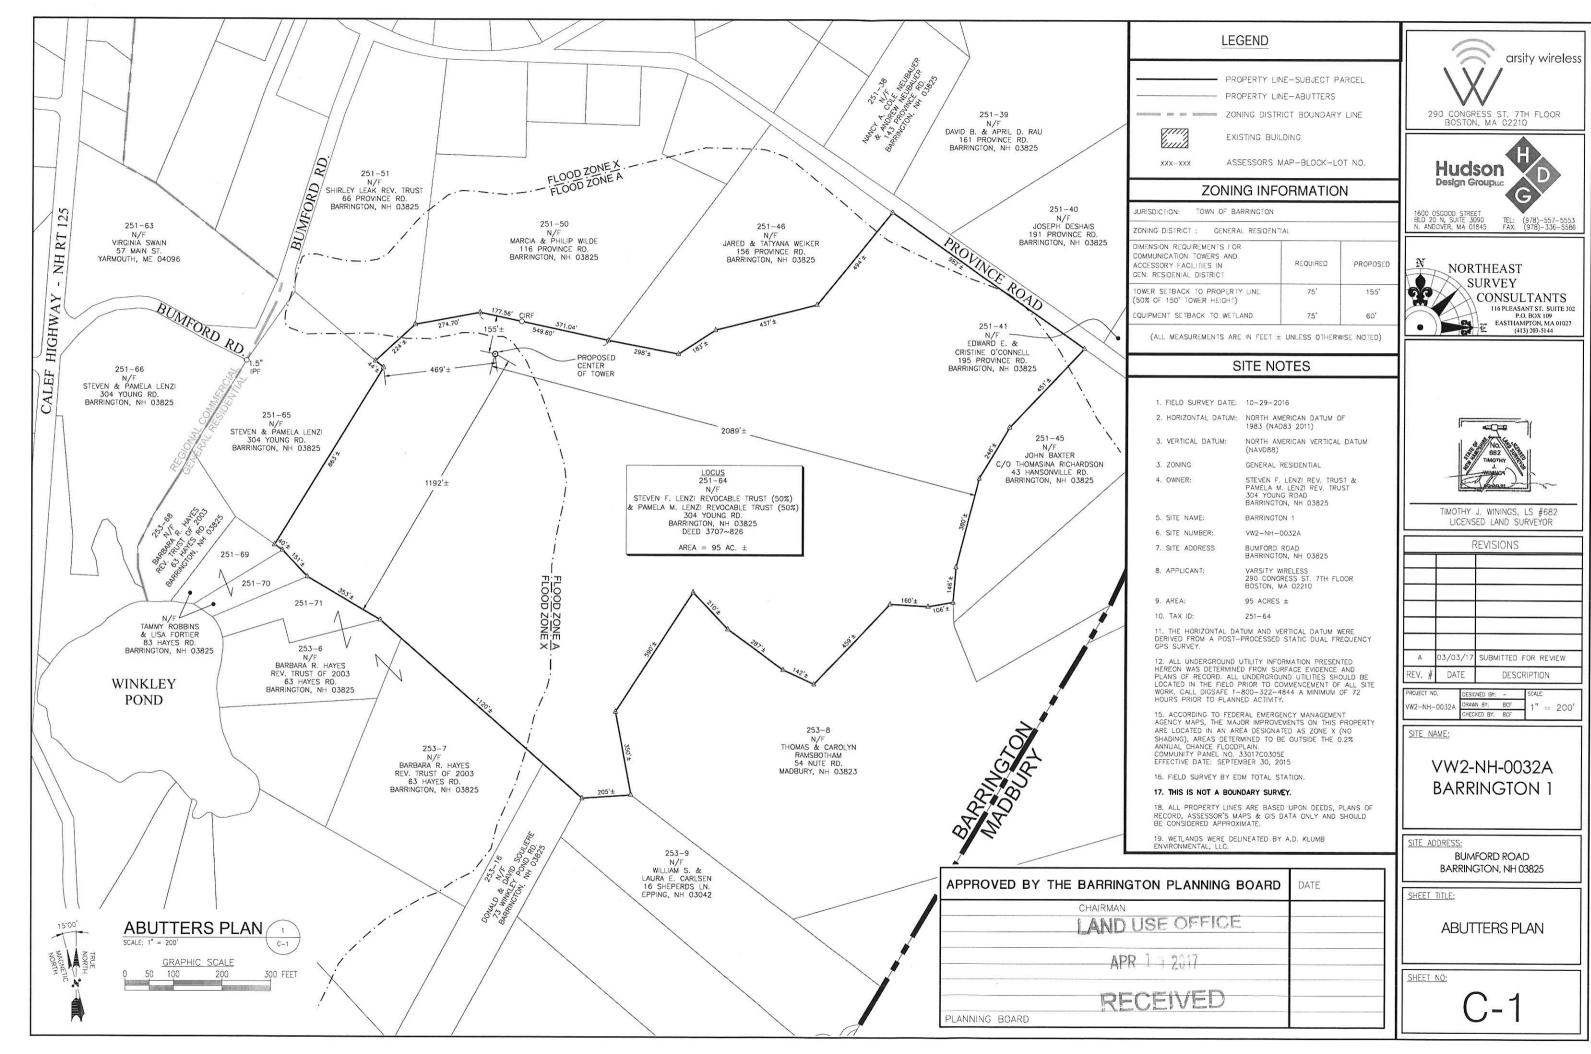

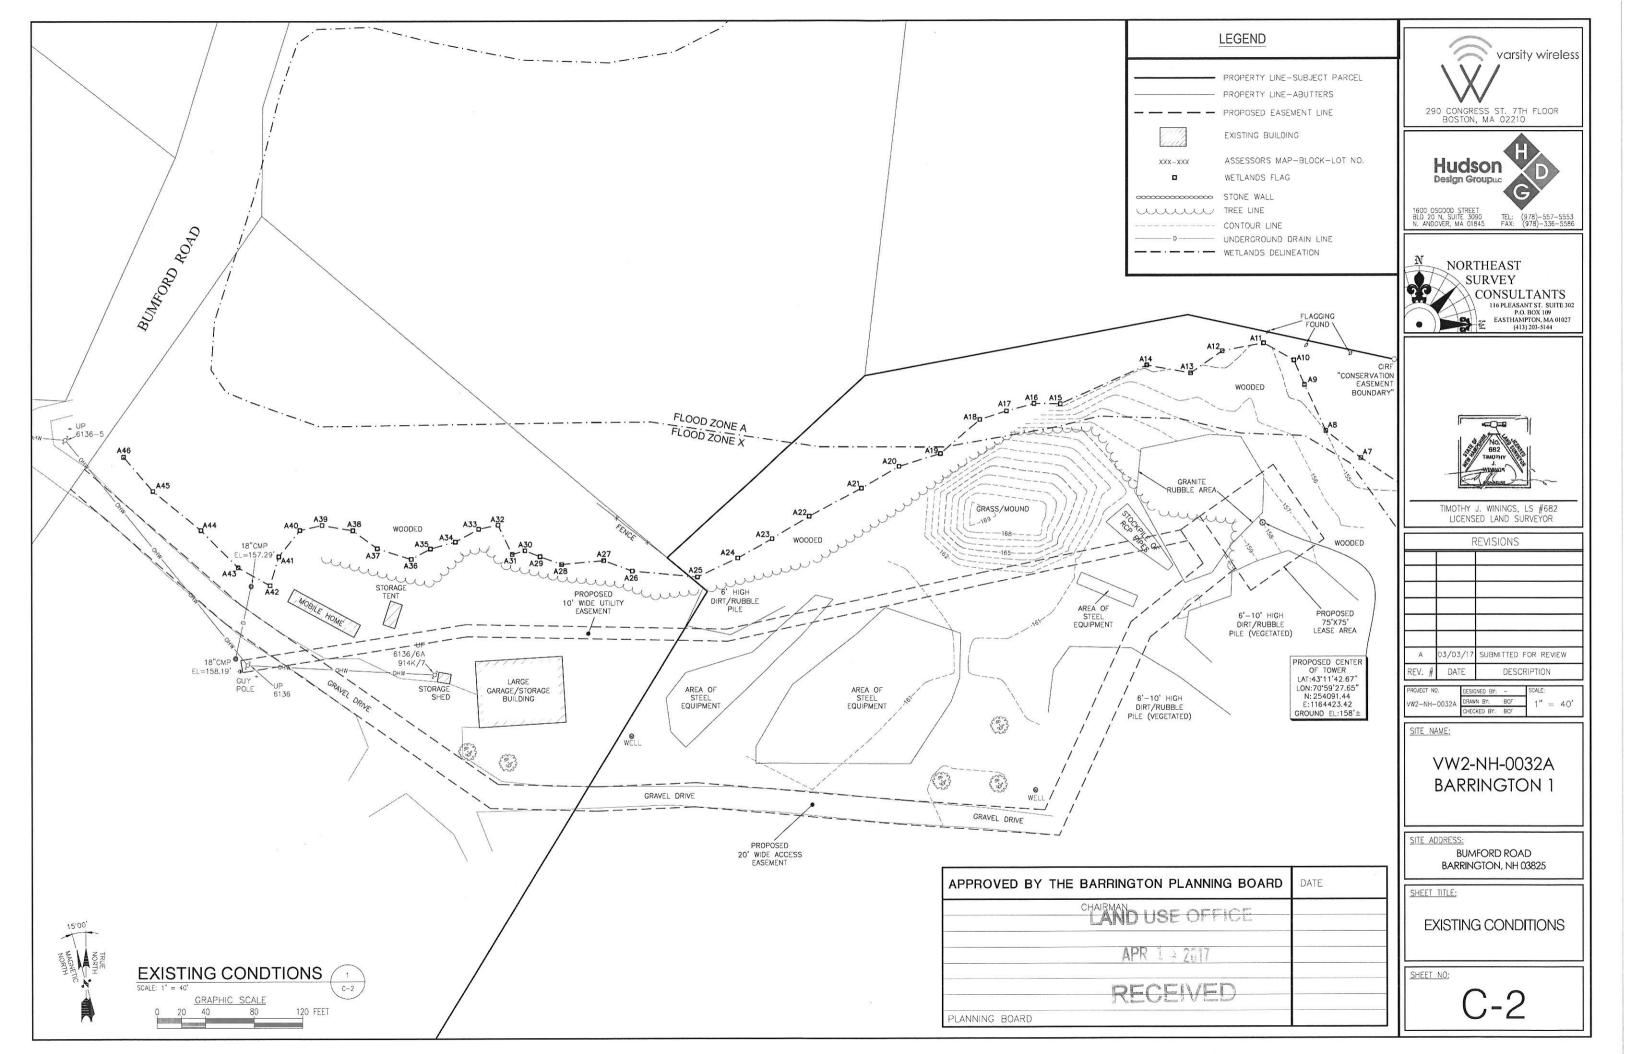

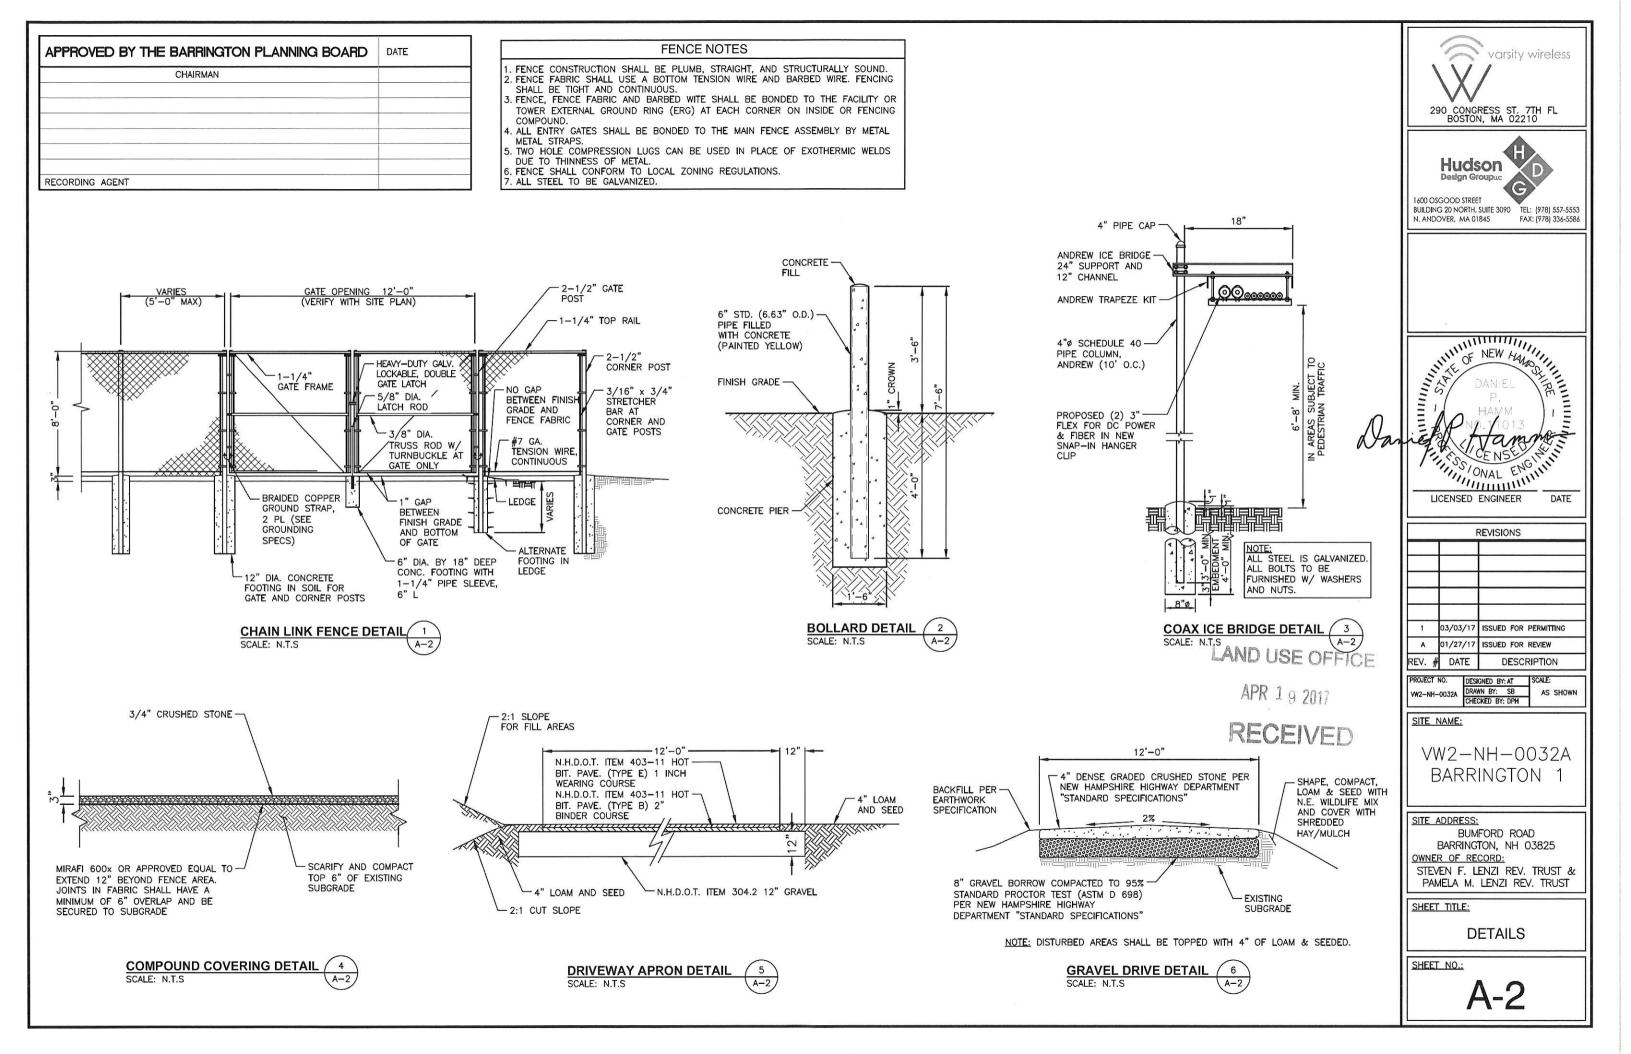

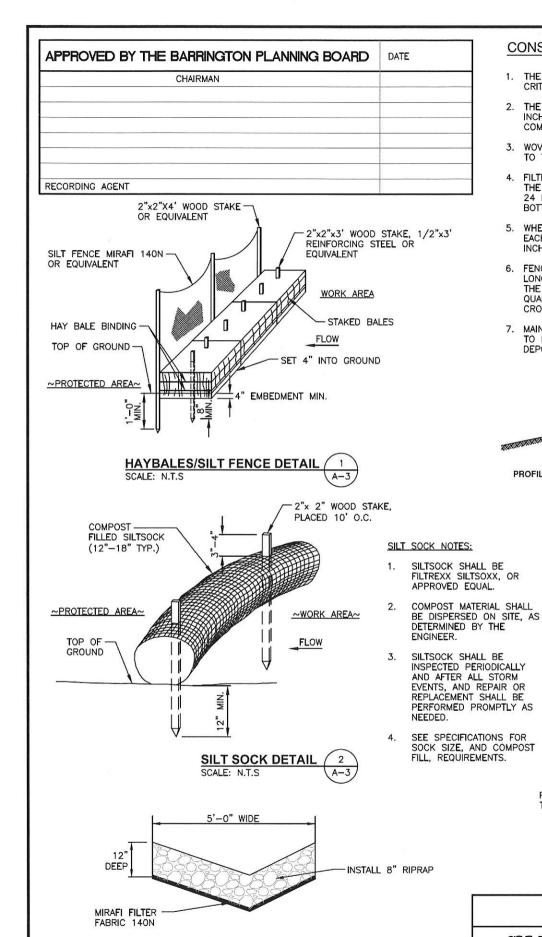


RIP-RAP LINED ROADSIDE


INFILTRATION DITCH

SCALE: N.T.S.

CONSTRUCTION SPECIFICATIONS - SILT FENCE

- 1. THE GEOTEXTILE FABRIC SHALL MEET THE DESIGN CRITERIA FOR SILT FENCES.
- 2. THE FABRIC SHALL BE EMBEDDED A MINIMUM OF 8 INCHES INTO THE GROUND AND THE SOIL COMPACTED OVER THE EMBEDDED FABRIC
- 3. WOVEN WIRE FENCE SHALL BE FASTENED SECURELY TO THE FENCE POSTS WITH WIRE TIES OR STAPLES.
- FILTER CLOTH SHALL BE FASTENED SECURELY TO THE WOVEN WIRE FENCE WITH TIES SPACED EVERY 24 INCHES AT THE TOP, MID-SECTION AND
- WHEN TWO SECTIONS OF FILTER CLOTH ADJOIN EACH OTHER, THEY SHALL BE OVERLAPPED BY 6 INCHES, FOLDED, AND STAPLED
- 6. FENCE POSTS SHALL BE A MINIMUM OF 36 INCHES LONG AND DRIVEN A MINIMUM OF 16 INCHES INTO THE GROUND. WOOD POSTS SHALL BE OF SOUND QUALITY HARDWOOD AND SHALL HAVE A MINIMUM CROSS SECTIONAL AREA OF 3.0 SQUARE INCHES
- 7. MAINTENANCE SHALL BE PERFORMED AS NEEDED TO PREVENT BULGES IN THE SILT FENCE DUE TO DEPOSITION OF SEDIMENT.

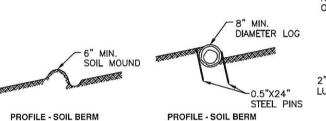

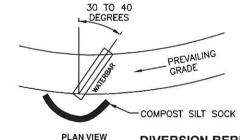

DIVERSION BERM DETAIL

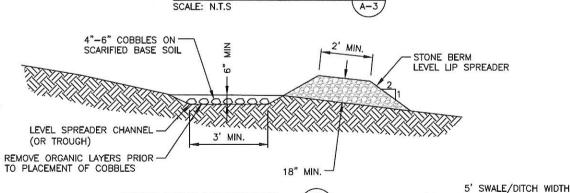


TABLE 4-13: GRADATION OF STONE

SCALE: N.T.S

LEVEL SPREADER DETAIL

FOR LEVEL SPREADER BERM				
SIEVE DESIGNATION	% BY WEIGHT PASSING SQUARE MESH SIEVE			
12-INCH	100%			
6-INCH	84%-100%			
3-INCH	68%-83%			
1-INCH	42%-55%			
NO. 4	8%-12%			

MAINTENANCE - SILT FENCE

- 1. SILT FENCES SHALL BE INSPECTED IMMEDIATELY AFTER EACH RAINFALL AND AT LEAST DAILY DURING PROLONGED RAINFALL. ANY REPAIRS THAT ARE REQUIRED SHALL BE MADE IMMEDIATELY.
- 2. IF THE FABRIC ON A SILT FENCE SHOULD DECOMPOSE OR BECOME INEFFECTIVE DURING THE EXPECTED LIFE OF THE FENCE, THE FABRIC SHALL BE REPLACED PROMPTLY.
- SEDIMENT DEPOSITS SHOULD BE INSPECTED AFTER EVERY STORM EVENT. THE DEPOSITS SHOULD BE REMOVED WHEN THEY REACHED APPROXIMATELY ONE-HALF THE HEIGHT OF THE BARRIER.
- 4. SEDIMENT DEPOSITS THAT ARE REMOVED OR LEFT IN PLACE AFTER THE FABRIC HAS BEEN REMOVED SHALL BE GRADED TO CONFORM WITH THE EXISTING TOPOGRAPHY AND VEGETATED
- 5. REMOVE ALL SEDIMENTATION CONTROLS AFTER SOIL IS STABILIZED.

%" THICK, 7"H RUBBER STOP OR BLADE USE 16 PENNY GALVANIZED NAILS BEND ENDS OVER 2"X6" P.T WITH HAMMER LUMBER TOP ROW: NAIL 3" O.C. MIDDLE ROW: NAIL 6" O.C. PROFILE - RUBBER BAR BERM BOTTOM ROW: NAIL 12" O.C. NOTES:

2' WIDE

END VIEW

OPEN TOP BOX TO BE CONSTRUCTED FROM 2" THICK WOOD.

TOTAL HEIGHT

EQUAL TO

MAX. DITCH

DEPTH

SHAPED CHECK DAM TO

BE LOCATED UPGRADIENT

OF STONE BERM LEVEL SPREADER ENTRANCES

NOTE

- INSTALL BARS AT LOCATIONS INDICATED ON **PLANS**
- SOIL MOUNDED WATERBAR SHALL CONSIST OF A 6" MOUND OF COMPACTED SOIL IMMEDIATELY DOWNGRADIENT OF TROUGH

8. AFTER ALL DISTURBED AREAS HAVE BEEN STABILIZED THE TEMPORARY EROSION CONTROL MEASURES ARE TO BE REMOVED 9. ALL CATCH BASIN INLETS WILL BE PROTECTED WITH

SLOPE MIX (SLOPES GREATER THAN 4:1) LBS./ACRE

EROSION CONTROL MEASURES:

AND ASSOCIATED DRAINAGE FACILITIES

DISTURBED AREAS SHALL BE KEPT TO THE MINIMUM

AREA NECESSARY TO CONSTRUCT THE ROADWAYS

2. HAY BALE BARRIERS AND SEDIMENT TRAPS SHALL BE

INSTALLED AS REQUIRED BARRIERS AND TRAPS

ARE TO BE MAINTAINED AND CLEANED UNTIL ALL

NOXIOUS WEEDS OR WOODY STEMS, AND SHALL BE

SLOPES HAVE A HEALTHY STAND OF GRASS.

3. BALED HAY AND MULCH SHALL BE MOWINGS OF ACCEPTABLE HERBACEOUS GROWTH, FREE FROM

4. FILL MATERIAL SHALL BE FREE FROM STUMPS.

UNTIL ALL MATERIAL HAS BEEN PLACED OR

SEED PER 50 SQUARE YARDS OF AREA.

ALL DISTURBED AREAS SHALL BE LOAMED AND SEEDED. A MINIMUM OF 4 INCHES OF LOAM SHALL

APPLICATION OF GRASS SEED, FERTILIZERS AND

MULCH SHALL BE ACCOMPLISHED BY BROADCAST

5. STOCKPILED MATERIALS SHALL BE PLACED ONLY IN

AREAS SHOWN ON THE PLANS. STOCKPILES SHALL

BE PROTECTED BY SILTATION FENCE AND SEEDED TO

PREVENT EROSION. THESE MEASURES SHALL REMAIN

BE INSTALLED WITH NOT LESS THAN ONE POUND OF

75-100 LBS./1,000 SQUARE

MANUFACTURER.
HAY MULCH APPROXIMATELY

TONS/ACRE UNLESS EROSION

LBS./ACRE

20

20

42

20

20

<u>8</u> 48

CONTROL MATTING IS USED.

RATE RECOMMENDED BY

DRY. NO SALT HAY SHALL BE USED.

WOOD, ROOTS, ETC.

DISPOSED OFF SITE.

LIMESTONE:

FERTILIZER

SEED MIX (SLOPES LESS THAN 4:1)

TALL FESCUE

TALL FESCUE RED TOP


TOTAL

CREEPING RED FESCUE

CREEPING RED FESCUE

MULCH:

- LOW POINT SEDIMENTATION BARRIER.
- 10. ALL STORM DRAINAGE OUTLETS WILL BE STABILIZED AND CLEANED AS REQUIRED, BEFORE THE DISCHARGE POINTS BECOME OPERATIONAL
- 11. ALL DEWATERING OPERATIONS MUST DISCHARGE DIRECTLY INTO A SEDIMENT FILTER AREA.
- 12. NO DISCHARGE SHALL BE DIRECTED TOWARDS ANY PROPOSED DITCHES, SWALES, OR PONDS UNTIL THEY HAVE BEEN PROPERLY STABILIZED.

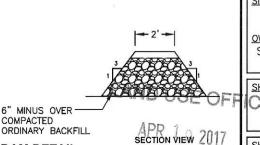


CHECK DAM DETAIL (PER NHDES)

SCALE: N.T.S

varsity wireless 290 CONGRESS ST. 7TH FL BOSTON, MA 02210



600 OSGOOD STREET BUILDING 20 NORTH, SUITE 3090 TEL: (978) 557-5553 N. ANDOVER, MA 01845 FAX: (978) 336-5586

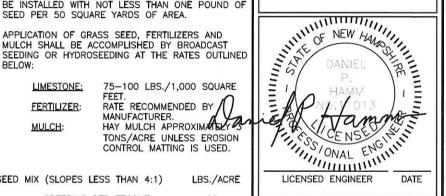

	REVISIONS				
1	03/03/17	ISSUED FOR PERMITTING			
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OJECT NO.	DESIGNED BY: AT	SCALE:	
	DRAWN BY: SB	AS SHOW	
12 HIT 0002A	CHECKED BY: DPH	7	

SITE NAME:

VW2-NH-0032A BARRINGTON '

SITE ADDRESS: BUMFORD ROAD BARRINGTON, NH 03825 OWNER OF RECORD: STEVEN F. LENZI REV. TRUST & PAMELA M. LENZI REV. TRUST

SHEET TITLE: CEROSION CONTROL

DETAILS & NOTES

SHEET NO .: