
BARRINGTON TOWN OFFICES RAMSDELL LANE BARRINGTON, NH

TAX MAP/LOT: 233/000044

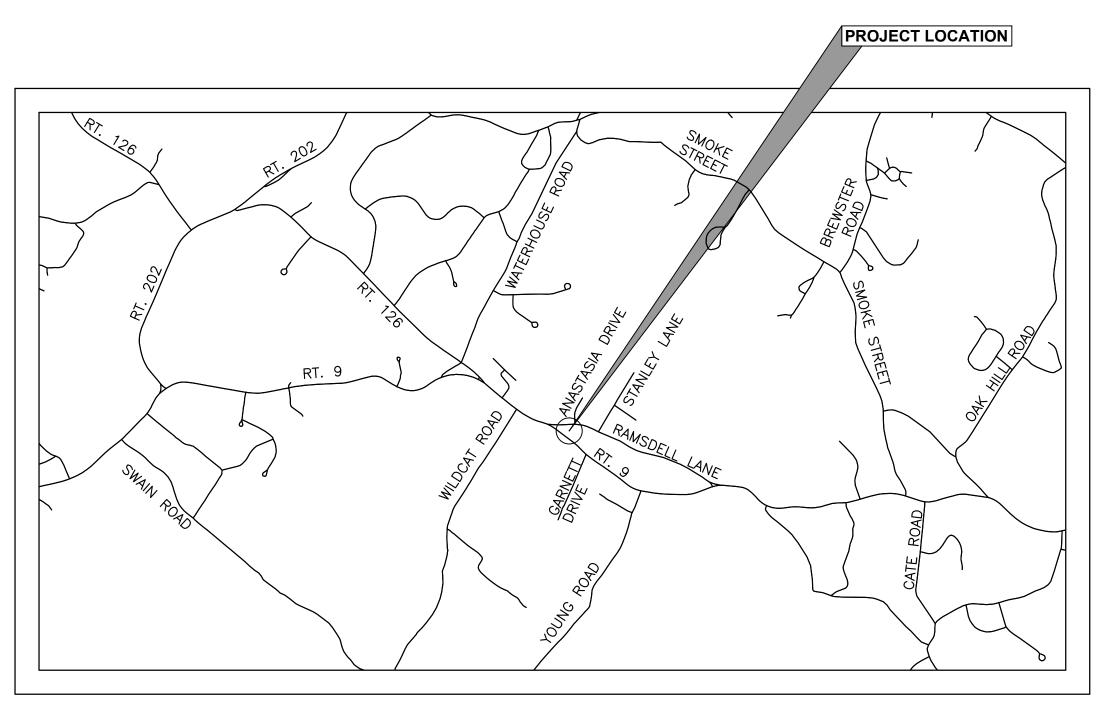

VICINITY MAP SCALE: 1'' = 2,500'

DRAWING LIST				
SHEET NUMBER DRAWING		TITLE		
1	G1.1	COVER		
2	EC	EXISTING CONDITIONS		
3	D1.1	DEMOLITION PLAN		
4	C1.1	SITE LAYOUT PLAN		
5	C1.2	GRADING AND DRAINAGE PLAN		
6	C1.3	UTILITY PLAN		
7–11	C1.4-1.8	DETAILS		
12	C2.1	WASTEWATER PLAN AND PROFILE		
13	C2.2	WASTEWATER DETAILS		

NOT FOR CONSTRUCTION PRELIMINARY PLANS

GENERAL NOTES

APPLICANT/OWNER: THE TOWN OF BARRINGTON P.O. BOX 660 333 CALEF HIGHWAY

- 1. PURPOSE OF THESE PLANS IS TO CONSTRUCT AN 11,820 SF TOWN OFFICE BUILDING (10,472 SF FOOTPRINT)
- 2. LOT SHOWN ON ASSESSOR'S MAP 233-BLOCK-LOT 0044, 137 RAMSDELL LANE, IN THE TOWN OF BARRINGTON, OF STRAFFORD COUNTY, AND OF THE STATE OF NEW HAMPSHIRE
- 3. LOT AREA APPROX. 5.48 AC.
- 4. ZONING DESIGNATION: NEIGHBORHOOD RESIDENTIAL (NR)

5. ZONING REQUIREMENTS:

- 6. THE EXISTING PARCEL IS CURRENTLY IMPROVED WITH AN ABANDONED 2 STORY BRICK STRUCTURE FORMERLY HOUSING THE BARRINGTON TOWN OFFICES, AS WELL AS A PLAYGROUND AND ATHLETIC FIELDS USED BY THE BARRINGTON SCHOOL DISTRICT. THE PROPOSED USE OF THE PARCEL IS TO CONSTRUCT A NEW TOWN OFFICE
- MEETING ROOM: 1 SPACE/4 SEATS X 85 SEATS = 21.3 ≈ 21 SPACES (MEETING ROOM IS INTENDED FOR USE AFTER OFFICE BUILDING IS CLOSED, THEREFORE 39 SPACES ARE REQUIRED FOR THE MORE INTENSE OF THE TWO (2) USES. SPACES REQUIRED: 39 SPACES SPACES PROVIDED: 50 SPACES (INCLUDING 3 ACCESSIBLE)
- 8. LOT COVERAGE (% IMPERVIOUS SURFACE): EXISTING= 27% PROPOSED=23%
- 9. SANITARY SEWER SOURCE: ON-SITE PRIVATE SEPTIC
- 10. WATER SUPPLY SOURCE: ON-SITE DRILLED WELL
- 11. NO ZONING VARIANCES OR SPECIAL EXCEPTIONS HAVE BEEN INDENTIFIED AT THE TIME OF SUBMITTAL:
- 12. FEMA FLOOD INSURANCE RATE MAP 33017C0285D, EFFECTIVE 5/17/2005
- 13. PERMITS REQUIRED BY THE TOWN OF BARRINGTON: PUBLIC WATER SUPPLY
- 14. THE FOLLOWING WAIVERS ARE REQUESTED FROM THE SITE PLAN REVIEW REGULATIONS: 4.9.2(1) TO ALLOW PARKING WITHIN THE FRONT SETBACK
- 15. CONSTRUCTION ASSUMED TO COMMENCE IN SUMMER OF 2015.
- 16. IF, DURING CONSTRUCTION, IT BECOMES APPARENT THAT DEFICIENCIES EXIST IN THE APPROVED DESIGN DRAWINGS, THE OWNER SHALL BE REQUIRED TO CORRECT THE DEFICIENCIES TO MEET THE REQUIREMENTS OF THE REGULATIONS AT NO EXPENSE TO THE TOWN.
- 17. IF, DURING CONSTRUCTION, IT BECOMES APPARENT THAT ADDITIONAL EROSION CONTROL MEASURES ARE REQUIRED TO STOP ANY EROSION ON THE CONSTRUCTION SITE DUE TO ACTUAL SITE CONDITIONS, THE OWNER SHALL BE REQUIRED TO INSTALL THE NECESSARY EROSION PROTECTION AT NO EXPENSE TO THE TOWN.
- 18. ALL MATERIALS AND METHODS OF CONSTRUCTION SHALL CONFORM TO THE TOWN REGULATIONS AND THE LATEST EDITION OF THE NEW HAMPSHIRE DEPARTMENT OF TRANSPORTATION'S STANDARD SPECIFICATIONS FOR ROAD AND BRIDGE CONSTRUCTION.
- 19. IN ACCORDANCE WITH TOWN REGULATIONS AND RSA 676:13, ALL IMPROVEMENTS SPECIFIED ON THESE SITE PLANS SHALL BE CONSTRUCTED, COMPLETED, INSPECTED AND APPROVED BY THE TOWN OF BARRINGTON PRIOR TO THE ISSUANCE OF A CERTIFICATE OF OCCUPANCY.

APPROVED BY BARRINGTON PLANNING BOARD:


CHAIRMAN DATE

3/4/2015 | GENERAL REVISIONS, ADD SHEETS C1.5-1.8 | MEF | MTC DESCRIPTION

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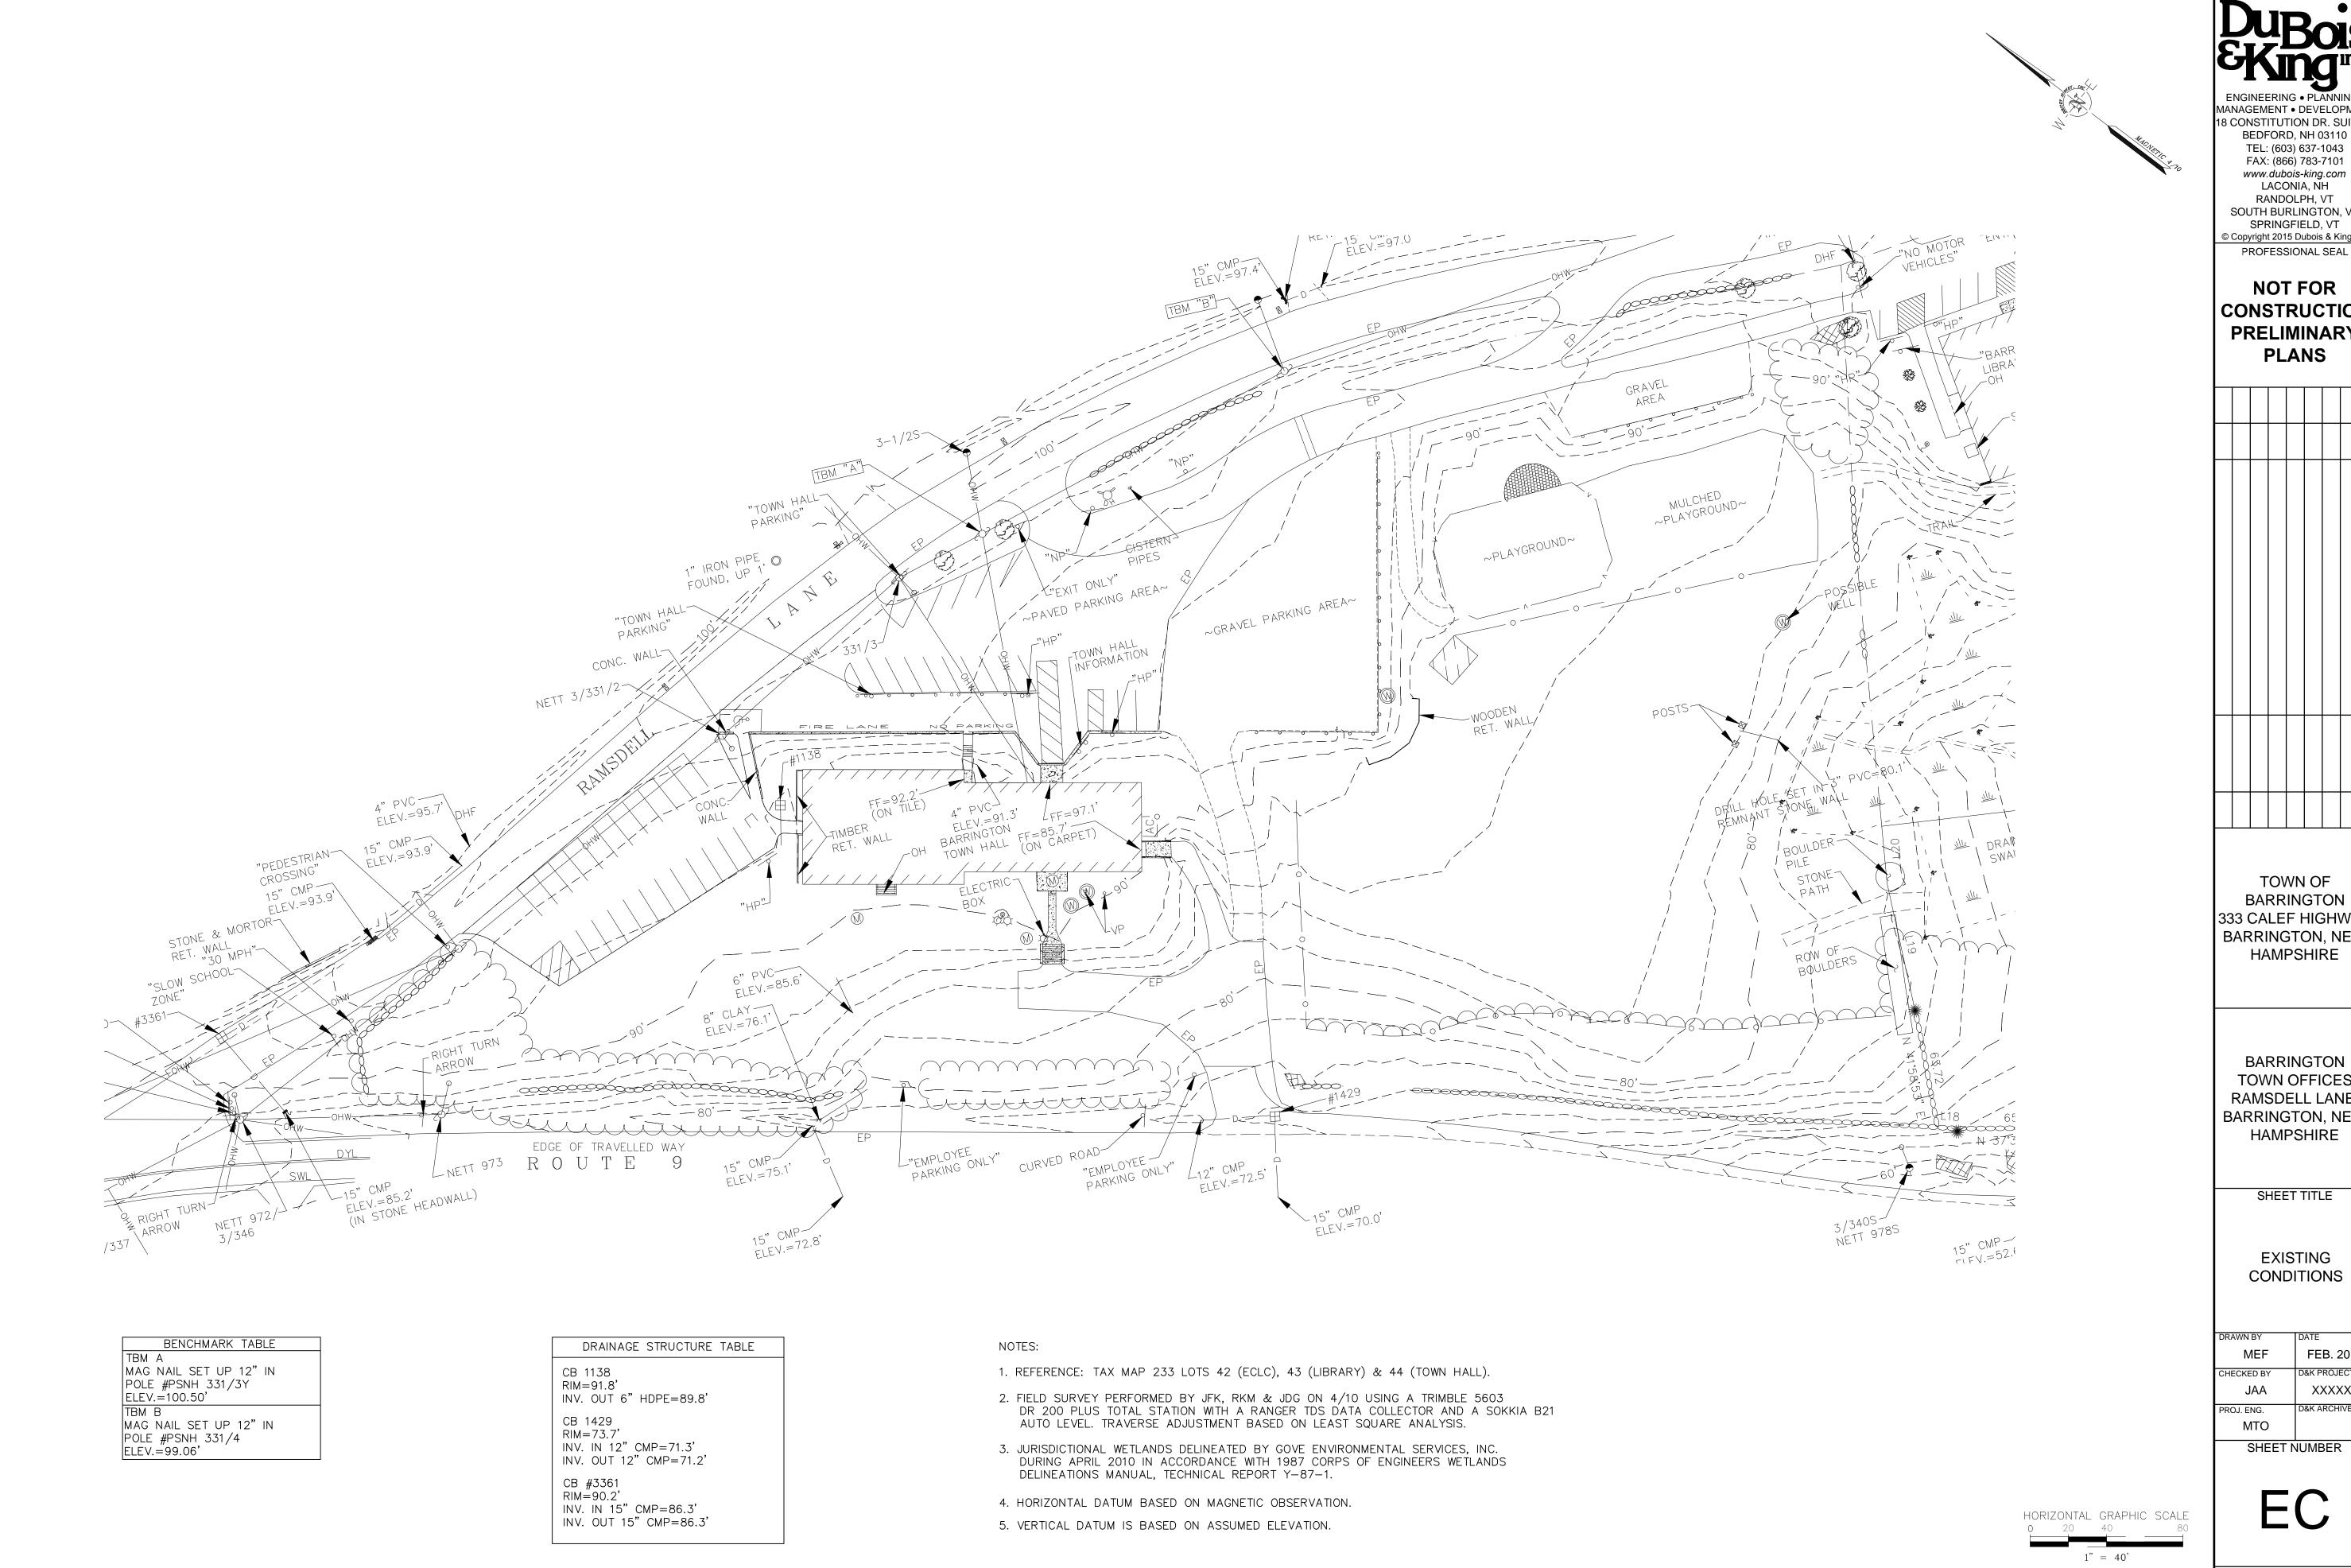
SHEET 1 OF 13



LOCUS MAP

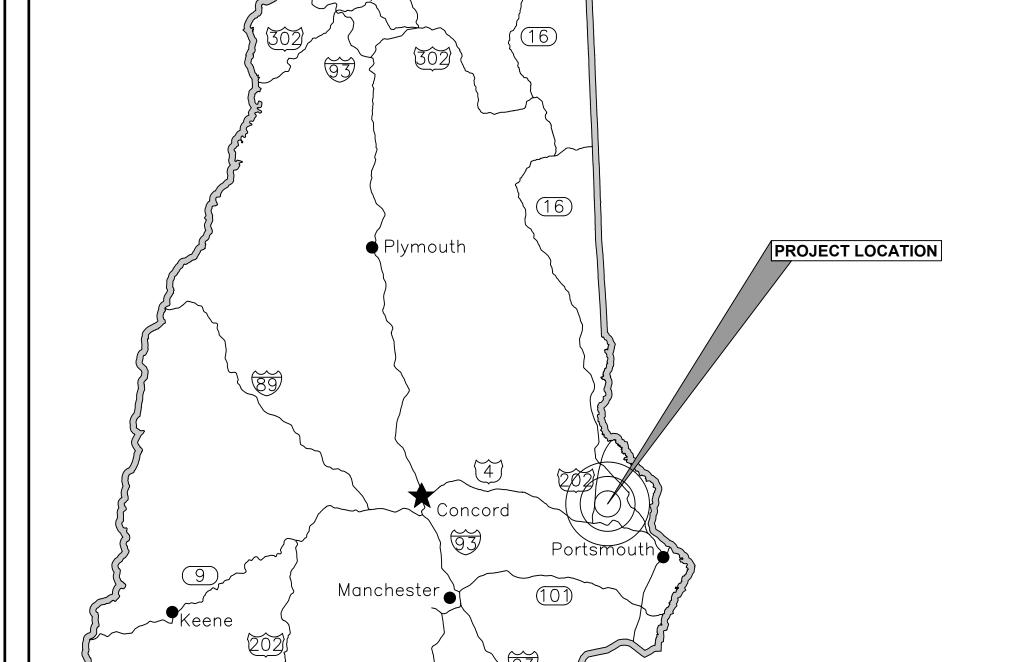
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NOT FOR CONSTRUCTION **PRELIMINARY PLANS**



TOWN OF BARRINGTON 333 CALEF HIGHWAY BARRINGTON, NEW HAMPSHIRE

BARRINGTON **TOWN OFFICES** RAMSDELL LANE, BARRINGTON, NEW HAMPSHIRE

SHEET TITLE

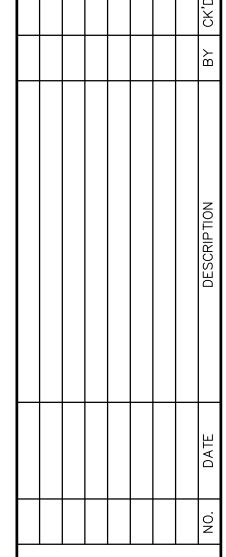EXISTING CONDITIONS

DRAWN BY	DATE
MEF	FEB. 2015
CHECKED BY	D&K PROJECT #
JAA	XXXXXX
PROJ. ENG.	D&K ARCHIVE #
MTO	

SHEET NUMBER

SHEET 2 OF 13

CIVIL DEMOLITION NOTES:

- 1. PRIOR TO THE COMMENCEMENT OF CONSTRUCTION OR SITE CLEARING, THE LIMIT OF WORK SHALL BE CLEARLY MARKED IN THE FIELD (VIA DEMARCATION FENCE) BY THE CONTRACTOR AT 50-F00T (\pm) INTERVALS. THE CONTRACTOR SHALL BE RESPONSIBLE FOR ALL WORK WITHIN THE LIMIT OF WORK AND IS PROHIBITED FROM USING ANY AREA LOCATED OUTSIDE OF SUCH LIMIT.
- 2. IN THE EVENT LEDGE REMOVAL IS REQUIRED (VIA BLASTING OR JACK—HAMMERING) THE CONTRACTOR SHALL BE RESPONSIBLE FOR CREATING AN EXISTING CONDITIONS FILE CONSISTING OF VIDEO, PHOTOGRAPHS AND DOCUMENTATION OF THE PROJECT SITE AND ABUTTING EXISTING FEATURE(S), INCLUDING BUT NOT LIMITED TO, ABUTTERS LOCATED ACROSS ALL STREETS WITHIN THE VICINITY OF THE PROJECT SITE.
- 3. THE CONTRACTOR SHALL BE RESPONSIBLE FOR THE PREVENTION OF EROSION. ALL DISTURBED AREAS SHALL BE STABILIZED IN THE SHORTEST PRACTICAL TIME AND TEMPORARY CONTROL DEVISES SHALL BE DEPLOYED UNTIL SUCH TIME AS ADEQUATE SOIL STABILIZATION HAS BEEN ACHIEVED. TEMPORARY STORAGE OF EXCAVATED MATERIALS SHALL BE MANAGED IN A MANNER THAT WILL MINIMIZE EROSION. SEE EROSION CONTROL PLAN AND EROSION CONTROL NOTES & DETAIL SHEET FOR SUPPLEMENTAL INFORMATION.
- 4. SUITABLE EXCAVATED MATERIALS MAY BE INCORPORATED INTO THE PROJECT. THIS PROVISION SHALL IN NO WAY RELIEVE THE CONTRACTOR'S OBLIGATIONS TO REMOVE AND DISPOSE OF ANY MATERIAL DETERMINED BY THE ENGINEER TO BE UNSUITABLE FOR BACKFILLING OR EXCESS SUITABLE MATERIAL. ALL DISPOSED MATERIAL SHALL BE IN ACCORDANCE TO ALL LOCAL, STATE AND FEDERAL LAWS.

5. ALL EXCAVATION SHALL BE PERFORMED IN ACCORDANCE WITH O.S.H.A. STANDARDS, AS WELL AS ADDITIONAL PROVISIONS TO ASSURE STABILITY OF CONTIGUOUS STRUCTURES.

REMAIN -

6. THE CONTRACTOR SHALL FIELD VERIFY LOCATION OF ALL EXISTING UTILITIES PRIOR TO CONSTRUCTION ACTIVITIES.

SUGGESTED CONSTRUCTION SEQUENCE:

- 1. CLEAR AND GRUB ONLY TO THE LIMITS OF CUT AND FILL. COORDINATES IDENTIFIED ON THIS PLAN ARE FOR REFERENCE ONLY AND ARE NOT INTENDED FOR EXACT CLEARING LIMITS.
- 2. CONSTRUCT TEMPORARY AND PERMANENT EROSION AND SEDIMENTATION CONTROL FACILITIES PRIOR TO THE COMMENCEMENT OF CONSTRUCTION ACTIVITIES. EROSION AND SEDIMENTATION CONTROL DEVICES SHALL BE MAINTAINED FOR THE DURATION OF THE CONSTRUCTION. SEE EROSION AND SEDIMENTATION CONTROL PLAN, NOTES & DETAIL SHEETS.
- 3. PERFORM ANY ALL DEMOLITION ACTIVITIES.
- 4. REMOVE TOPSOIL FOR ITS TOTAL DEPTH WITHIN THE LIMITS OF DISTURBED AREA. UNLESS OTHERWISE DIRECTED, CONTRACTOR SHALL STOCKPILE TOPSOIL AND USE ON THIS PROJECT AS NEEDED IN ACCORDANCE WITH

<PROJECT SPECIFICATIONS / NHDOT SECTION 641 - LOAM AND/OR NHDOT SECTION 647 - HUMUS>.


- 5. CONSTRUCT EMBANKMENT AND SUBGRADE AREAS, INCLUDING ALL REPAIRS AS SHOWN ON THIS PLAN SET; INSTALL UTILITIES.
- 6. GRADE PROJECT SITE. PLACE TEMPORARY (AND PERMANENT, IF FEASIBLE) LOAM, SEED AND MULCH ON ALL DISTURBED AREAS IMMEDIATELY AFTER CONSTRUCTION OF SAID AREAS.
- 7. PLACE RIGID CONCRETE AND BITUMINOUS CONCRETE PAVEMENT BASE COURSES.
- 8. PLACE RIGID CONCRETE AND BITUMINOUS CONCRETE PAVEMENT.
- 9. COMPLETE PERMANENT SEEDING ON ALL DISTURBED AREAS AND LANDSCAPING PLANTINGS.
- 10. REMOVE TEMPORARY CONTROL MEASURES AND ACCOMPLISH FINAL CLEAN-UP.

ENGINEERING PLANNING

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NOT FOR
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PLANS

PROFESSIONAL SEAL

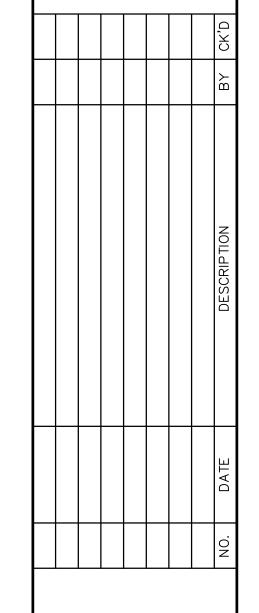

TOWN OF BARRINGTON 333 CALEF HIGHWAY BARRINGTON, NEW HAMPSHIRE

BARRINGTON TOWN OFFICES RAMSDELL LANE, BARRINGTON, NEW HAMPSHIRE

SHEET TITLE

DEMOLITION PLAN

DRAWN BY	DATE		
MEF	FEB. 2015		
CHECKED BY	D&K PROJECT#		
JAA	XXXXXX		
PROJ. ENG.	D&K ARCHIVE #		
MTO			
	MEF CHECKED BY JAA PROJ. ENG.		

SHEET NUMBER

D1.1

SHEET 3 OF 13

HORIZONTAL GRAPHIC SCALE
0 20 40 80

1" = 40'

- 1. THE APPLICANT SHALL (QUARTERLY BASIS) INSPECT AND RECORD FINDINGS OF ALL DRAINAGE STRUCTURES, PIPES, OUTLETS AND PONDS TO ENSURE THAT ALL DRAINAGE ITEMS ARE FREE FROM DEBRIS AND IN STABLE CONDITION. IN THE EVENT THAT DRAINAGE ITEMS ARE DETERMINED TO BE IN UNSATISFACTORY CONDITION, THE OWNER SHALL RECORD THE UNSATISFACTORY ISSUE, THE DATE OF THE UNSATISFACTRY FINDING, THE APPROPRIATE CORRECTIVE MEASURE AND THE DATE THE CORRECTIVE MEASURE WAS COMPLETED.
- 2. THE APPLICANT SHALL (ANNUAL BASIS) SWEEP, COLLECT AND REMOVE WINTER MAINTENANCE SAND, LITTER, SALT, ETC. OF ALL PAVED AND CONCRETE AREAS.
- 3. THE APPLICANT SHALL (ANNUAL BASIS) INSPECT AND RECORD FINDINGS OF ALL APPARENT EROSION PROBLEMS, DESTABILIZATION OF SIDE SLOPES, EMBANKMENT SETTLING AND OTHER STURCTURAL FAILURES. IN THE EVENT THAT ITEMS ARE DETERMINED TO BE IN UNSATISFACTORY CONDITION, THE OWNER SHALL RECORD THE UNSATISFACTORY ISSUE, THE DATE OF THE UNSATISFACTRY FINDING, THE APPROPRIATE CORRECTIVE MEASURE AND THE DATE THE CORRECTIVE MEASURE WAS COMPLETED.

GENERAL SITE NOTES

- 1. ALL DISPLAY LIGHTING SHALL BE DIRECTED ON—SITE; REFER TO BOTH SITE LIGHTING PLAN AND THE BUILDING LIGHTING PLAN FOR FURTHER DETAILS.
- 2. ALL SIGNS SHALL CONFORM TO APPLICABLE TOWN OF BARRINGTON REGULATIONS UNDER SECTION _____ OF THE <NAME OF MUNICIPALITY> ZONING ORDINANCE; REFER TO SIGNAGE PLAN FOR FURTHER DETAILS.
- 3. SITE IMPROVEMENTS DEPICTED ON THE PLAN SHALL CONFORM TO THE MOST CURRENT EDITION OF THE AMERICAN DISABILITY ACT (ADA) STANDARDS FOR ACCESSIBLE DESIGN WITH REGARDS TO DIMENSIONS AND GRADES.
- 4. IT SHALL BE UNLAWFUL TO MODIFY, CHANGE, OR ALTER ANY STRUCTURE SHOWN ON THIS PLAN IN ANY WAY, TO CONVERT OR ALTER ANY STRUCTURE SHOWN ON THIS PLAN, OR CHANGE THE ABOVE USE INDICATED ON THIS PLAN WITHOUT RECEIVING PRIOR APPROVAL FROM THE TOWN OF BARRINGTON PLANNING BOARD.
- 5. THE APPLICANT SHALL SUBMIT A COPY OF ALL ENVIRONMENTAL PERMITS OBTAINED TO THE TOWN OF BARRINGTON PLANNING BOARD INCLUDING ANNUAL UP—DATES OF STORMWATER POLLUTION PREVENTION PLAN (S.W.P.P.P) CONTACT INFORMATION.
- 6. IT IS THE RESPONSIBILITY OF THE CONTRACTOR TO REVIEW ALL OF THE DRAWINGS AND SPECIFICATIONS ASSOCIATED WITH THIS PROJECT'S SCOPE OF WORK PRIOR TO THE COMMENCEMENT OF CONSTRUCTION. WRITTEN DIMENSIONS HAVE PRECEDENCE OVER SCALED DIMENSIONS. SHOULD THE CONTRACTOR FIND A CONFLICT WITH THE DOCUMENTS, RELATIVE TO THE SPECIFICATIONS OR APPLICABLE CODES, IT IS THE CONTRACTOR'S RESPONSIBILITY TO NOTIFY THE ENGINEER, IN WRITING, PRIOR TO THE INITIATION OF CONSTRUCTION. FAILURE BY THE CONTRACTOR TO NOTIFY THE ENGINEER SHALL CONSTITUTE ACCEPTANCE OF FULL RESPONSIBILITY BY THE CONTRACTOR TO COMPLETE THE SCOPE OF WORK DEFINED BY THE DRAWINGS AND IN FULL CONFORMANCE WITH LOCAL, STATE, AND FEDERAL CODES AND REGULATIONS.
- 7. IT S THE RESPONSIBILITY OF THE CONTRACTOR TO CONTACT DIG SAFE (888-DIG-SAFE) AT LEASE 72 HOURS PRIOR TO COMMENCING ANY CONSTRUCTION ACTIVITIES.
- 8. THE CONTRACTOR SHALL COMPLY WITH ALL APPLICABLE REGULATIONS OF THE OCCUPATIONAL SAFETY AND HEALTH ADMINISTRATION (0.S.H.A.).
- 9. THE CONTRACTOR SHALL BE RESPONSIBLE FOR OBTAINING ANY NECESSARY PERMITS PRIOR TO CONSTRUCTION. IT IS THE RESPONSIBILITY OF THE CONTRACTOR TO BE FAMILIAR WITH THE APPLICABLE PROVISIONS OF EACH PERMIT AS THEY APPLY TO THE WORK AND ABIDE BY THOSE PROVISIONS DURING CONSTRUCTION.
- 10. THE CONTRACTOR SHALL BE RESPONSIBLE FOR OBTAINING "STREET OPENING PERMIT" FROM TOWN OF BARRINGTON DEPARTMENT OF PUBLIC WORKS PRIOR TO PERFORMING ANY WORK WITHIN THE MUNICIPALITY'S RIGHT-OF-WAY(S).
- 11. THE OWNER SHALL BE RESPONSIBLE FOR OBTAINING ANY NECESSARY RIGHT-OF-WAYS AND EASEMENTS. HOWEVER, IT SHALL BE THE RESPONSIBILITY OF THE CONTRACTOR TO VERIFY THAT THE OWNER HAS SECURED ANY NECESSARY EASEMENTS. IT IS THE RESPONSIBILITY OF THE CONTRACTOR TO BE FAMILIAR WITH THE APPLICABLE PROVISIONS OF EACH EASEMENT AS THEY APPLY TO THE WORK AND ABIDE BY THOSE PROVISIONS DURING CONSTRUCTION.
- 12. CONTRACTOR SHALL INSTALL AND MAINTAIN TRAFFIC CONTROL DEVICES AS NECESSARY AND IN A MANNER CONSISTENT WITH THE MOST CURRENT EDITION OF THE MANUAL ON UNIFORM TRAFFIC CONTROL DEVICES (M.U.T.C.D.).
- 13. THE CONTRACTOR IS REQUIRED TO SUBMIT A TRAFFIC CONTROL PLAN TO THE ENGINEER AND THE TOWN OF BARRINGTON PUBLIC WORKS DEPARTMENT PRIOR TO PERFORMING ANY ACTIVITIES WITHIN THE MUNICIPALITIES RIGHTS—OF—WAY. THE TOWN OF BARRINGTON POLICE DEPARTMENT (603—664—2700), FIRE DEPARTMENT (603—664—2241), AND PUBLIC WORKS (603—664—0166) ARE TO BE NOTIFIED AT LEAST 24 HOURS IN ADVANCE OF ANY STREET CLOSING OR DETOUR.
- 14. THE CONTRACTOR SHALL FURNISH AND MAINTAIN A TELEPHONE NUMBER WHERE THE CONTRACTOR CAN BE REACHED 24 HOURS A DAY, 7 DAYS A WEEK, UNTIL THE PROJECT HAS REACHED SUBSTANTIAL COMPLETION.
- 15. ALL DISTURBED AREAS SHALL BE THE RESPONSIBILITY OF THE CONTRACTOR. ALL DISTURBED AREAS SHALL NOT BE LEFT BARE FOR MORE THAN 30 DAYS, SHALL BE STABILIZED IN A MANNER TO MITIGATE EROSION OR SEDIMENTATION FROM EXITING THE LIMIT OF WORK AND SHALL BE RESTORED IN—KIND UPON COMPLETION OF THE PROJECT. THE MAXIMUM AREA ALLOWED TO BE DISTURBED AND LEFT UNSTABILIZED IS TWO (2) ACRES AT ANY ONE TIME. SEE EROSION & SEDIMENTATION CONTROL NOTES SHEET FOR FOR FURTHER DETAIL
- 16. SUITABLE EXCAVATED MATERIALS MAY BE INCORPORATED INTO THE PROJECT. THIS PROVISION SHALL IN NO WAY RELIEVE THE CONTRACTOR OF THEIR OBLIGATIONS TO REMOVE AND DISPOSE OF ANY MATERIAL DETERMINED BY THE CONTRACTING OFFICER TO BE UNSUITABLE FOR BACKFILLING OR EXCESS SUITABLE MATERIAL.
- 17. EXISTING SIGNS IMPACTED BY THIS PROJECT SHALL BE RESET AT NO ADDITIONAL COST TO THE OWNER. PLACEMENT SHALL CONFORM TO THE REQUIREMENTS OF THE MOST CURRENT EDITION OF THE MANUAL ON UNIFORM TRAFFIC CONTROL DEVICES (M.U.T.C.D.).
- 18. ALL SITE WORK SHALL SHALL BE CONSTRUCTED IN ACCORDANCE WITH TOWN OF BARRINGTON CONSTRUCTION STANDARDS AS APPLICABLE.
- 19. ALL WORK SHALL SHALL BE CONSTRUCTED IN ACCORDANCE WITH THE TOWN OF BARRINGTON AND THE STATE OF NEW HAMPSHIRE DEPARTMENT OF TRANSPORTATION CONSTRUCTION STANDARDS AS APPLICABLE.
- 20. ALL CONCRETE AND BITUMINOUS PATCH AREAS SHALL MATCH EXISTING GRADES
- 21. ALL CURB RADII ARE TO THE OUTSIDE FACE.
- 22. ALL EXCESS SNOW SHALL BE REMOVED TO AN APPROVED OFF-SITE LOCATION.
- 23. HOURS OF OPERATION: ??-HOURS A DAY / ?-DAYS A WEEK

HORIZONTAL GRAPHIC SCALE

0 10 20 40


1" = 20'

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NOT FOR CONSTRUCTION PRELIMINARY PLANS

PROFESSIONAL SEAL



TOWN OF
BARRINGTON
333 CALEF HIGHWAY
BARRINGTON, NEW
HAMPSHIRE

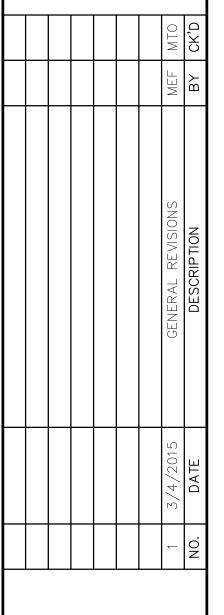BARRINGTON TOWN OFFICES RAMSDELL LANE, BARRINGTON, NEW HAMPSHIRE

SHEET TITLE

SITE LAYOUT

DRAWN BY	DATE	
MEF	FEB. 2015	
CHECKED BY	D&K PROJECT#	
JAA	XXXXXX	
PROJ. ENG.	D&K ARCHIVE #	
MTO		
SHEET NUMBER		

C1.1

SHEET 4 OF 13

1. CONTRACTOR SHALL CONSTRUCT TEMPORARY AND PERMANENT EROSION AND SEDIMENTATION CONTROL FACILITIES PRIOR TO THE COMMENCEMENT OF EARTHWORK OPERATIONS. EROSION CONTROL MEASURES SHALL INCLUDE, BUT ARE NOT LIMITED TO, ITEMS IDENTIFIED WITHIN THIS PLAN SET OR WITHIN THE NEW HAMPSHIRE DEPARTMENT OF ENVIRONMENTAL SERVICES (NHDES) BEST MANAGEMENT PRACTICES (BMP'S) FOR EROSION CONTROL. SEE EROSION CONTROL PLAN AND EROSION CONTROL NOTES & DETAIL SHEET FOR SUPPLEMENTAL INFORMATION.

2. THE CONTRACTOR SHALL MAINTAIN EROSION AND SEDIMENTATION CONTROL DEVICES THROUGHOUT THE PROJECT SITE FOR THE DURATION OF THE CONSTRUCTION. THE CONTRACTOR SHALL (DAILY OR AS REQUIRED BASIS) INSPECT AND RECORD FINDINGS OF ALL EROSION AND SEDIMENTATION CONTROL DEVICES TO ENSURE THAT ALL ITEMS ARE IN STABLE CONDITION. IN THE EVENT THAT SAID ITEMS ARE DETERMINED TO BE IN UNSATISFACTORY CONDITION, THE CONTRACTOR SHALL RECORD THE UNSATISFACTORY ISSUE, THE DATE OF THE UNSATISFACTORY FINDING, THE APPROPRIATE CORRECTIVE MEASURE AND THE DATE THE CORRECTIVE MEASURE WAS COMPLETED.

3. ALL DISTURBED AREAS SHALL BE THE RESPONSIBILITY OF THE CONTRACTOR. ALL DISTURBED AREAS SHALL NOT BE LEFT BARE FOR MORE THAN 30 DAYS, SHALL BE STABILIZED IN A MANNER TO MITIGATE EROSION OR SEDIMENTATION FROM EXITING THE LIMIT OF WORK AND SHALL BE RESTORED IN—KIND UPON COMPLETION OF THE PROJECT. SEE GENERAL NOTES OF DEMOLITION SHEET FOR LIMIT OF WORK BOUNDARY DEFINITION. THE MAXIMUM AREA ALLOWED TO BE DISTURBED AND LEFT UNSTABILIZED IS TWO ACRES PER DRAINAGE AREA.

4. ALL SLOPES GREATER THAN 3:1 SHALL BE PROTECTED FROM EROSION WITH APPROPRIATE SLOPE STABILIZATION CONTROL MEASURES PRIOR TO LOAMING, SEEDING AND MULCHING WITHIN 72 HOURS OF COMPLETION. CONTRACTOR SHALL MAINTAIN EROSION CONTROL PROTECTION UNTIL VEGETATION GROWTH HAS BEEN ESTABLISHED. ALL SLOPE STABILIZATION CONTROL MEASURES SHALL BE INSTALLED IN ACCORDANCE WITH MANUFACTURER'S RECOMMENDATION.

5. ALL SWALES AND DITCHES WITH SLOPES EXCEEDING 5% SHALL BE PROTECTED FROM EROSION WITH APPROPRIATE STABILIZATION CONTROL MATTING. ALL MATTING SHALL BE INSTALLED IN ACCORDANCE WITH MANUFACTURER'S RECOMMENDATION. ALL SWALES AND DITCHES SHALL BE PROPERLY STABILIZED PRIOR TO DIRECTING FLOW TO THEM.

6. THE CONTRACTOR SHALL NOT PLACE PERMANENT PLANTING AND SEEDING PRIOR TO MAY 1st AND AFTER SEPTEMBER 1st.

7. IN GENERAL, FINISH GRADES AROUND BUILDINGS SHALL BE 6 INCHES LOWER THAN FINISH FLOOR ELEVATIONS, UNLESS OTHERWISE NOTED. SEE GRADING PLANS (NORTHERN AND SOUTHERN LIMITS) FOR LOCATION AND FINISH GRADE ELEVATIONS ALONG BUILDING LIMITS.

8. IN GENERAL, FINISH GRADES SHALL BE SLOPED 5% AWAY FROM BUILDINGS FOR A DISTANCE OF 10 FEET FROM THE EXTERIOR WALL OF SAID BUILDING, UNLESS OTHERWISE NOTED.

9. FINISH GRADES OF SIDEWALKS AT BUILDING ENTRANCES SHALL BE 1/4 OF AN INCH LOWER THAN FINISH FLOOR ELEVATION.

10. ALL SIDEWALKS SHALL BE IN ACCORDANCE WITH THE AMERICAN DISABILITY ACT (ADA) REQUIREMENTS, UNLESS OTHERWISE NOTED.

11. SEE SOIL BORING & TEST PIT PLAN FOR FOUNDATION PERIMETER DRAIN LAYOUT INFORMATION.

DEFINITION:

12. STABLE SHALL BE DEFINED AS AREAS THAT DO NOT ERODE (I.E. WEARING AWAY OF LAND BY RUNNING WATER, WAVES, WIND, ICE, ABRASION AND/OR TRANSPORTATION). AN AREA SHALL BE CONSIDERED STABLE IS ONT OF THE FOLLOWING HAS OCCURRED:

12.1. BASE COURSE GRAVELS HAVE BEEN PLACED AND COMPACTED IN AREAS TO BE PAVED.

12.2. VEGETATION GROWTH IS IN ACCORDANCE WITH SPECIFICATION 329200, SECTION 3.05.C.

12.3. A MINIMUM OF 3" OF NON-EROSIVE MATERIAL (STONE OR RIPRAP) HAS BEEN INSTALLED.

12.4. EROSION CONTROL BLANKETS HAVE BEEN PROPERLY INSTALLED.

HORIZONTAL GRAPHIC SCALE

0 10 20 40

1" = 20'

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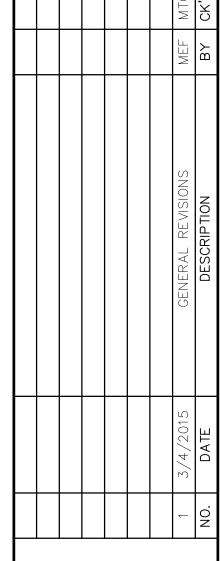
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PROFESSIONAL SEAL

NOT FOR CONSTRUCTION PRELIMINARY PLANS



TOWN OF BARRINGTON 333 CALEF HIGHWAY BARRINGTON, NEW HAMPSHIRE

BARRINGTON TOWN OFFICES RAMSDELL LANE, BARRINGTON, NEW HAMPSHIRE


SHEET TITLE

GRADING AND DRAINAGE PLAN

DRAWN BY	DATE		
MEF	FEB. 2015		
CHECKED BY	D&K PROJECT #		
JAA	XXXXXX		
PROJ. ENG.	D&K ARCHIVE #		
MTO			
SHEET NUMBER			

C1.2

SHEET 5 OF 13

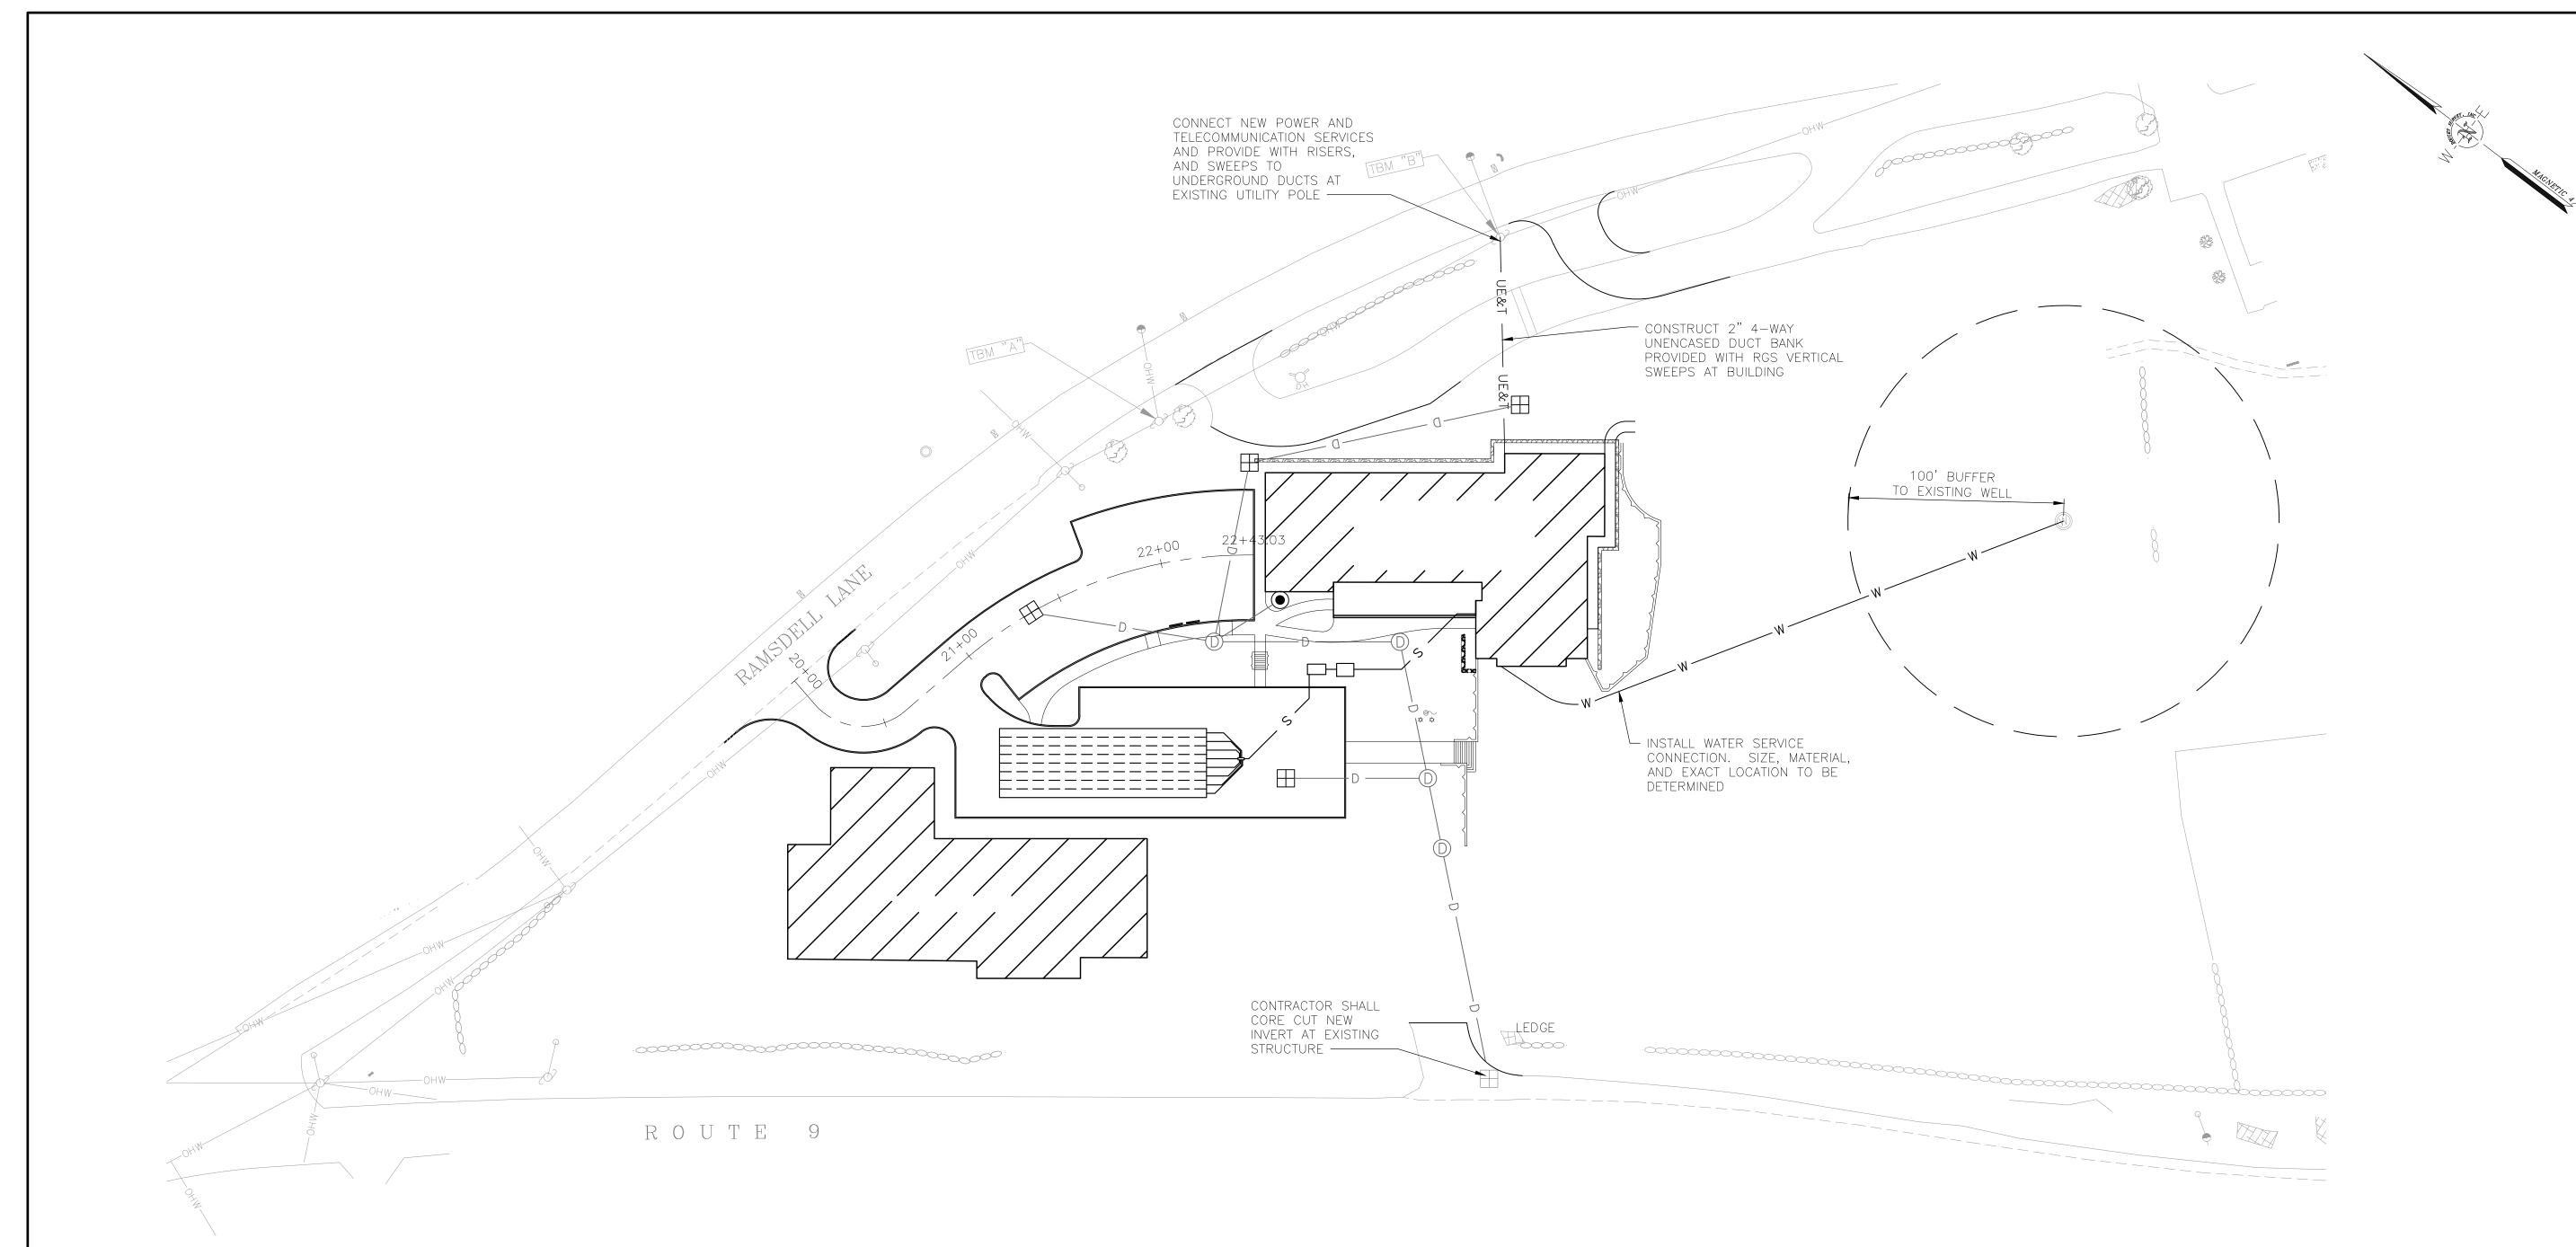

UTILITY NOTES:

- 1. BELOW GRADE UTILITY INFORMATION IS BASED ON RECORD DRAWINGS. LOCATION OF PUBLIC UTILITIES SHOWN IS ONLY APPROXIMATE AND MAY NOT BE COMPLETE. PRIVATE UNDERGROUND UTILITIES SUCH AS, BUT NOT LIMITED TO, SEWER LINES, WATER LINES AND BURIED ELECTRICAL SERVICE LINES ARE NOT SHOWN. IT SHALL BE THE CONTRACTOR'S RESPONSIBILITY TO CONFIRM ALL UTILITIES WITH LOCAL UTILITY COMPANIES ALONG WITH NOTIFYING "DIG-SAFE" (1-800-344-7233) AT LEASE 72 HOURS PRIOR TO THE COMMENCEMENT OF ANY CONSTRUCTION OR EXCAVATION. ALL UTILITY SERVICE CONNECTION POINTS SHALL BE CONFIRMED INDEPENDENTLY BY THE CONTRACTOR IN THE FIELD PRIOR TO THE INITIATION OF CONSTRUCTION.
- 2. CONTRACTOR IS RESPONSIBLE TO COORDINATE ALL UTILITY RELOCATION AND INSTALLATION WITH THE APPROPRIATE UTILITY. THE APPROPRIATE UTILITY OR ITS AUTHORIZED REPRESENTATIVE WILL PERFORM ADJUSTMENTS OF ALL UTILITY STRUCTURES. UTILITY CONTACTS ARE AS FOLLOWS:

WATER: PRIVATE
SEPTIC: PRIVATE

ELECTRIC: PSNH PHONE: 800-362-7764

TELEPHONE: FAIRPOINT PHONE: 888-984-1515

STORMWATER: PRIVATE

3. ALL EXISTING UTILITIES ENCOUNTERED DURING CONSTRUCTION ARE TO REMAIN IN SERVICE UNLESS OTHERWISE NOTED ON THE DEMOLITION PLAN. AT NO ADDITIONAL COST TO THE OWNER, THE CONTRACTOR SHALL REPAIR OR COORDINATE WITH THE RESPECTIVE UTILITY FOR DAMAGE TO UTILITIES.

- 4. CONTRACTOR SHALL BE RESPONSIBLE FOR ALL UTILITY FEES.
- 5. SEE SHEET C1.3 FOR ISOLATED WATER, ELECTRIC, TELEPHONE AND CABLE LAYOUT. SEE SHEETS C1.2 FOR GRADING AND DRAINAGE LAYOUT. SEE SHEET C2.1 FOR SEPTIC TANK AND LEACHING CHAMBER LAYOUT.
- 6. CONSTRUCTION AND TESTING OF SANITARY UTILITES SHALL BE IN ACCORDANCE WITH TECHNICAL SPECIFICATIONS ASSOCIATED WITH THIS PROJECT.
- 7. CONSTRUCTION, TESTING AND DISINFECTION OF WATER UTILITES SHALL BE IN ACCORDANCE WITH TECHNICAL SPECIFICATIONS ASSOCIATED WITH THIS PROJECT.
- 8. WATER SERVICES TO PROVIDED BY AN EXISTING ON-SITE DRILLED WELL AND SIZED
- 9. CABLE/TV UTILITY SERVICE SHALL BE LOCATED WITHIN THE SAME UTILITY TRENCH AS SUBSURFACE TELEPHONE (UT).
- 10. ELECTRICAL, TELEPHONE AND CABLE SHALL BE INSTALLED IN ACCORDANCE WITH RESPECTIVE UTILITY COMPANY'S INSTALLATION REQUIREMENTS. IT SHALL BE THE RESPONSIBILITY OF THE CONTRACTOR TO COORDINATE WITH EACH RESPECTIVE UTILITY COMPANY. UTILITY CONDUIT SIZES SHALL BE PER RESPECTIVE UTILITY COMPANY'S STANDARDS OR AS NOTED ON THE PLANS; WHICHEVER IS LARGER. AT A MINIMUM UTILITY SERVICES SHALL BE INSTALLED WITHIN SCHEDULE 80 PVC AND 40 PVC CONDUITS UNDER ROADWAYS AND NON-ROADWAYS AREAS (RESPECTIVELY) UNLESS OTHERWISE NOTED AND SHALL CONSIST OF 3' OF COVER.

<u>existing</u>	LEGEND	<u>PROPOSED</u>		
	MAJOR CONTOUR -			
	- MINOR CONTOUR -			
	SILT FENCE -	SF		
\boxplus	CATCH BASIN	⊞		
	— DRAIN PIPE —	D		
	DRAIN MANHOLE	0		
S	SEWER MANHOLE			
ė,	HANDICAP PARKING SPACE	ě.		
	VERTICAL GRANITE CURB (VGC)			
	INTEGRATED CONCRETE CURB (ICC)			
2	UTILITY POLE			
	OVERHEAD WIRES			
	UNDERGROUND ELECTRIC AND TELECOMMUNICATIONS	——— UE&T ———		
	RETAINING WALL -		(POINTS TOWARD RETAINING GROUND)	
DH DH	DRY HYDRANT			
-	SIGN	-v-		
(1)	WELL	(W)		
	BUILDING			
		_ (2)		H

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				MEF	ВУ	
				GENERAL REVISIONS	DESCRIPTION	
				3/4/2015	DATE	
				_	NO.	

TOWN OF BARRINGTON 333 CALEF HIGHWAY BARRINGTON, NEW HAMPSHIRE

BARRINGTON TOWN OFFICES RAMSDELL LANE, BARRINGTON, NEW HAMPSHIRE

SHEET TITLE

UTILITY PLAN

DRAWN BY	DATE		
MEF	FEB. 2015		
CHECKED BY	D&K PROJECT #		
JAA	XXXXXX		
PROJ. ENG.	D&K ARCHIVE #		
MTO			
SHEET NUMBER			


C1.3


SHEET 6 OF 13


HORIZONTAL GRAPHIC

0 20 40

1" = 40'

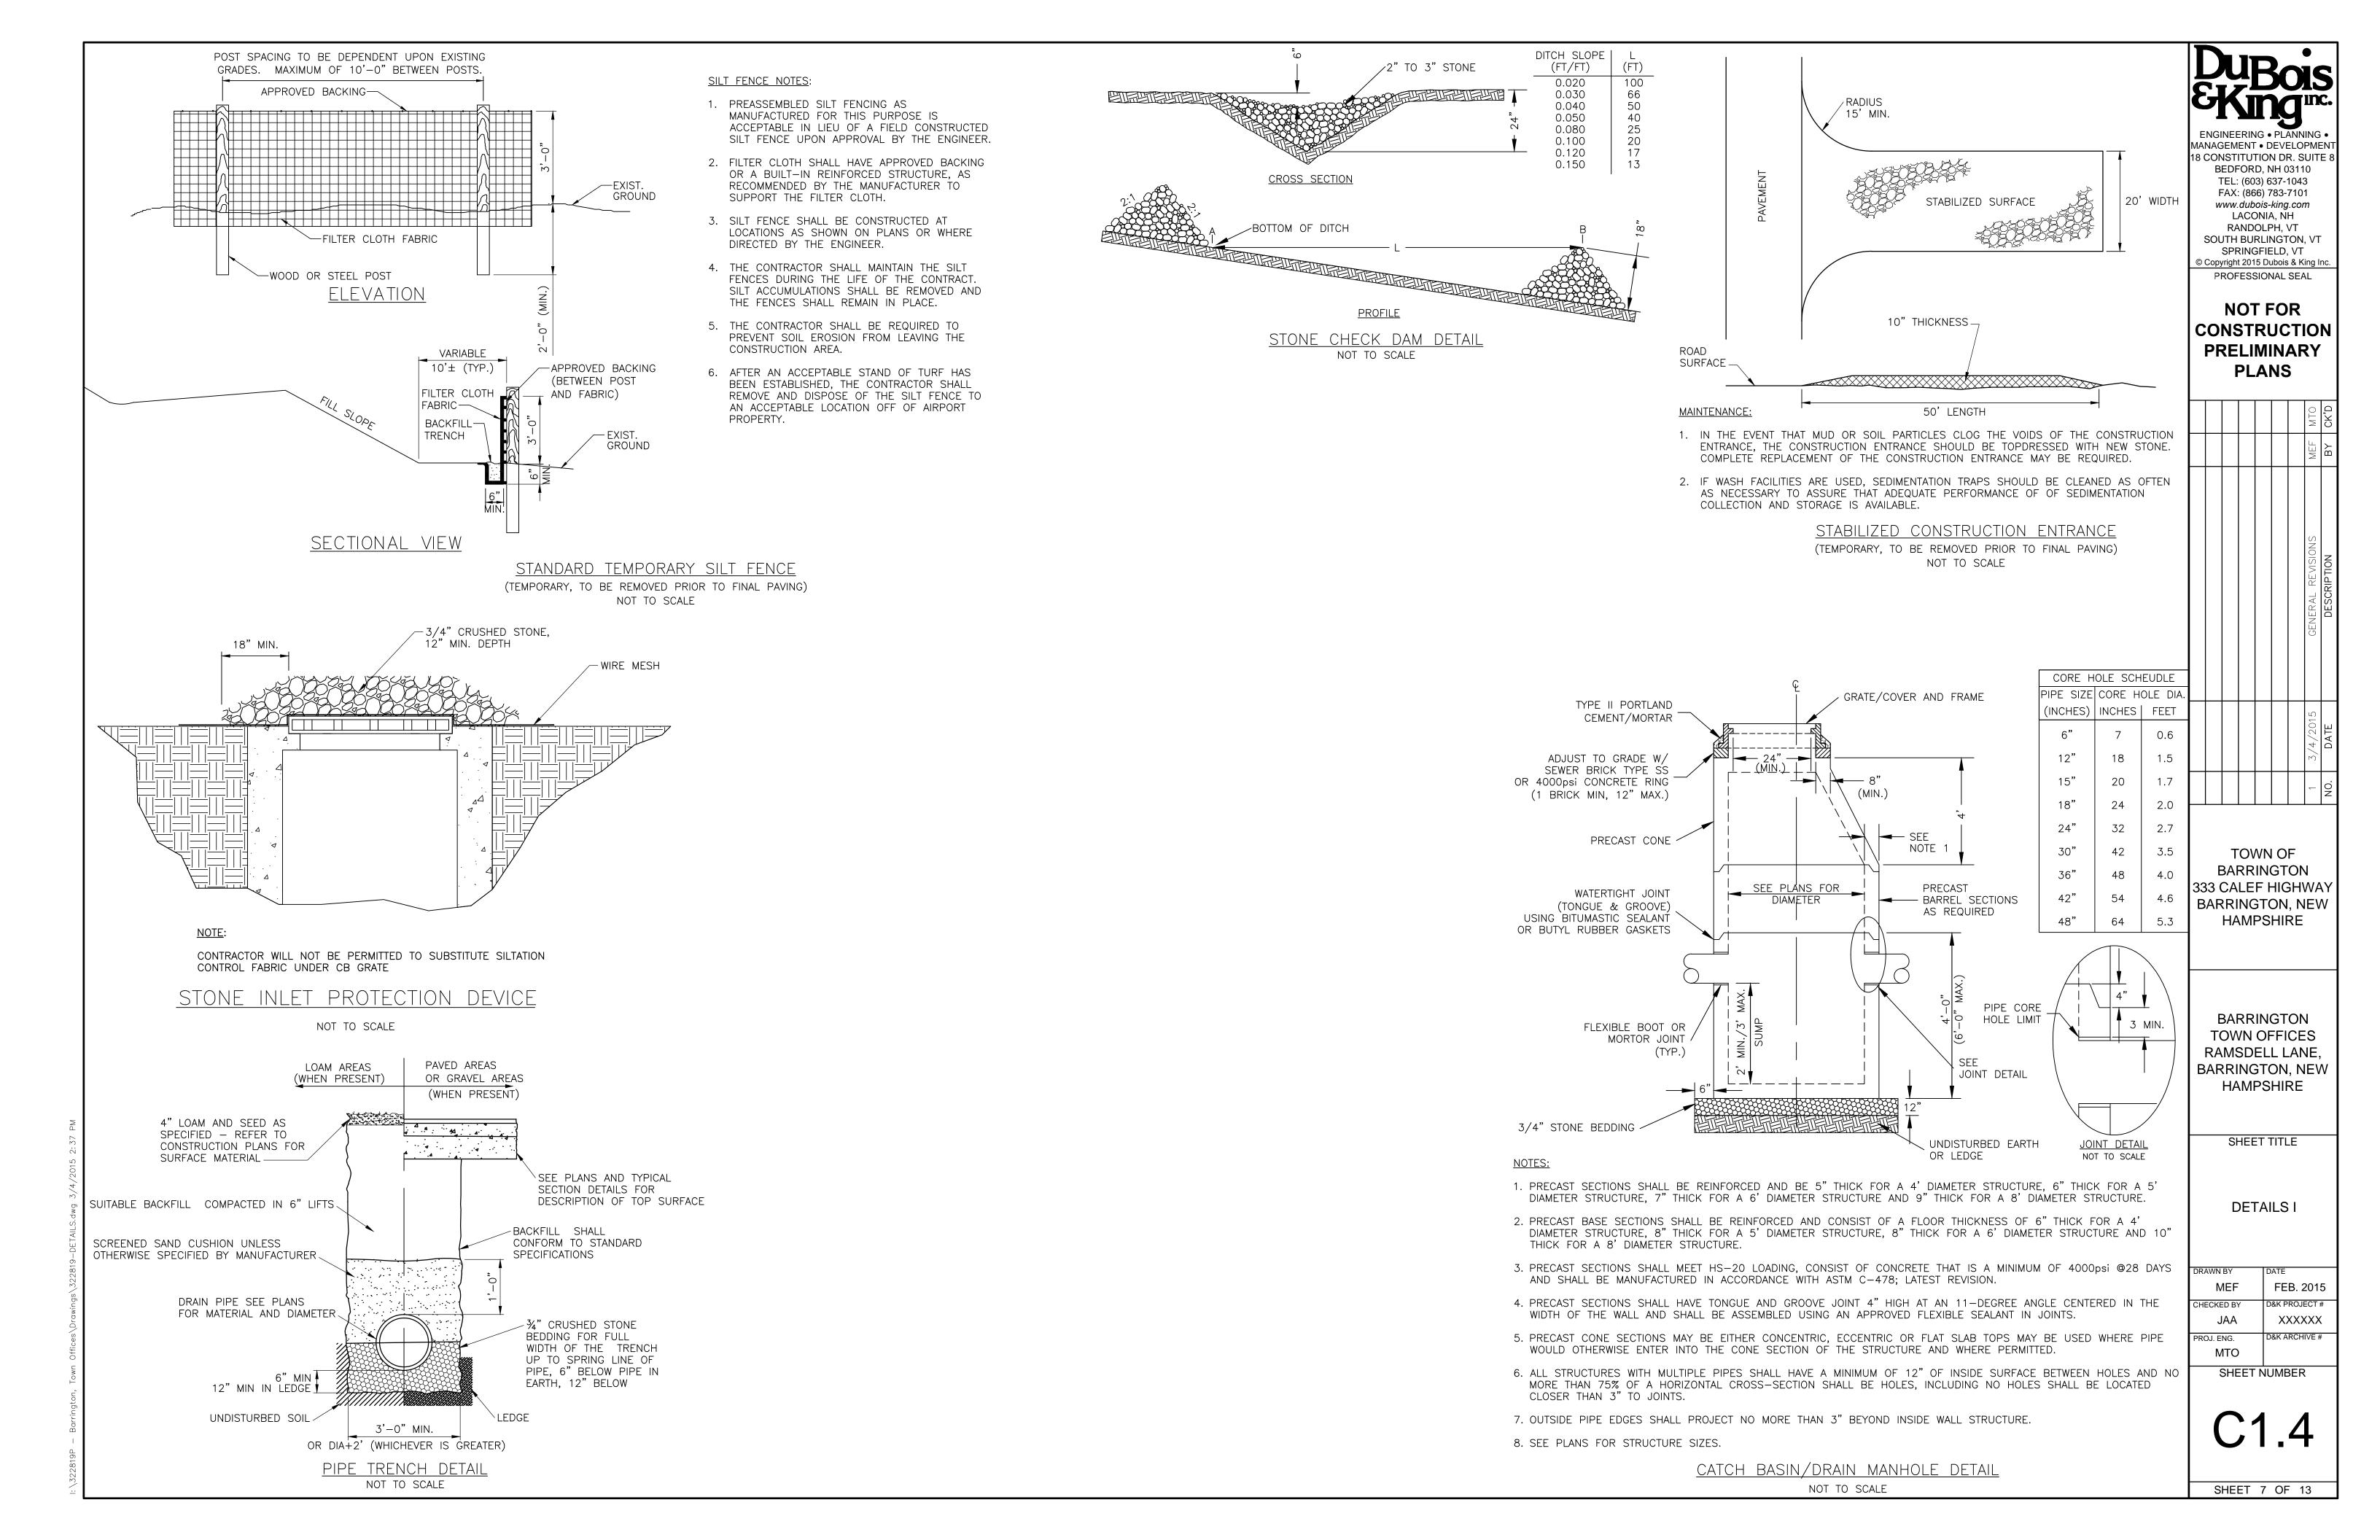

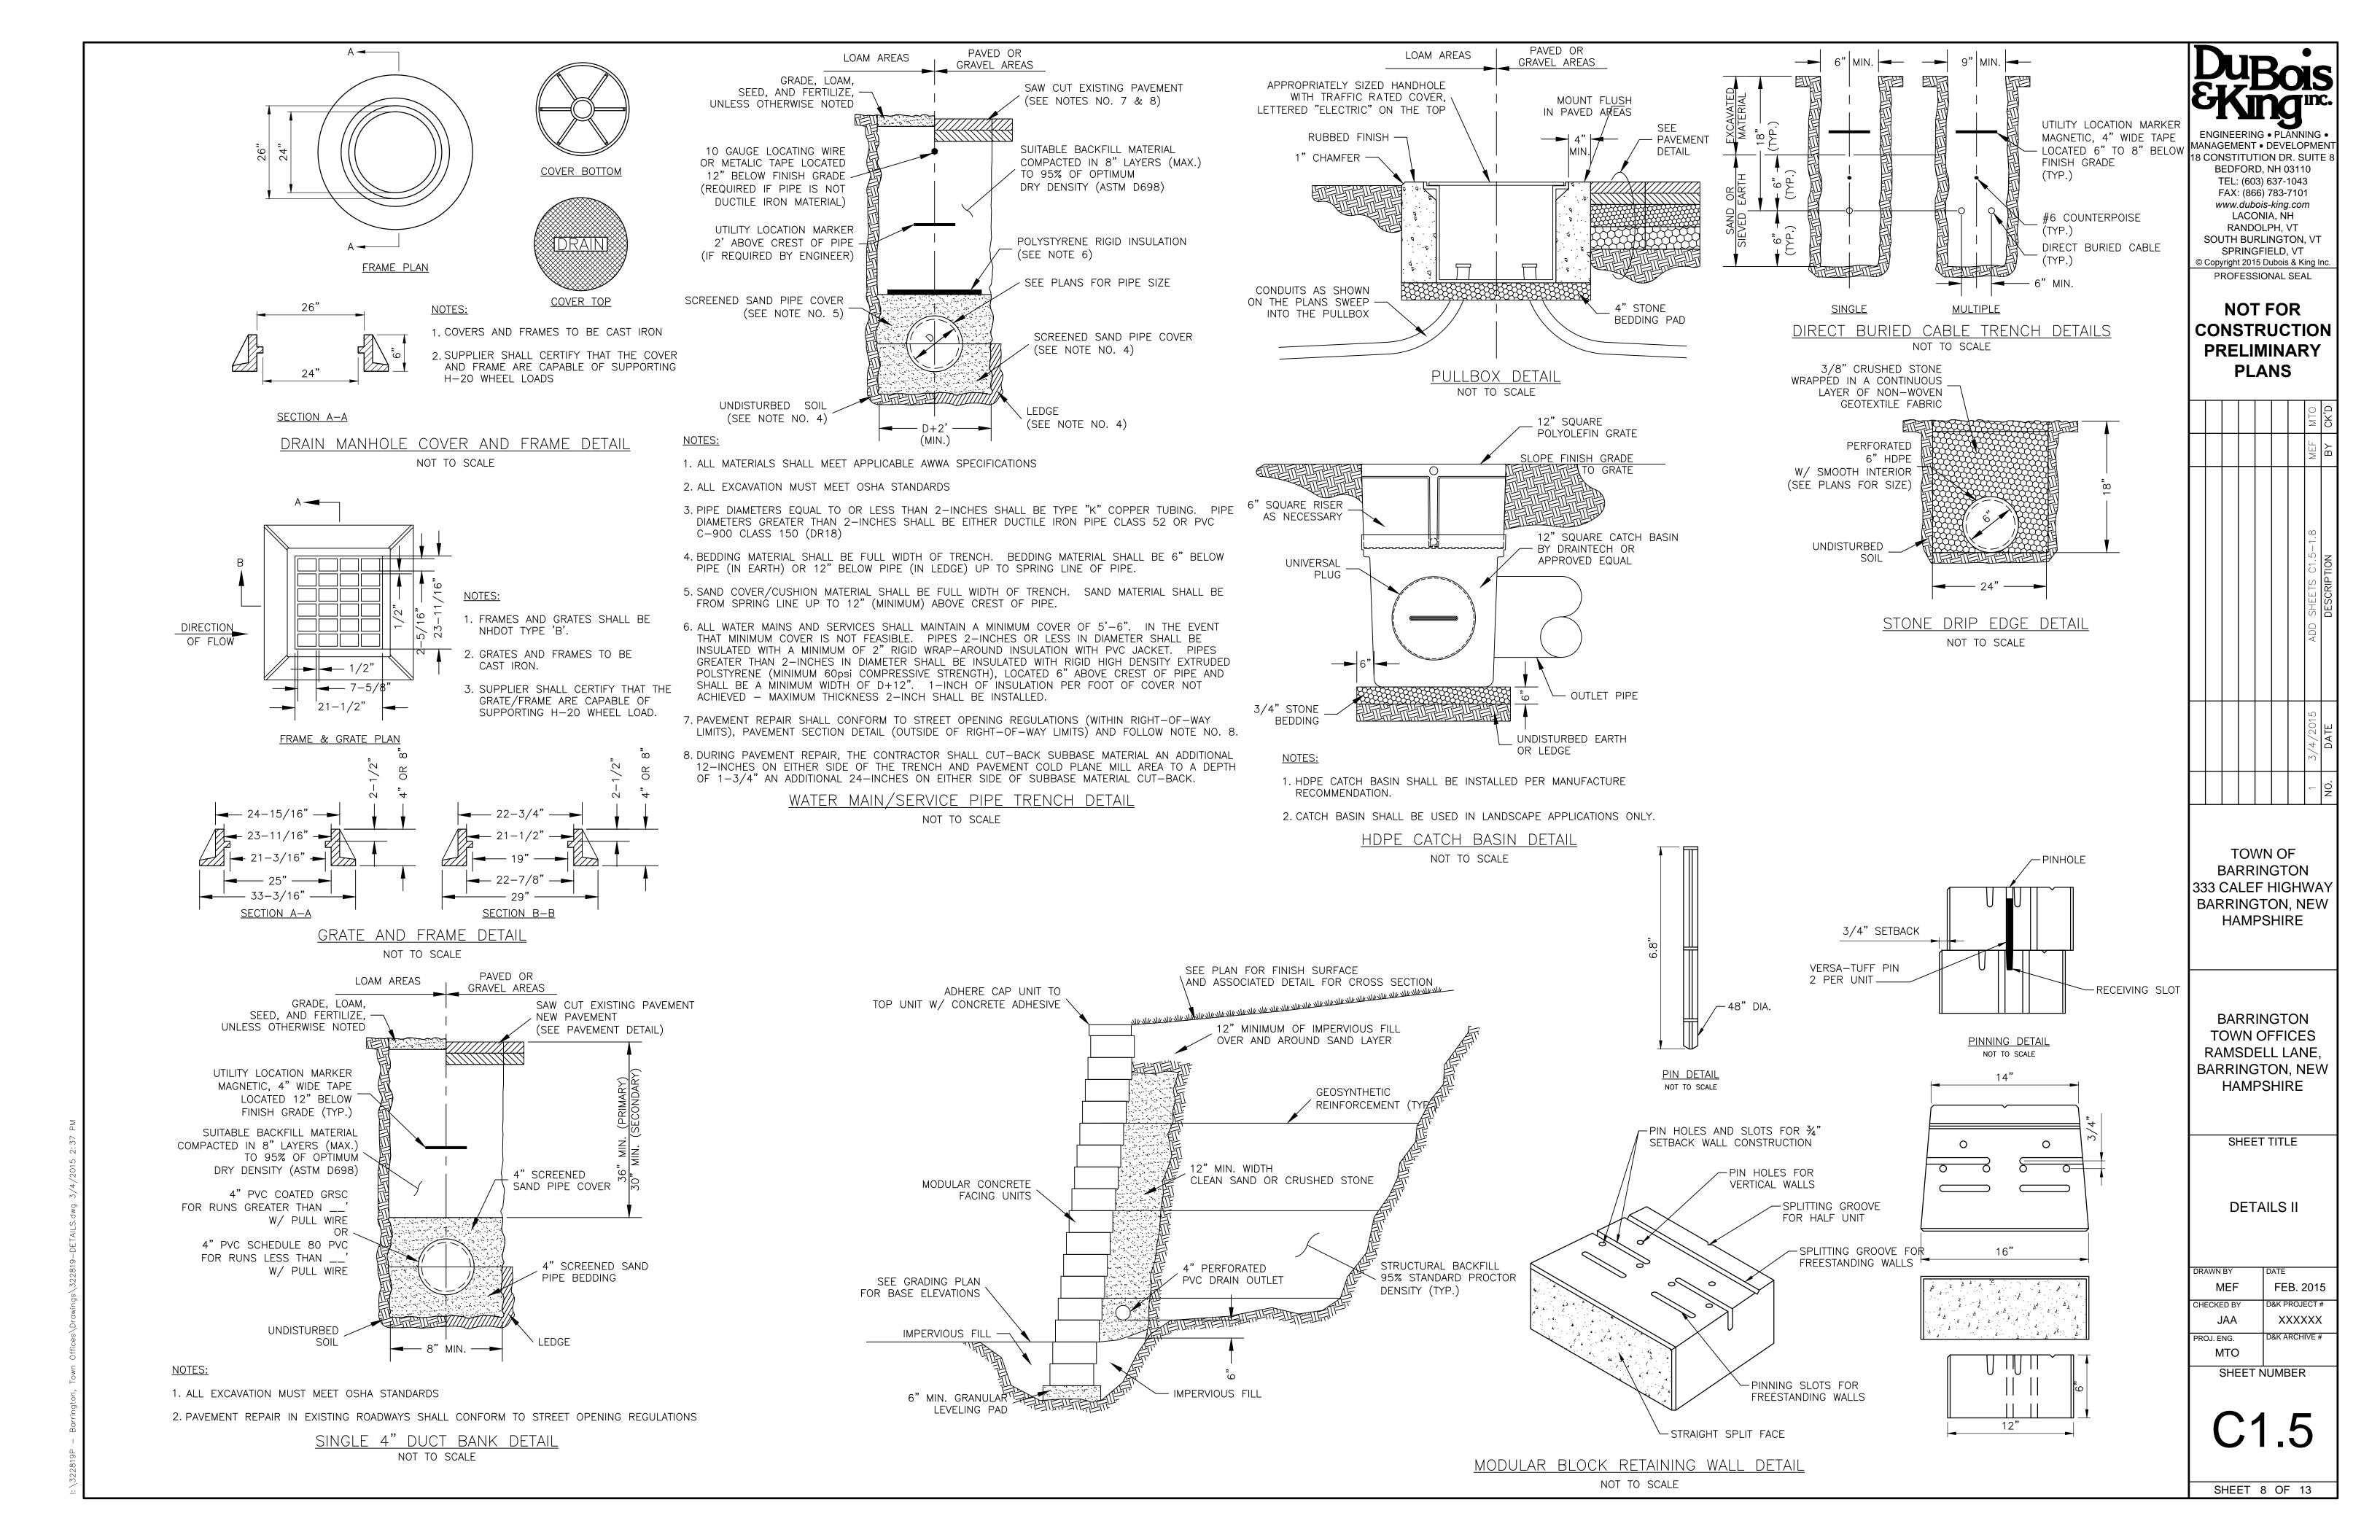

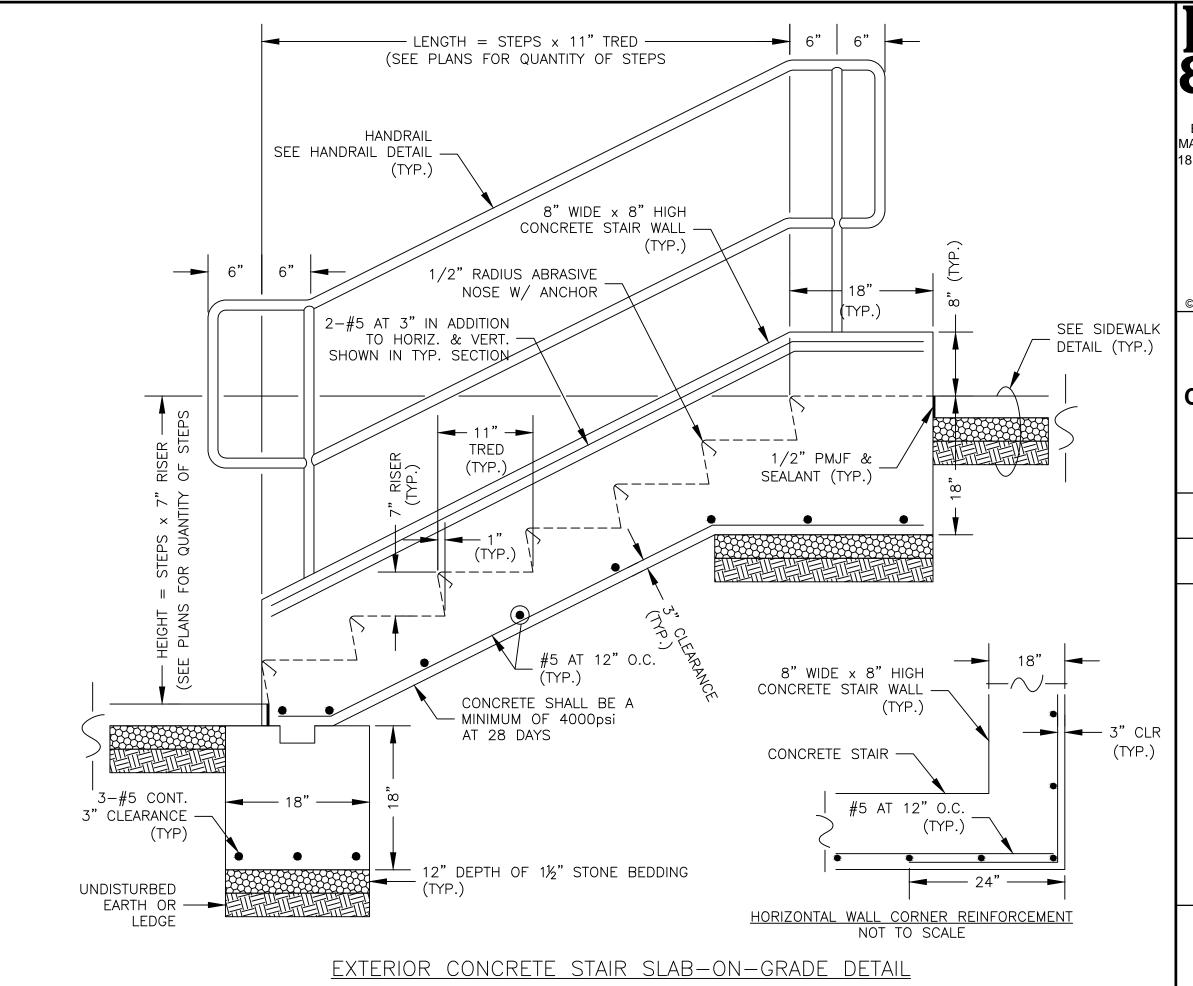

NOT TO SCALE

WIDTH VARIES TO FOG LINE EXISTING ROADWAY PAVEMENT EDGE — (SEE SITE PLAN) 2% MAX. 2% MAX. - 2" BITUMINOUS SIDEWALK 1" WEARING COURSE 6" CRUSHED 1" WEARING COURSE GRAVEL SUBBASE

NOTES:

(NHDOT 304.3)

1. MAXIMUM ALLOWABLE SIDEWALK SLOPE IN ALL DIRECTIONS SHALL BE IN ACCORDANCE WITH AMERICAN DISABILITY ACT (ADA) STANDARDS FOR ACCESSIBLE DESIGN; CROSS-SLOPE SHALL BE NO LESS THAN 1% AND NO GREATER THAN 2%.

EXISTING GROUND

MAXIMUM 3:1 SLOPE; UNLESS

OTHERWISE NOTED ON GRADING PLAN

2. ALL MATERIALS AND WORKMANSHIP SHALL COMPLY WITH NHDOT STANDARD SPECIFICATIONS.

COMPACTED SUBGRADE


- 3. REMOVE ALL UNSUITABLE MATERIAL TO THE SATISFACTION OF THE ENGINEER.
- 4. IN THE EVENT BEDROCK IS ENCOUNTERED, EXCAVATE BEDROCK TO A MINIMUM OF 6" BELOW THE SUB-BASE.
- 5. SUBGRADE MATERIAL SHALL BE SHAPED AND COMPACTED TO AN EVEN SURFACE. ALL SOFT AND YIELDING MATERIAL SHALL BE REMOVED AND REPLACED WITH BANKRUN GRAVEL MATERIAL.
- 6. IN NON-CURB AREAS PAVEMENT SUB-BASE MATERIAL SHALL EXTEND 3' BEYOND EDGE-OF-PAVEMENT.

TYPICAL AT GRADE BITUMINOUS SIDEWALK DETAIL NOT TO SCALE

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TOWN OF BARRINGTON

333 CALEF HIGHWAY

BARRINGTON, NEW
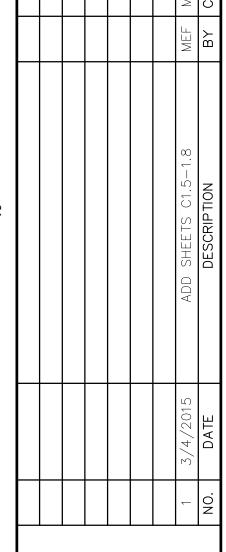
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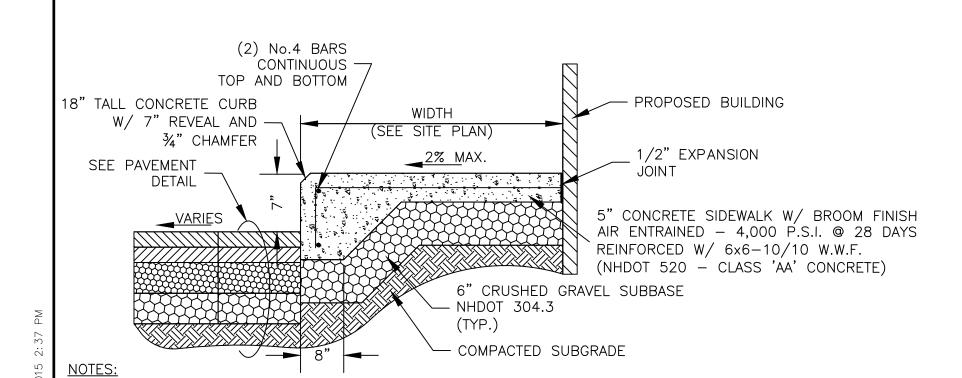
SHEET TITLE

DETAILS III

FEB. 2015 CHECKED BY O&K PROJECT# XXXXXX D&K ARCHIVE # PROJ. ENG. SHEET NUMBER

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SHEET 9 OF 13



- SEE SITE PLAN FOR LIMITS OF CURBING
- MAXIMUM ALLOWABLE SIDEWALK SLOPE IN ALL DIRECTIONS SHALL BE IN ACCORDANCE WITH AMERICAN DISABILITY ACT (ADA) STANDARDS FOR ACCESSIBLE DESIGN; CROSS-SLOPE SHALL BE NO LESS THAN 1% AND NO GREATER THAN 2%
- ALL MATERIALS AND WORKMANSHIP SHALL COMPLY WITH NHDOT STANDARD SPECIFICATIONS
- REMOVE ALL UNSUITABLE MATERIAL TO THE SATISFACTION OF THE ENGINEER
- IN THE EVENT BEDROCK IS ENCOUNTERED, EXCAVATE BEDROCK TO A MINIMUM OF 6" BELOW THE SUB-BASE MATERIAL AND REPLACE WITH BANKRUN GRAVEL
- SUBGRADE MATERIAL SHALL BE SHAPED AND COMPACTED TO AN EVEN SURFACE. ALL SOFT AND YIELDING MATERIAL SHALL BE REMOVED AND REPLACED WITH ACCEPTABLE MATERIAL
- 7. 1/4" RADIUS x 1/2" WIDE x 1/2" DEPTH TOOLED CONTROL JOINTS SHALL BE LOCATED 5' O.C.
- 8. 1/2" EXPANSION JOINTS SHALL CONFORM TO AASHTO M153, TYPE III OR AASHTO M213 AND BE LOCATED
- PROTECTIVE COATING SHALL BE SILANE/SILOXANE AND APPLIED IN ACCORDANCE WITH NHDOT 534.2.2 AND 534.3; RESPECTIVELY

VERTICAL CONCRETE CURB/SIDEWALK/BUILDING DETAIL NOT TO SCALE

2' TO FOG LINE - 16-18"x5" VERTICAL GRANITE CURB FLUSH W/ WALKWAY (SEE SITE PLAN) SAWCUT 1' TYP. 2% MAX. - EXISTING GROUND MAX. 3:1 SLOPE **VARIES** 2" BITUMINOUS SIDEWALK 1" WEARING COURSE 1" WEARING COURSE – 6" CRUSHED GRAVEL SUBBASE SUBGRADE NHDOT 304.3 (TYP.)

29'-35'

36'-42'

43'-49'


50'-56'


57'-60'

OVER 60'

- 1. SEE SITE PLAN FOR LIMITS OF CURBING
- 2. MAXIMUM ALLOWABLE SIDEWALK SLOPE IN ALL DIRECTIONS SHALL BE IN ACCORDANCE WITH AMERICAN DISABILITY ACT (ADA) STANDARDS FOR ACCESSIBLE DESIGN; CROSS-SLOPE SHALL BE NO LESS THAN 1% AND NO GREATER THAN 2%.
- 3. ALL MATERIALS AND WORKMANSHIP SHALL COMPLY WITH NHDOT STANDARD SPECIFICATIONS
- 4. ADJOINING STONES SHALL HAVE THE SAME (OR APPROX.) LENGTH
- 5. MINIMUM LENGTH OF CURB STONES = 3
- 6. MAXIMUM LENGTH OF CURB STONES = 10'
- 7. MAXIMUM LENGTH OF STRAIGHT CURB STONES LAID ON CURVES SEE CHART
- 8. ALL CURB SHALL BEGIN FLUSH WITH GROUND (O" REVEAL) AND END FLUSH WITH GROUND (O" REVEAL) TO PREVENT AN OBSTACLE FOR PLOWING.
- 9 REMOVE ALL UNSUITABLE MATERIAL TO THE SATISFACTION OF THE ENGINEER
- 10. IN THE EVENT BEDROCK IS ENCOUNTERED, EXCAVATE BEDROCK TO A MINIMUM OF 6" BELOW THE SUB-BASE MATERIAL AND REPLACE WITH BANKRUN GRAVEL
- 11. SUBGRADE MATERIAL SHALL BE SHAPED AND COMPACTED TO AN EVEN SURFACE. ALL SOFT AND YIELDING MATERIAL SHALL BE REMOVED AND REPLACED WITH ACCEPTABLE MATERIAL

TYPICAL RAISED BITUMINOUS SIDEWALK W/ VERTICAL GRANITE CURB DETAIL NOT TO SCALE

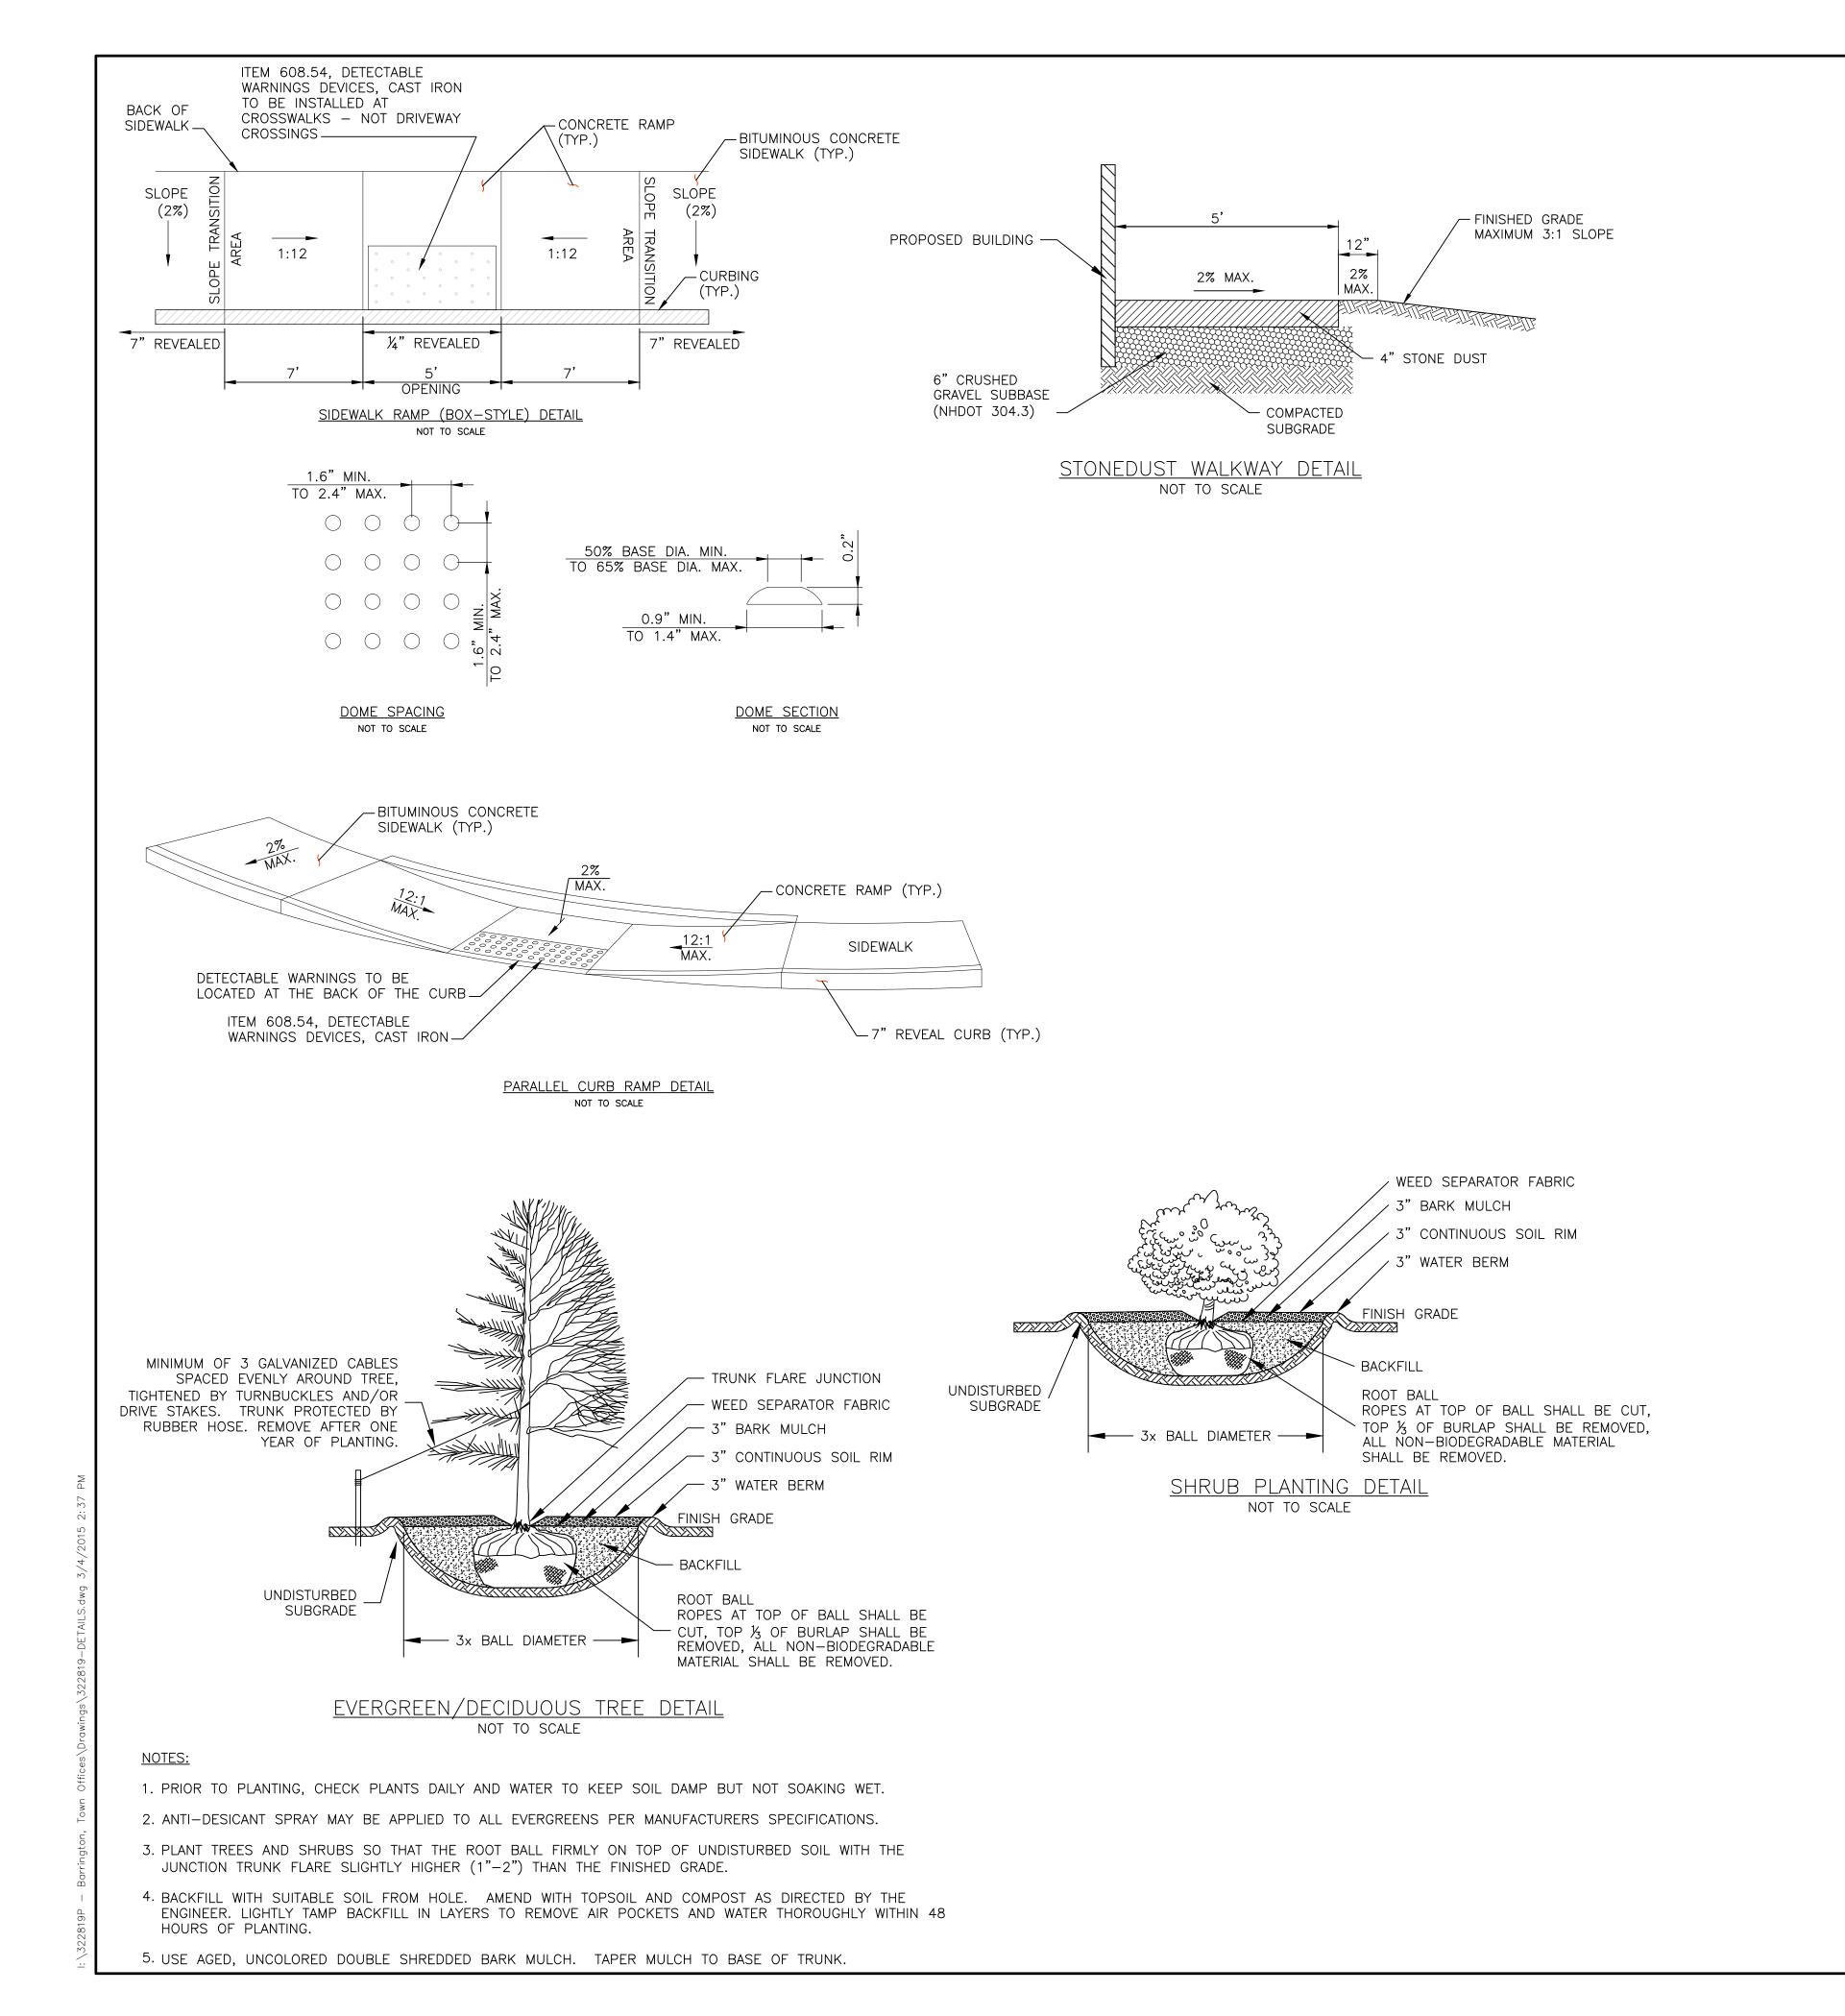

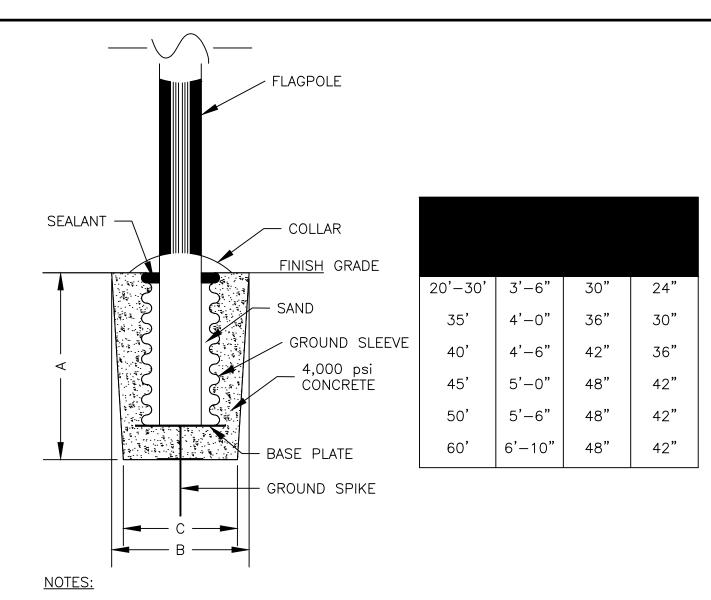

- 1. ALL EXCAVATION MUST MEET OSHA STANDARDS.
- 2. INSTALLATION SHALL BE GROUND MOUNTED; NOT BASE-PLATE MOUNTED.
- 3. INSTALLATION OF FLAGPOLE AND ASSOCIATED FOUNDATION SHALL BE PER MANUFACTURER'S RECOMMENDATION. ABOVE FOUNDATION DIMENSIONS ARE MINIMUM.

FLAGPOLE FOUNDATION DETAIL

NOT TO SCALE

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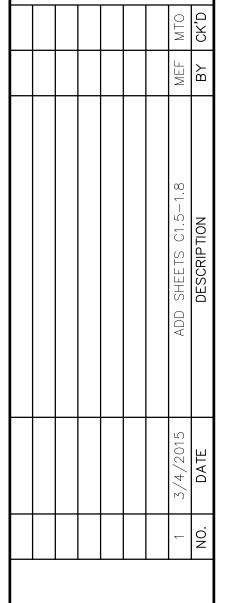
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SHEET TITLE


DETAILS IV


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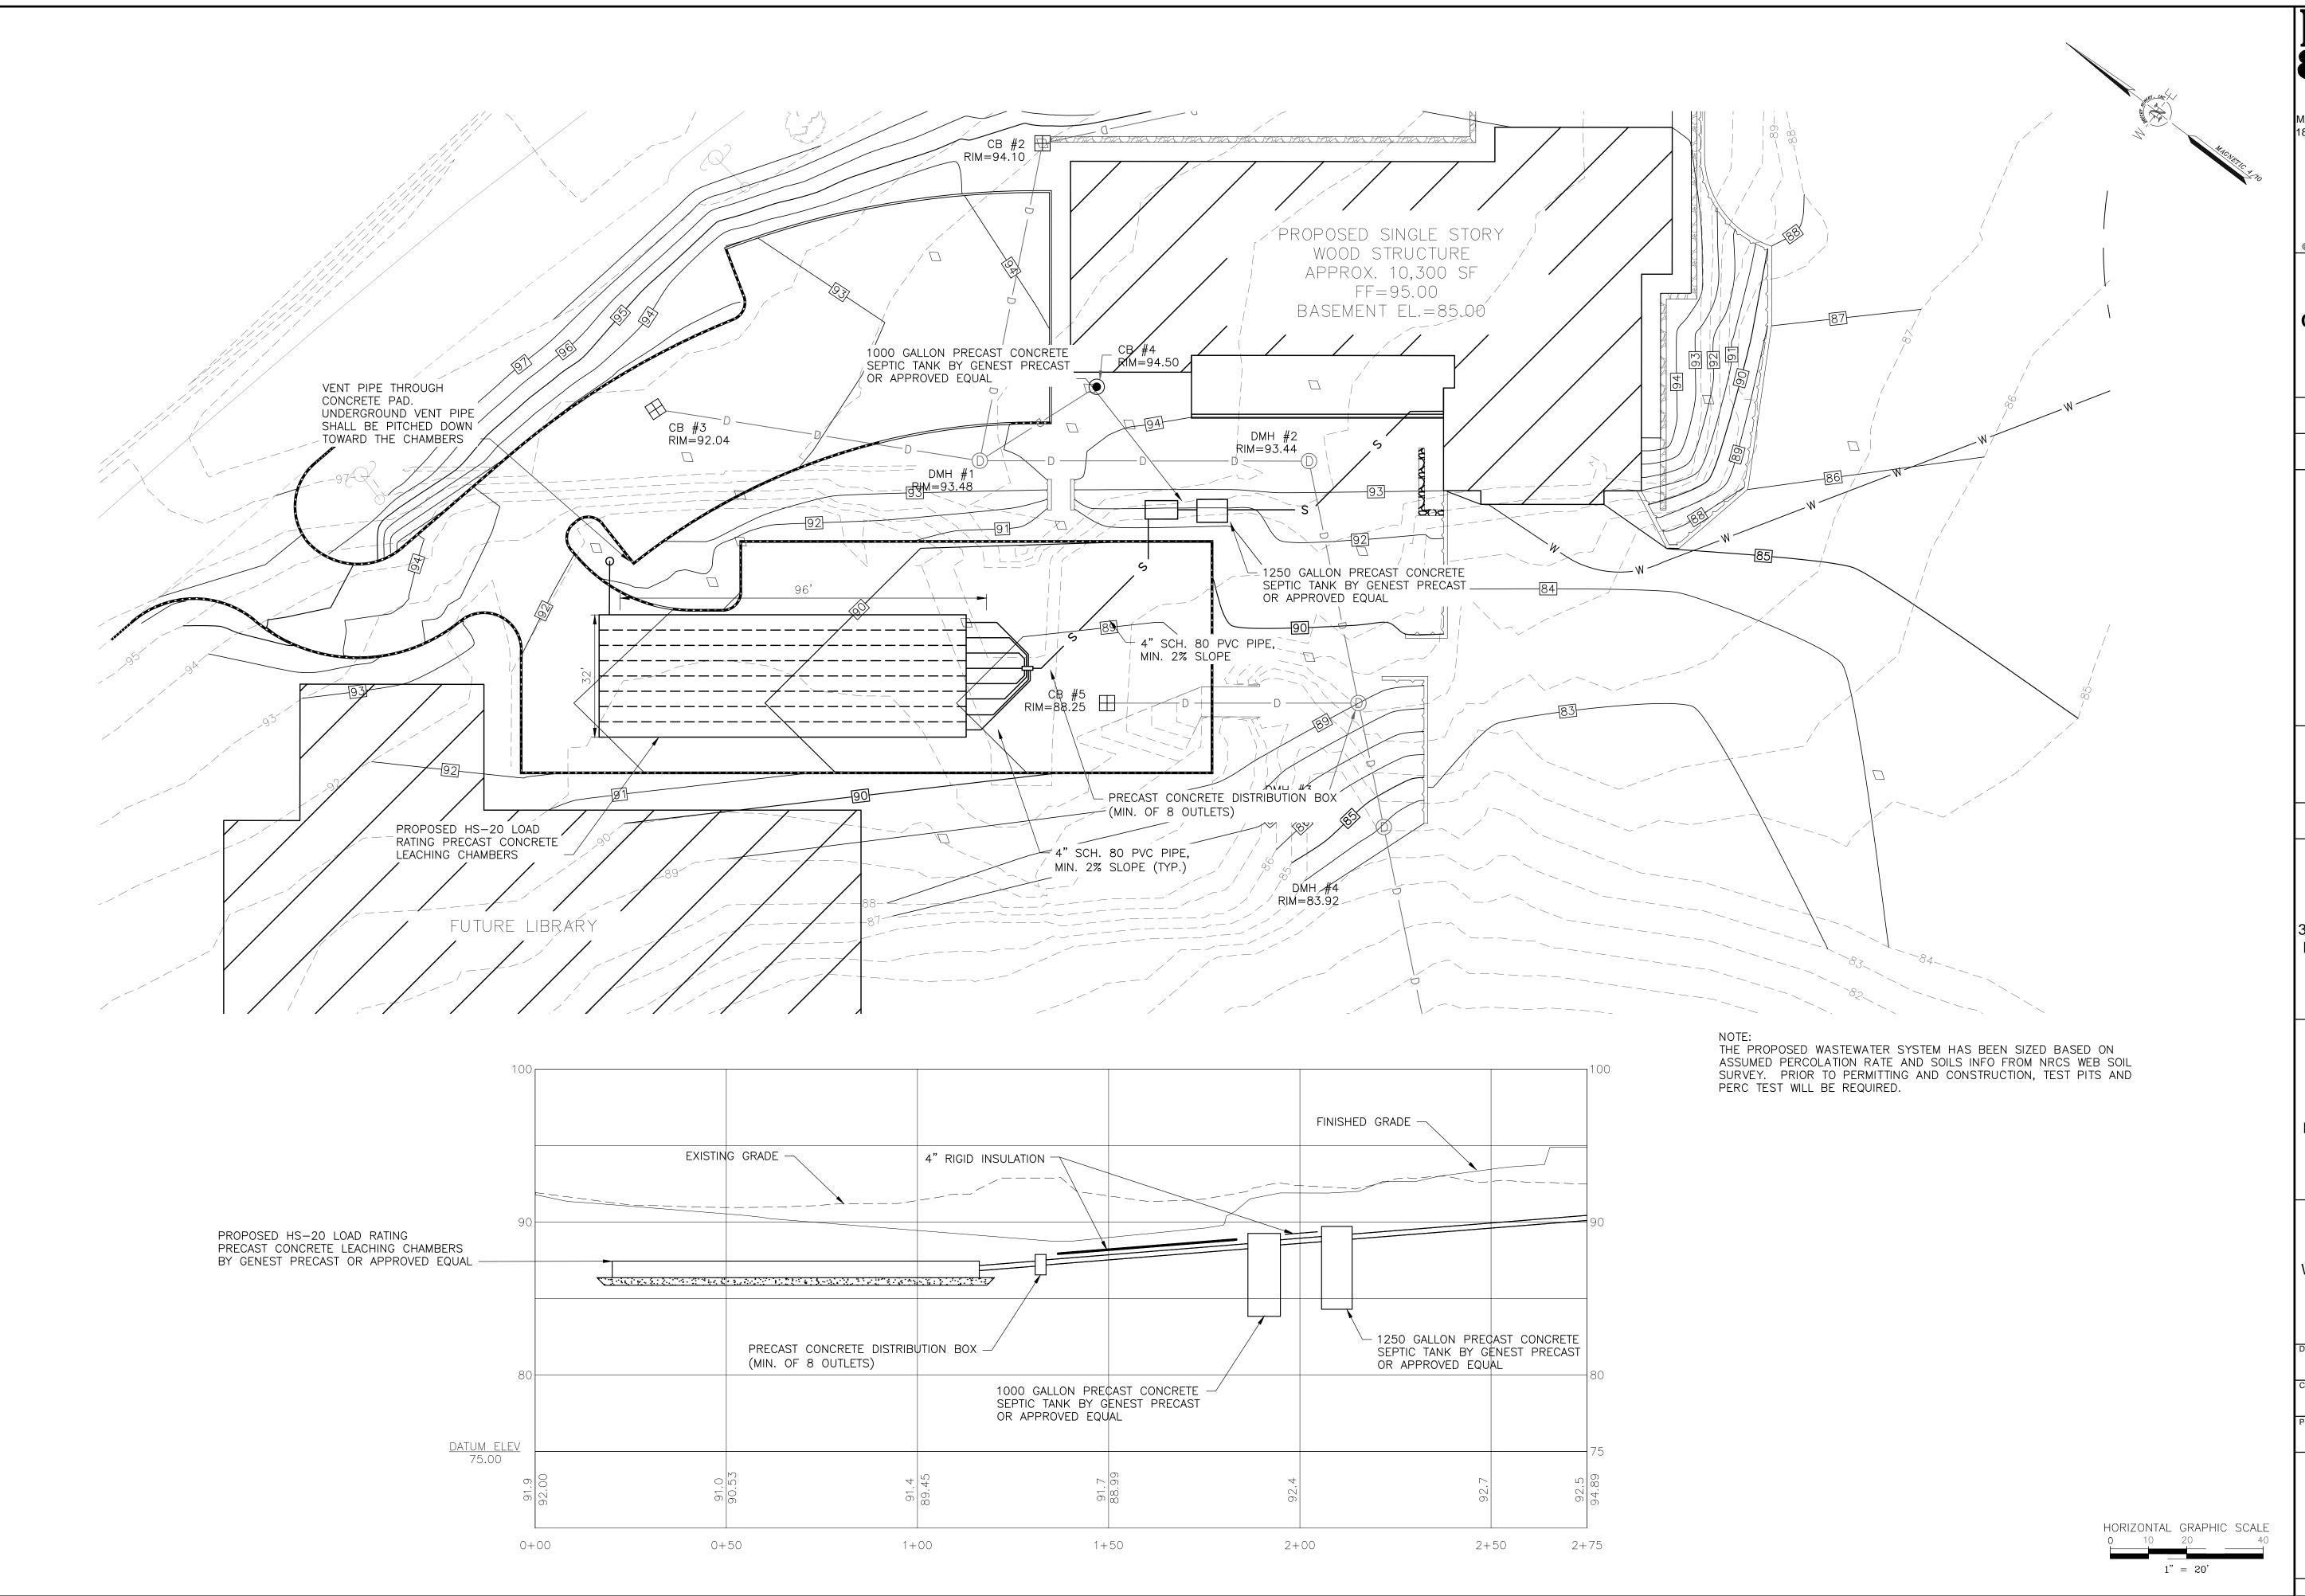
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SHEET 10 OF 13





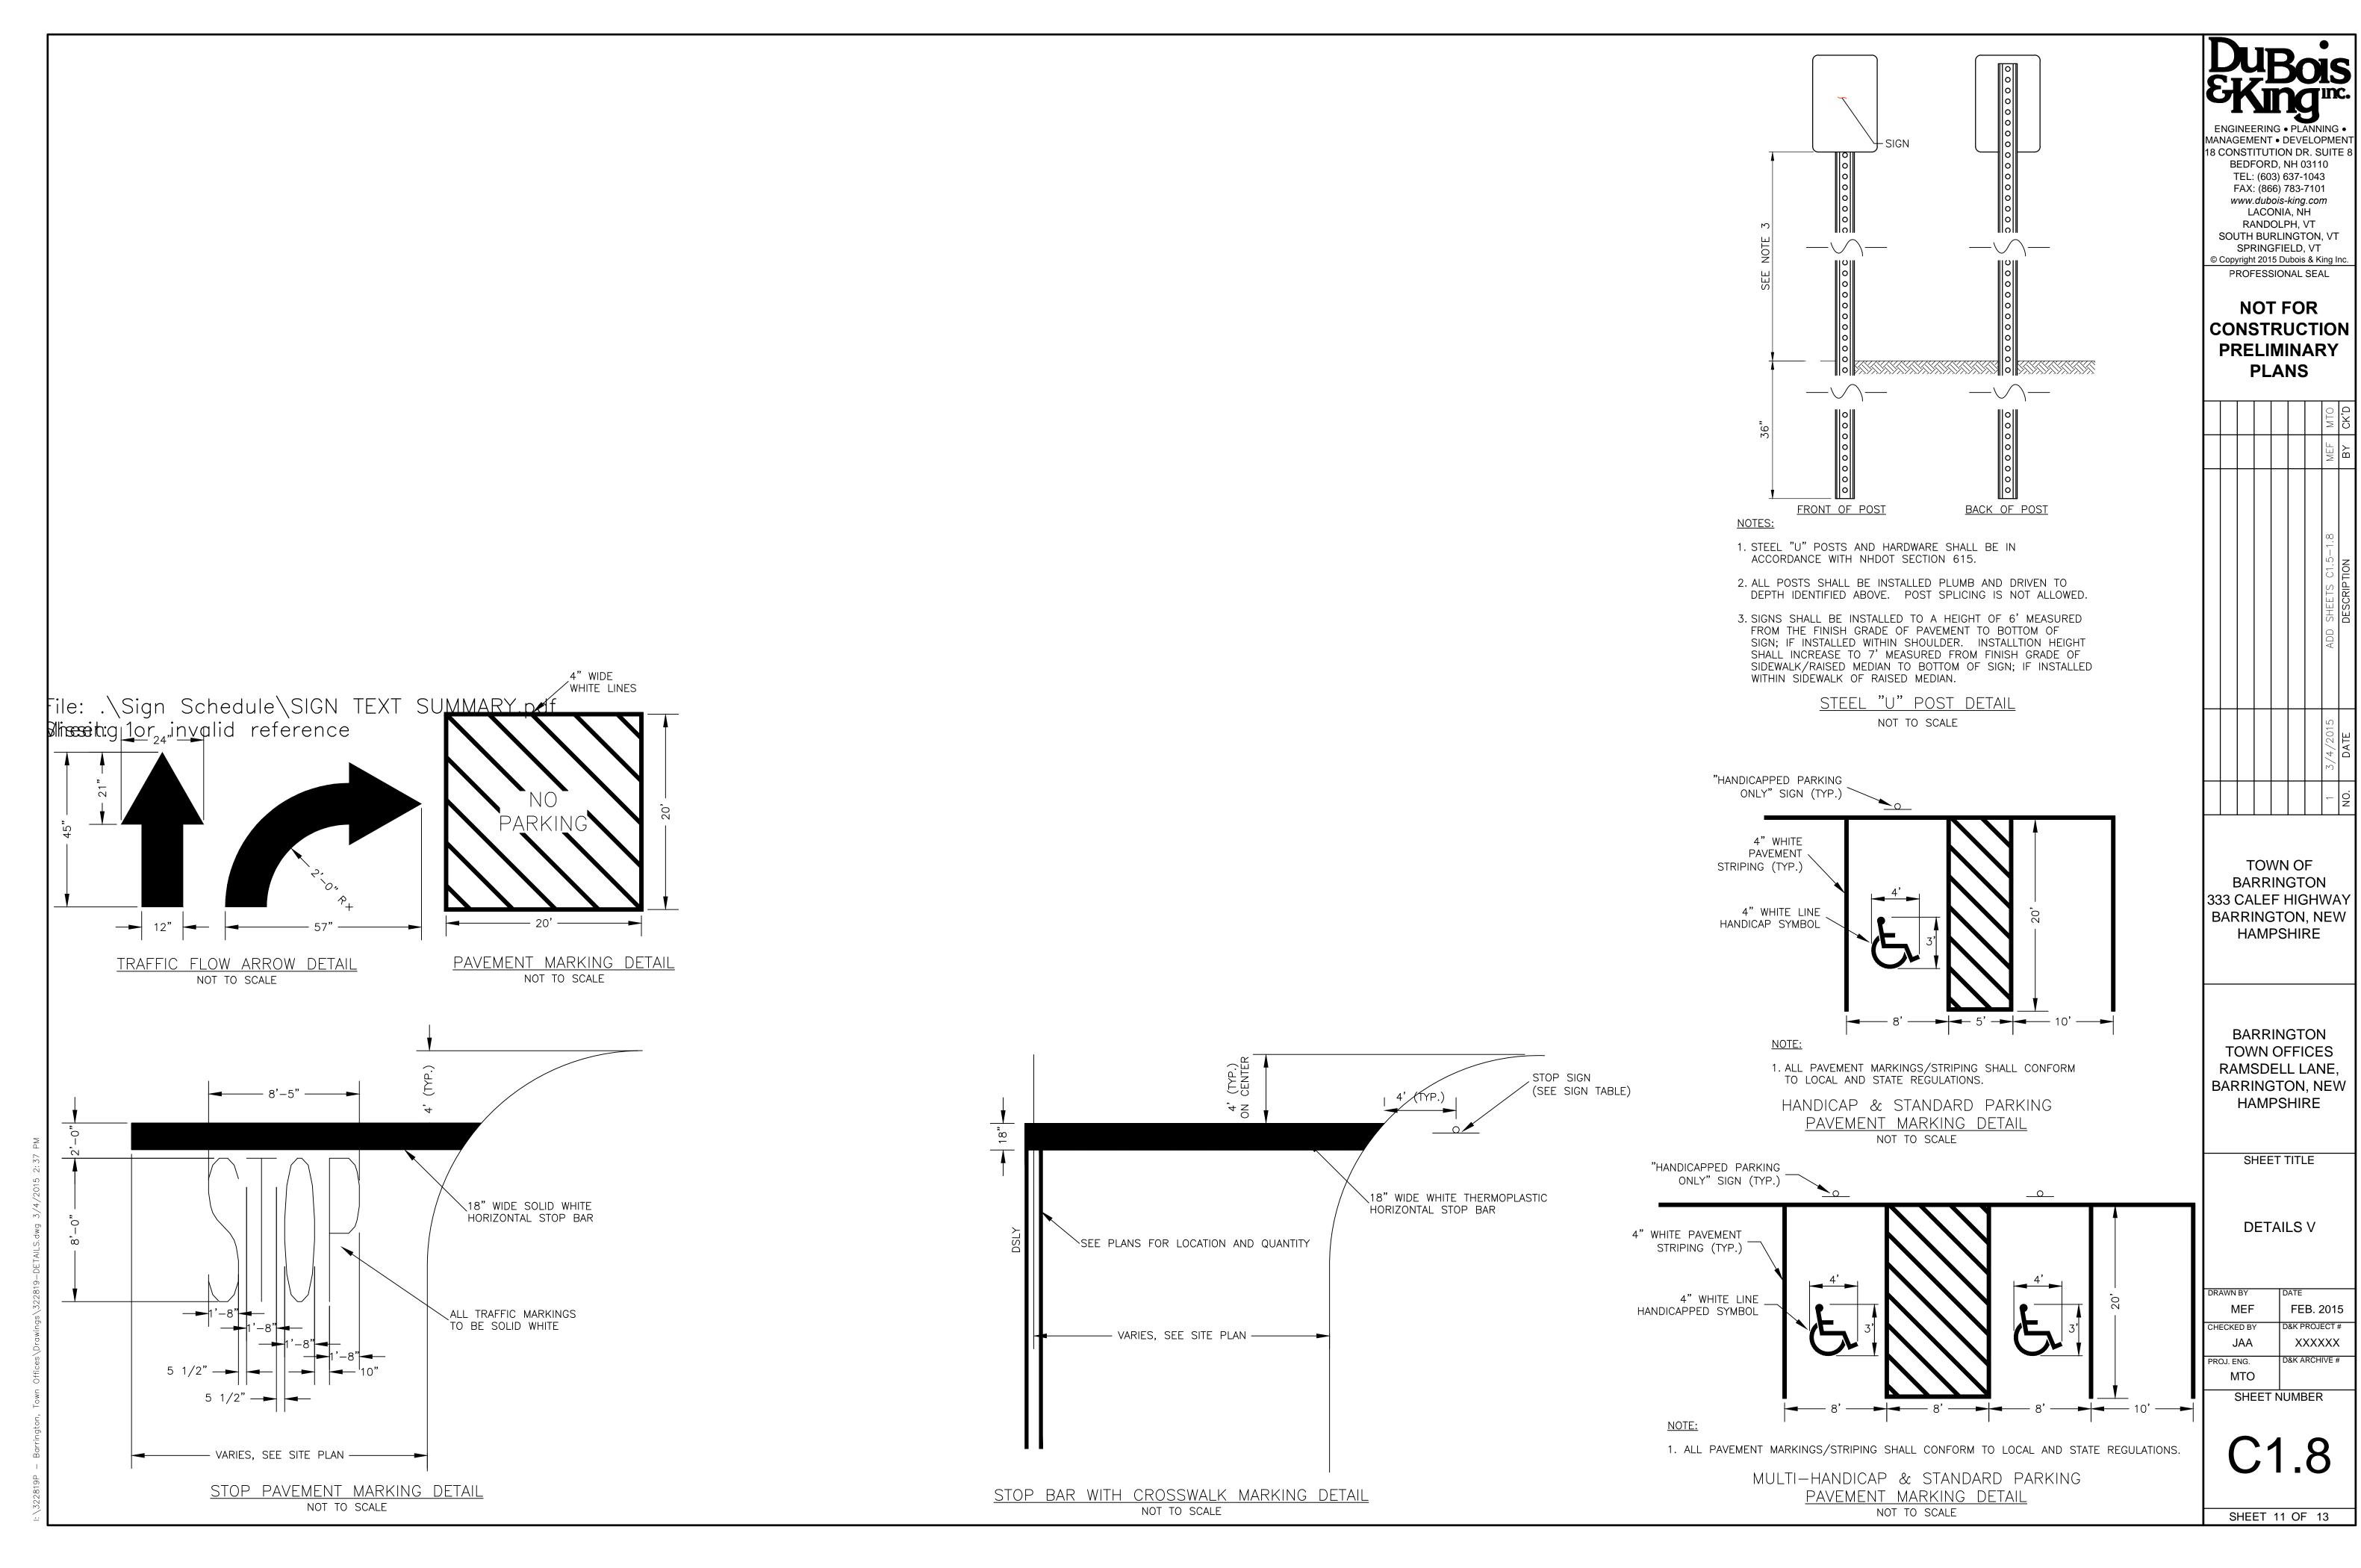


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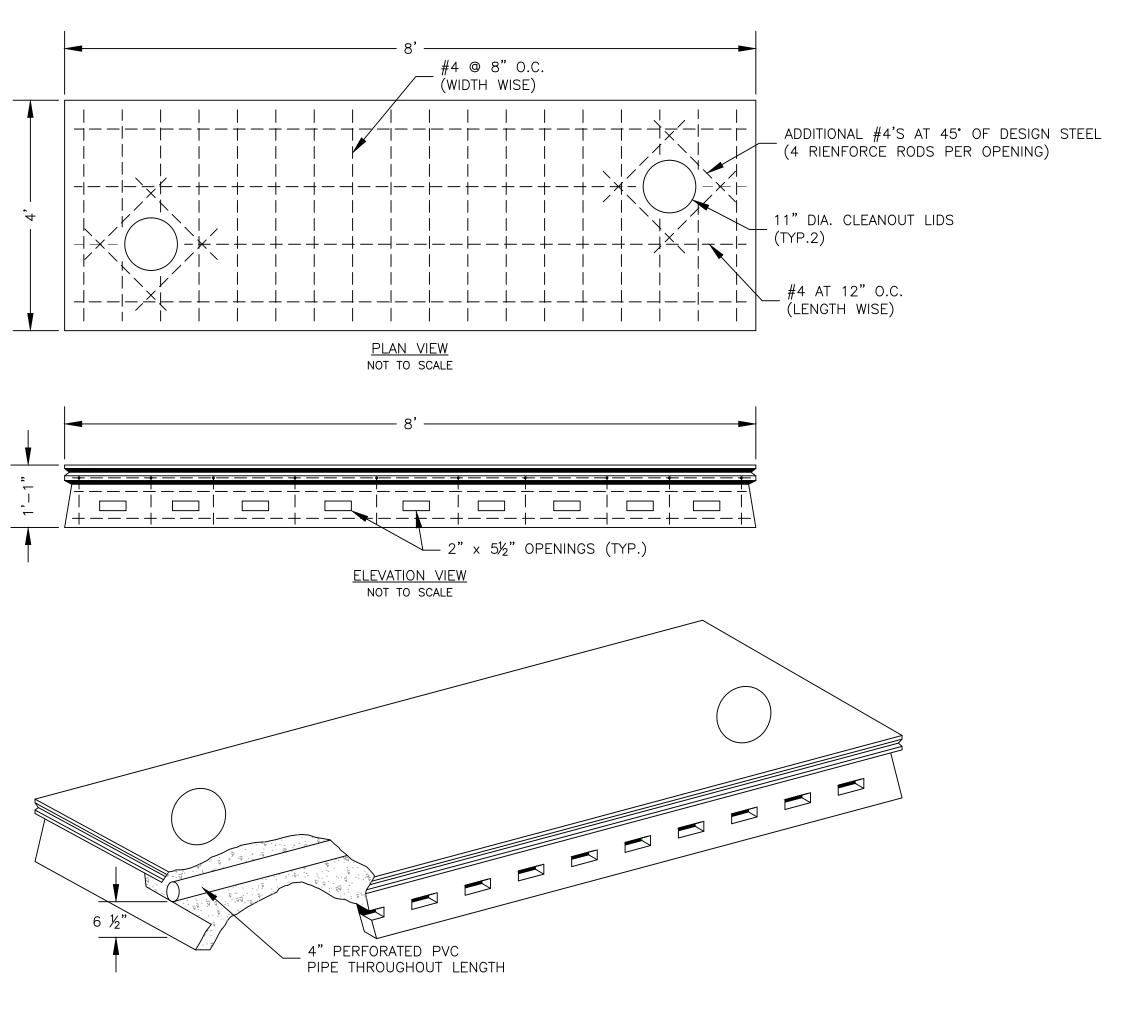
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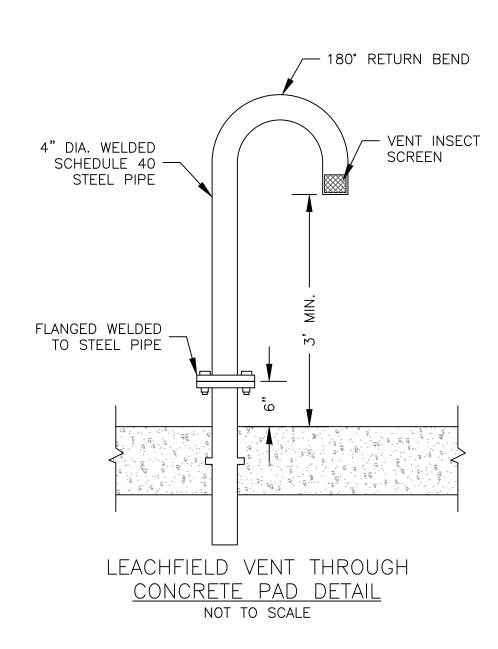
WASTEWATER PLAN AND PROFILE

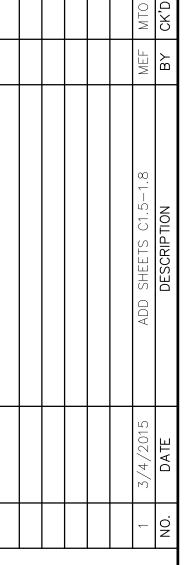ı	DRAWN BY	DATE	
	MEF	FEB. 2015	
	CHECKED BY	D&K PROJECT #	
	JAA	XXXXXX	
	PROJ. ENG.	D&K ARCHIVE #	
	MTO		
	SHEET NUMBER		

C2.1

SHEET 12 OF 13

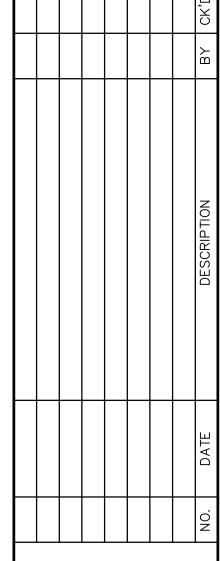



DESIGN AND CONSTRUCTION NOTES:

- 1. THIS SYSTEM IS DESIGNED FOR A DESIGN FLOW OF 1075 GALLONS PER DAY.
- 2. THE WASTEWATER SYSTEM CONSISTS OF A SEPTIC TANK, DISTRIBUTION BOX AND PRECAST CONCRETE CHAMBER DISPOSAL FIELD.
- 3. THE SEPTIC TANK SHALL BE A 2,160 GALLON PRECAST CONCRETE TANK BY L.E. WEEDS OF NEWPORT NH OR APPROVED EQUAL. THE TANK SHALL BE WATERTIGHT AND STRUCTURALLY SOUND. AN EFFLUENT FILTER ON THE OUTLET OF THE TANK, WHICH WILL PREVENT THE PASSAGE OF SOLIDS LARGER THAN 1/8—INCH IN SIZE TO THE LEACHFIELD SHALL BE INSTALLED IN THE SEPTIC TANK.
- 4. ANY FILL MATERIAL IN PROXIMITY OF THE PROPOSED DISPOSAL FIELD SHALL BE MEDIUM TO COURSE TEXTURED SAND, WITH AN EFFECTIVE SIZE OF 0.25 TO 2.00mm, NO GRATER THAN 5% PASSING THE NUMBER 200 SIEVE, AND NO PARTICLES LARGER THAN 3/4 INCH.

OPERATION AND MAINTENANCE NOTES:

- 1. SEPTIC TANK EFFLUENT FILTER IS TO BE INSPECTED AND CLEANED EVERY SIX MONTHS. SEPTIC TANK SHOULD BE PUMPED OUT AND CLEANED EVERY THREE YEARS.
- 2. OWNER IS WARNED THAT GARBAGE DISPOSALS, LAUNDRY BLEACH, ANTI-BACTERIAL SOAP, HAZARDOUS MATERIALS, AND HOUSEFOLD CLEANERS WILL REDUCE THE LIFE OF SEPTIC SYSTEM.
- 3. IT IS THE OWNERS'S RESPONSIBILITY TO BECOME FAMILIAR WITH THESE PLANS IN REGARDS TO THE OVERALL PROJECT AND FUTURE USE OF THE PROPERTY. CARE SHALL BE TAKEN TO MAINTAIN THE SYSTEM REPLACEMENT AREA UNDISTURBED AND OBSERVE SETBACK REQUIREMENTS FOR ANY FUTURE CONSTURCTION.

BASIS OF DESIGN (HS-20 LOAD RATED CHAMBER SYSTEM): DESIGN PARAMETERS OBTAINED FROM THE NEW HAMPSHIRE DEPARTMENT OF ENVIRONMENTAL SERVICES' CODE OF

ADMINISTRATIVE RULES FOR INDIVIDUAL SEWAGE DISPOSAL SYSTEMS (Env-Ws 1000).

1. DESIGN FLOW:
BASED ON TABLE 1008-1 (UNIT DESIGN FLOW FIGURES).

15 GPD/EMPLOYEE X 20 EMPLOYEES = 300 GALLONS/DAY
5 GPD/TRANSIENT VISITORS X 60 VISITORS = 300 GALLONS/DAY
5 GPD/PER SEAT OF CAPACITY X 85 SEAT CAPACITY = 425 GALLONS/DAY

1025 GALLONS/DAY OF SANITARY FLOW

2. SEPTIC TANK SIZING: 1025 GPD X 2 = 2050 GAL SEPTIC STORAGE (MIN)

USE: 1,250 GALLON AND A 1,000 GALLON PRECAST CONCRETE SEPTIC TANKS

3. SEPTIC TANK EFFLUENT FILTER:
USE A SEPTIC TANK EFFLUENT FILTER SYSTEM FOR REDUCTION OF SUSPENDED SOLIDS, BODs AND OIL & GREASE IN THE
EFFLUENT WASTE STREAM FROM THE TANK TO THE ABSORPTION TRENCH DISPOSAL FIELD.

4. PERCOLATION RATE:

ASSUME PERCOLATION RATE OF 30 MIN/INCH

- 5. LOADING RATE FOR ABSORPTION CHAMBERS:
 BASED ON TABLE 1014-1 FOR COMMERCIAL LOADING FOR 100 GALLONS PER DAY WITH A PERCOLATION RATE OF 30 MINUTES
 PER INCH IS 290 SQUARE-FEET, SO TOTAL AREA IS 2937 SQUARE-FEET.
- 6. SYSTEM TYPE:
 USE CHAMBER SYSTEM LEACH FIELD.
- 7. SYSTEM DESIGN: CHAMBER AREA — USE 8 ROWS OF 12 CHAMBERS 4'x8'.

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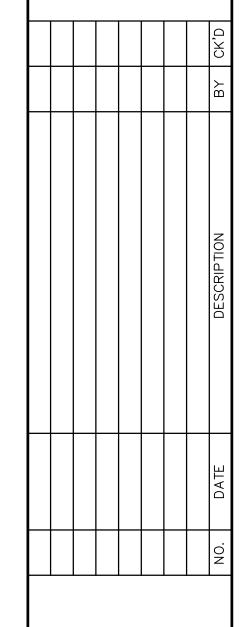
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SHEET TITLE

WASTEWATER DETAILS

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C2.2

SHEET 13 OF 13


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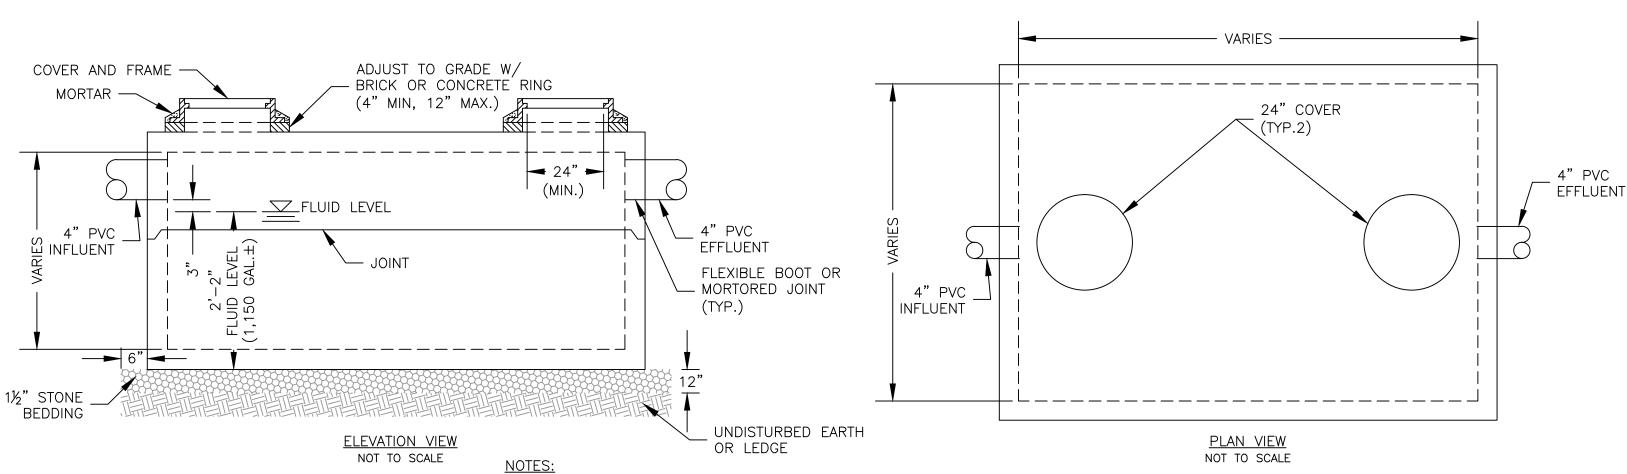
1. CHAMBER SECTION SHALL MEET HS-20 LOADING AND SHALL BE MANUFACTURED IN ACCORDANCE WITH ASTM C 478, LATEST REVISIONS.

2. DESIGN FILL SHALL BE 2'.

- 3. CONCRETE SHALL 4,000 PSI AT 28 DAYS, WHILE CEMENT SHALL BE TYPE III PER ASTM C-150.
- 4. REINFORCING fy SHALL BE 60,000 PSI, PER ASTM A-615,
- 5. ADDITIONAL REINFORCING AROUND CLEANOUT OPENINGS EQUAL TO THE BARS INTERRUPTED, HALF EACH SIDE, WITH #4 DIAGONAL TRIM BARS.



SANITARY 4'x8' HS-20 LEACHING CHAMBER DETAIL NOT TO SCALE

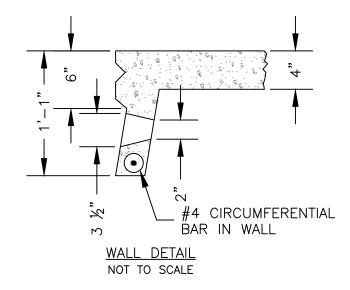

1. PRECAST SECTIONS SHALL BE 6" THICK WITH 0.12 SQ.IN/FT. AREA OF STEEL REINFORCEMENT OR 8" THICK UNREINFORCED.

2. USE PRECAST CONCRETE 1000 AND 1250 GALLON SEPTIC TANK AS PER GENEST PRECAST OR APPROVED EQUAL

SEPTIC TANK DETAIL NOT TO SCALE