




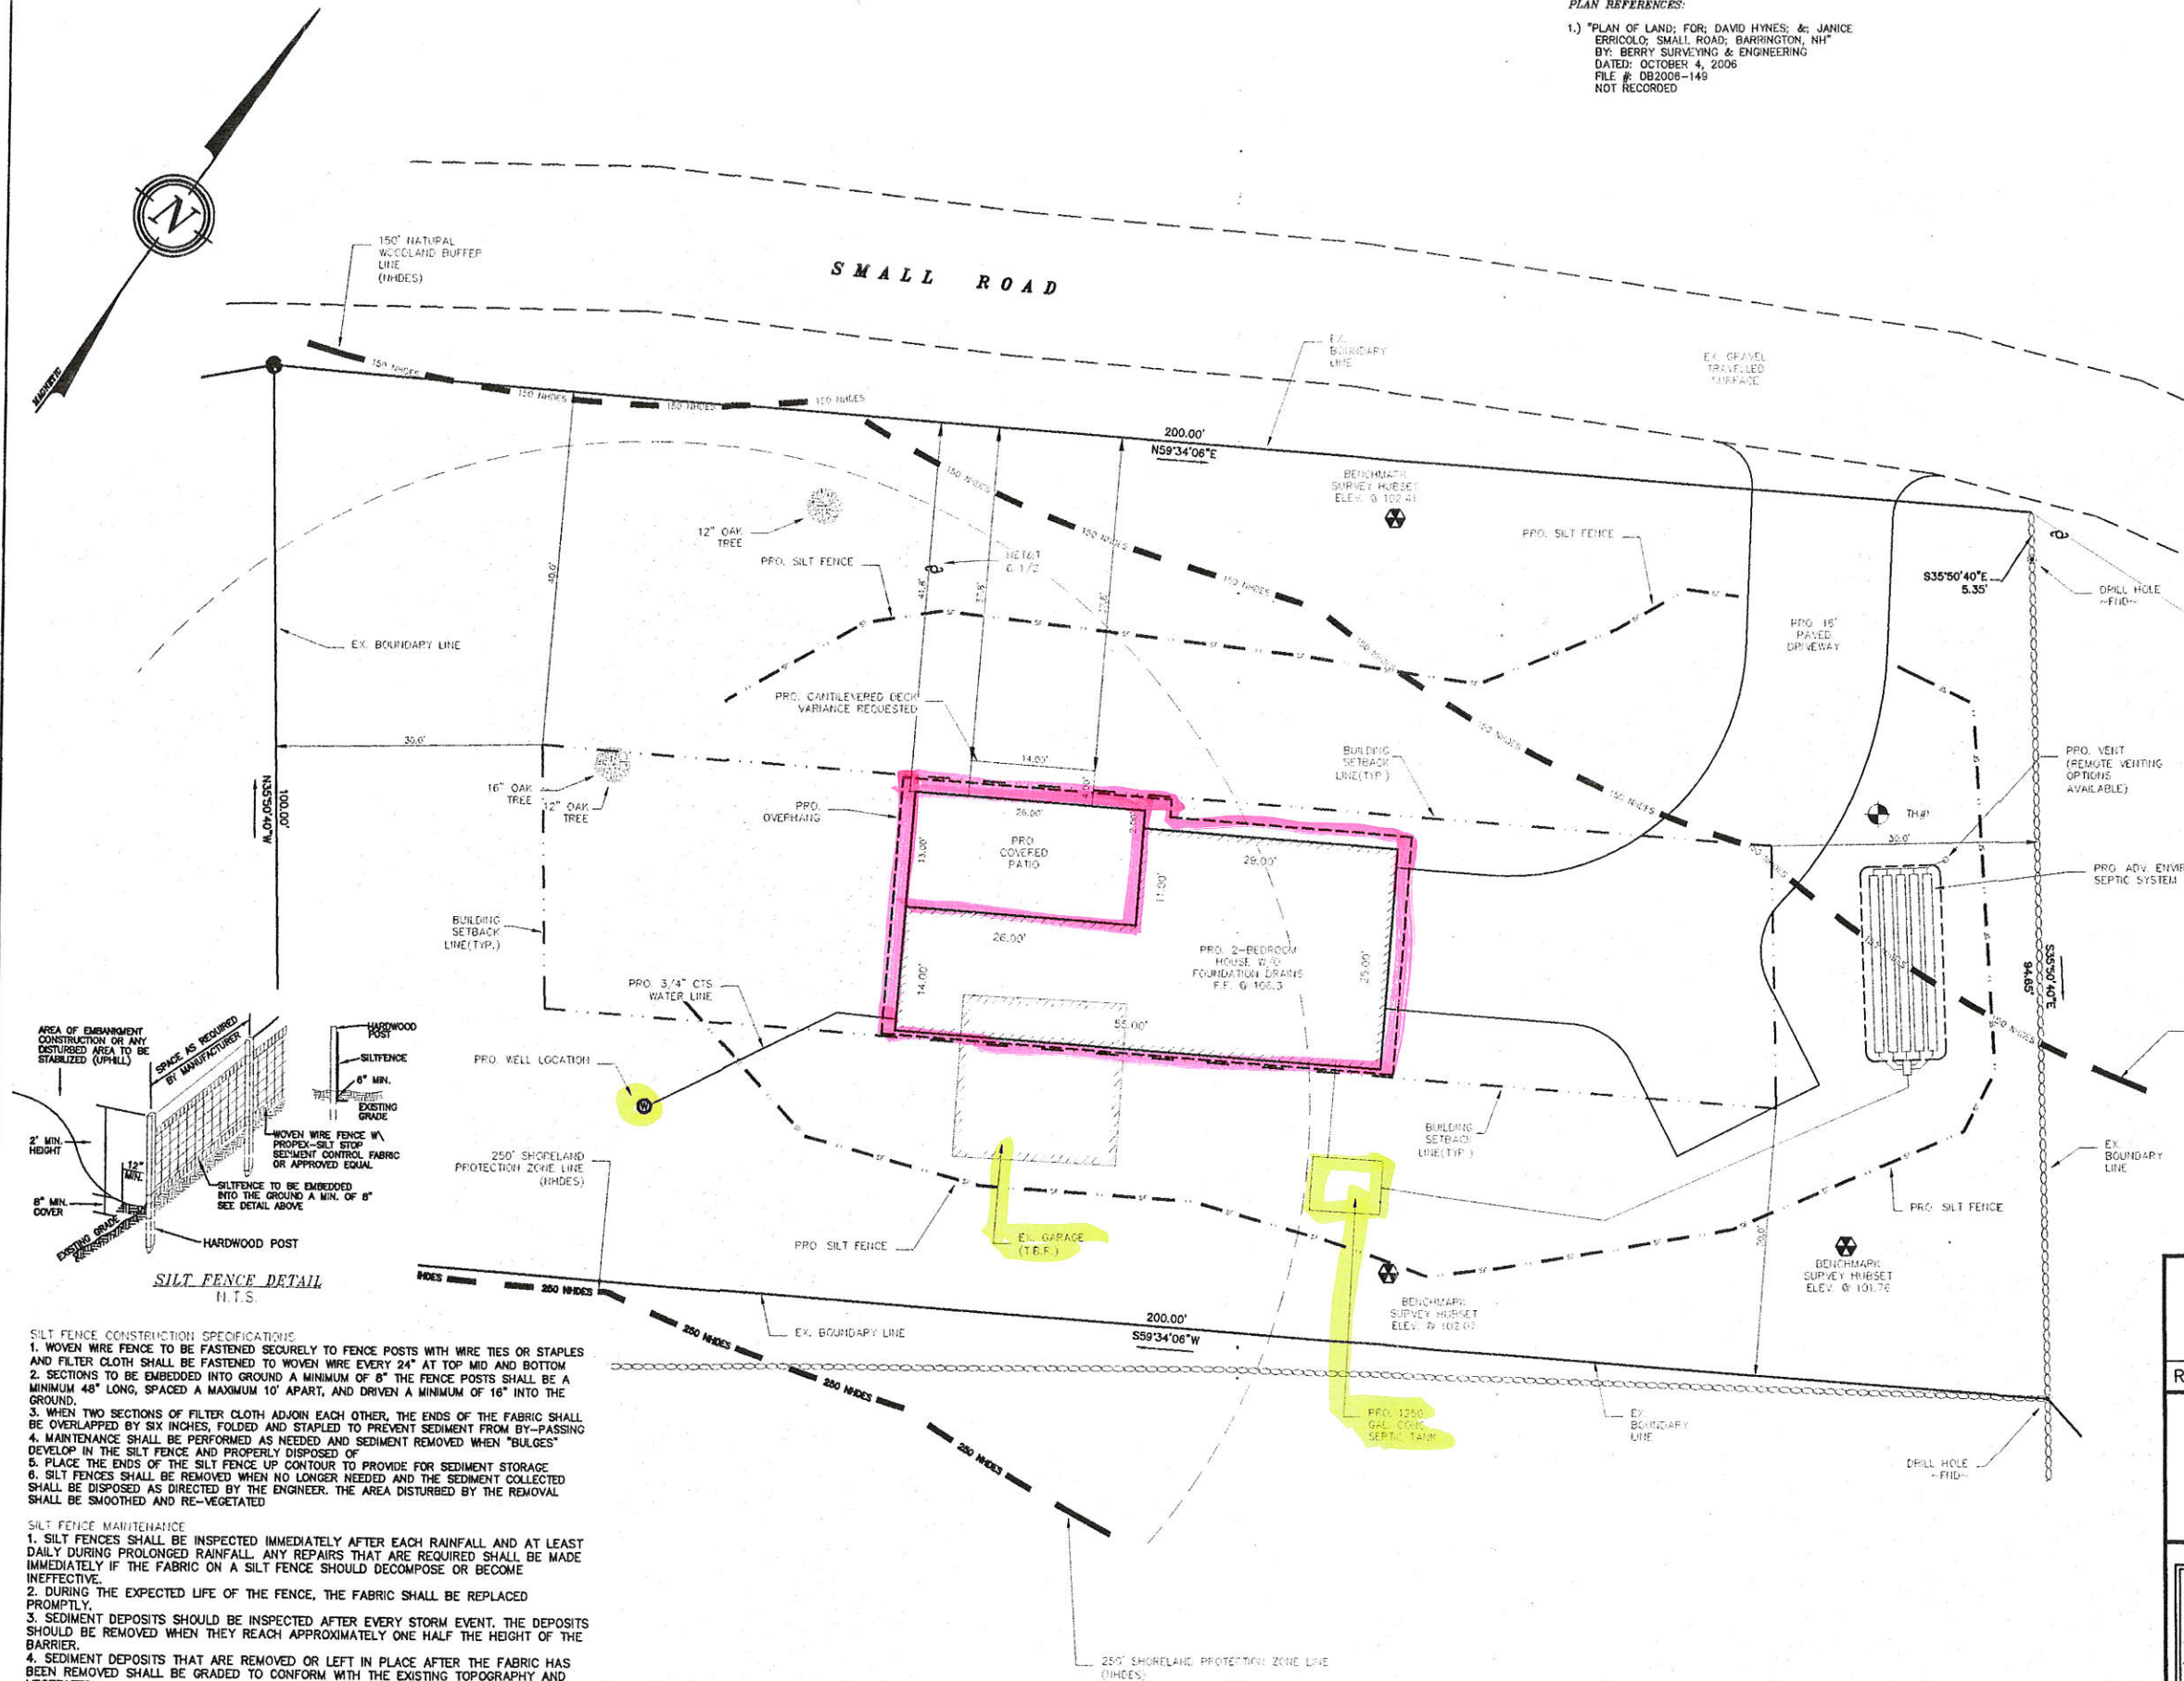
PLAN REFERENCES:
 1.) "PLAN OF LAND FOR: DAVID HYNES, & JANICE
 ERRICOLA; SMALL ROAD; BARRINGTON, NH"
 BY: BERRY SURVEYING & ENGINEERING
 DATED: OCTOBER 4, 2006
 FILE #: DB2006-149
 NOT RECORDED

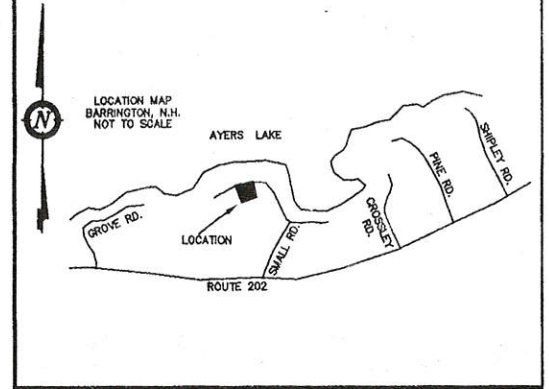

- NOTES:
- 1.) OWNER: JANICE ERRICOLA
PO BOX 1362
WARREN, MA 01083
 - 2.) TAX MAP 107, LOT 4
 - 3.) LOT AREA: 19,911 Sq.Ft., 0.46 Ac.
 - 4.) S.C.R.D. BOOK 1087, PAGE 316
 - 5.) THE PURPOSE OF THIS PLAN IS TO PROVIDE SUPPORTING DOCUMENTATION FOR A ZONING VARIANCE APPLICATION. PLEASE SEE PLAN REF. #1 FOR COMPLETE BOUNDARY INFORMATION.
 - 6.) LOT COVERAGE:
EXISTING - 2%
PROPOSED - 17%
 - 7.) THIS PROJECT WILL ALSO REQUIRE NHDES SHORELAND APPROVAL AND NHDES (SDS) (SEPTIC) APPROVAL.

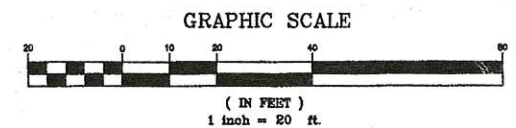

REVISION	DATE	DESCRIPTION
PROPOSED CONDITIONS PLAN FOR JANICE ERRICOLA SMALL ROAD BARRINGTON, N.H. TAX MAP 107, LOT 4		
 BERRY SURVEYING & ENGINEERING 335 SECOND CROWN POINT RD. BARRINGTON, N.H. 332-2863 SCALE : 1 IN. EQUALS 20 FT. DATE : AUGUST 13, 2015 FILE NO. : DB 2015-076		



- SILT FENCE CONSTRUCTION SPECIFICATIONS**
1. WOVEN WIRE FENCE TO BE FASTENED SECURELY TO FENCE POSTS WITH WIRE TIES OR STAPLES AND FILTER CLOTH SHALL BE FASTENED TO WOVEN WIRE EVERY 24\"
 2. SECTIONS TO BE EMBEDDED INTO GROUND A MINIMUM OF 8\"
 3. WHEN TWO SECTIONS OF FILTER CLOTH ADJOIN EACH OTHER, THE ENDS OF THE FABRIC SHALL BE OVERLAPPED BY SIX INCHES, FOLDED AND STAPLED TO PREVENT SEDIMENT FROM BY-PASSING
 4. MAINTENANCE SHALL BE PERFORMED AS NEEDED AND SEDIMENT REMOVED WHEN \"BULGES\" DEVELOP IN THE SILT FENCE AND PROPERLY DISPOSED OF
 5. PLACE THE ENDS OF THE SILT FENCE UP CONTOUR TO PROVIDE FOR SEDIMENT STORAGE
 6. SILT FENCES SHALL BE REMOVED WHEN NO LONGER NEEDED AND THE SEDIMENT COLLECTED SHALL BE DISPOSED AS DIRECTED BY THE ENGINEER. THE AREA DISTURBED BY THE REMOVAL SHALL BE SMOOTHED AND RE-VEGETATED
- SILT FENCE MAINTENANCE**
1. SILT FENCES SHALL BE INSPECTED IMMEDIATELY AFTER EACH RAINFALL AND AT LEAST DAILY DURING PROLONGED RAINFALL. ANY REPAIRS THAT ARE REQUIRED SHALL BE MADE IMMEDIATELY IF THE FABRIC ON A SILT FENCE SHOULD DECOMPOSE OR BECOME INEFFECTIVE.
 2. DURING THE EXPECTED LIFE OF THE FENCE, THE FABRIC SHALL BE REPLACED PROMPTLY.
 3. SEDIMENT DEPOSITS SHOULD BE INSPECTED AFTER EVERY STORM EVENT. THE DEPOSITS SHOULD BE REMOVED WHEN THEY REACH APPROXIMATELY ONE HALF THE HEIGHT OF THE BARRIER.
 4. SEDIMENT DEPOSITS THAT ARE REMOVED OR LEFT IN PLACE AFTER THE FABRIC HAS BEEN REMOVED SHALL BE GRADED TO CONFORM WITH THE EXISTING TOPOGRAPHY AND VEGETATED.



FRONT ELEVATION

SCALE: 3/16" = 1'-0"

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GENERAL NOTES:

1. THE GENERAL CONTRACTOR SHALL REVIEW BUILDING PLANS PRIOR TO CONSTRUCTION AND VERIFY THAT ALL BUILDINGS AND STRUCTURES AND ALL PARTS THEREOF, SHALL BE CONSTRUCTED TO SAFELY SUPPORT ALL LOADS, INCLUDING DEAD LOADS, LIVE LOADS, ROOF LOADS, FLOOD LOADS, SNOW LOADS, WIND LOADS AND SEISMIC LOADS AS PRESCRIBED BY 2009 IRC.
2. THE GENERAL CONTRACTOR SHALL SECURE ALL REQUIRED PERMITS PRIOR TO PROCEEDING WITH CONSTRUCTION.
3. PLANS AND SPECIFICATIONS HAVE NOT BEEN PREPARED BY A REGISTERED ARCHITECT OR STRUCTURAL ENGINEER. ALL FOUNDATIONS AND STRUCTURAL MEMBERS SHOULD BE VERIFIED AND STAMPED BY AN ENGINEER IN THE STATE WHERE CONSTRUCTION IS OCCURRING. THE GENERAL CONTRACTOR IS RESPONSIBLE FOR ADJUSTING AND VERIFYING ALL STRUCTURAL DETAILS AND CONDITIONS TO MEET ALL LOCAL CODES, AND TO INSURE A QUALITY AND SAFE STRUCTURE.
4. ALL INSTALLATION OF MECHANICAL, HEATING, VENTILATION AND ELECTRICAL COMPONENTS SHALL BE IN CONFORMANCE WITH STATE AND LOCAL BUILDING CODES. ALL WORK SHALL BE PERFORMED BY PERSONS QUALIFIED IN THEIR TRADE AND LICENSED TO PRACTICE SUCH TRADE IN THE STATE IN WHICH THE WORK IS PERFORMED.
5. ALL CONTRACTORS SHALL TAKE ALL PRECAUTIONS AND PROVIDE ADEQUATE GUARDS AND BARRIERS TO PREVENT INJURY TO PERSONS AND PROPERTY.
6. THE GENERAL CONTRACTOR SHALL COORDINATE ALL UTILITY INSTALLATIONS WITH THE APPROPRIATE COMPANY.
7. DO NOT SCALE DRAWINGS. ALL WRITTEN DIMENSIONS TAKE PREFERENCE. ALL CONTRACTORS SHALL REVIEW ALL DRAWINGS BEFORE PROCEEDING. REQUEST CLARIFICATION FOR ANY DIMENSIONS REQUIRED. ALL DIMENSIONS, ELEVATIONS, AND CONDITIONS SHALL BE VERIFIED IN THE FIELD BY THE GENERAL CONTRACTOR.
8. REFER TO SECTION R314, 2009 IRC FOR SMOKE ALARM REQUIREMENTS. REFER TO SECTION R315, 2009 IRC FOR CARBON MONOXIDE ALARM REQUIREMENTS.

NEUMARKET PLAINS, LLC.
HOME DESIGN SERVICE
NEUMARKETPLAINSLLC@COMCAST.NET
WWW.NEUMARKETPLAINSLLC.COM
603-659-0985

DATE	DESCRIPTION
5/1/15	Draft Released to Client
6/6/15	Final Review Released to Client
	Not for Construction
6/8/15	Final Plans Released to Client

Mike and Janice Erricolo
140 Small Road
Barrington, NH, 03825
413-348-9554

SHEET NUMBER

1

PLAN NUMBER

7713



LEFT SIDE ELEVATION

SCALE: 3/16" = 1'-0"

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NEUMARKET PLAINS, LLC.

HOME DESIGN SERVICE

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140 Small Road
Barrington, NH, 03825
413-348-9554

SHEET NUMBER

2

PLAN NUMBER

773



RIGHT SIDE ELEVATION

SCALE: 3/16" = 1'-0"

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SHEET NUMBER

3

PLAN NUMBER

773

