PROPOSED SITE PLAN "TROPIC STAR CONVENIENCE" TAX MAP 238, LOT 4 ROUTE 125, BARRINGTON, NH

SITE BOUTE (/ O

LOCUS MAP

TYPE OF PERMIT

PERMITS

NHOOT DRIVEWAY PERMIT: NEW HAUDS URE DEPARTMENT O TRANSPORTATION, DISTRICT SIX P.O. BOX 740 DURHAM, NEW HAMP (603) 888-1133

RESPONSIBLE CONSULTANT-JONES & BEACH EN


NHDES INDIVIDUAL SEWAGE DISPOSAL SYSTEM: WEW HAMPSHIRE DEPARTMENT O P.O. BOX 95, 29 HAZEN DRIVE CONCORD, NEW HAMPSHIRE 03302

RESPONSIBLE CONSULTANT-JONES & BEACH ENGINEERS, INC.

USEPA NPDES PHASE II CONSTRUCTION GENERAL PERMIT. NOTICE OF INTENT (NOI), AND NOTICE OF TERMINATION (NOT) TO BE FILED IN ACCORDANCE WITH FEDERAL AND LOCAL REGULATIONS PRIOR TO AND FOLLOWING CONSTRUCTION EPA STORMWATER NOTICE PROCESSING CENTER MAIL CODE 4203M, US EPA

1200 PENNSYLVANIA AVENUE, NW WASHINGTON, DC 20460 RESPONSIBLE CONSULTANT: JONES & BEACH ENG

NOTES:

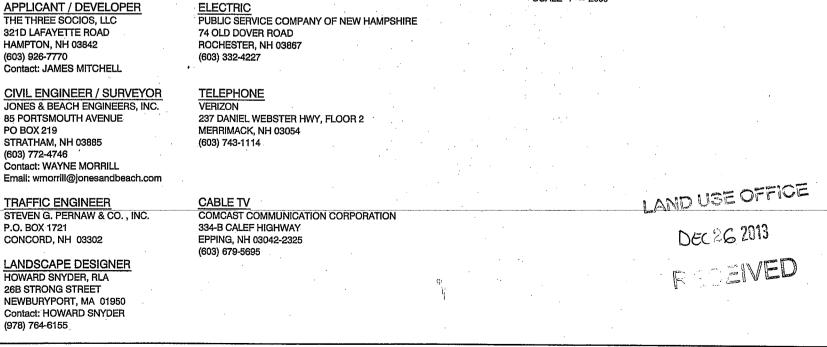

BWG


BWG

CSA

WGM

BWG

BY

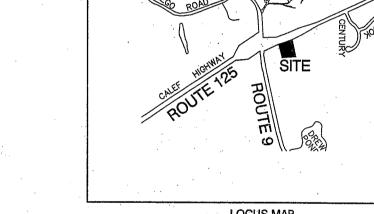

SCALE 1" = 2000'

HOWARD SNYDER, RLA 26B STRONG STREET

NEWBURYPORT, MA 01950 Contact: HOWARD SNYDER (978) 764-6155

Design: WGM | Draft: GP Checked: WGM Scale: AS NOTED Project No.:10144 Drawing Name: 10144-PLAN.dwg THIS PLAN SHALL NOT BE MODIFIED WITHOUT WRITTEN PERMISSION FROM JONES & BEACH ENGINEERS, INC. (JBE). ANY ALTERATIONS, AUTHORIZED OR OTHERWISE, SHALL BE AT THE USER'S SOLE RISK AND WITHOUT LIABILITY TO JBE.

SHEET INDEX

COVER SHEET

SITE PLAN

HX1-HX3 CROSS SECTION PLANS

I IGHTING PLAN

LANDSCAPE PLAN

LANDSCAPE DETAILS

LANDSCAPE DETAILS

LANDSCAPE SPECS

DETAIL SHEETS

EXISTING CONDITIONS PLAN

GRADING AND DRAINAGE PLAN

HIGHWAY ACCESS PLAN - PHASE 1

HIGHWAY ACCESS PLAN - PHASE 2

LANDSCAPE NOTES AND LEGEND

EFFLUENT DISPOSAL DESIGN

ARCHITECTURAL RENDERING

EROSION AND SEDIMENT CONTROL DETAILS

DRIVEWAY MARKING PLAN

OVERALL VICINITY PLAN

CS

C1

C2

СЗ

C4

HA1

HA2

M1

L1

L2.0

L3.0


L4.0 L4.1

15.0

S1


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D1-D3

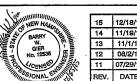

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13	REVISED PER TOWN REVIEW	
13	REVISED PER TOWN REVIEW	
13	REVISED PER NHDES DRINKING WATER BUREAU	
13	REVISED PER NHDOT SITE MEETING	
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=	REVISION	

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J/D Ione		Pacab	Engineeng	T] [Plan Name:
B5 Portsmouth Ave.		· · · · · · · · · · · · · · · · · · ·	Engineers,	603-772-4746		Project:
PO Box 219 Stratham, NH 03885	GIUU	Lagineerin	g Services E-Mali: JBE@	FAX: 603-772-0227 JONÈSANDBEACH.COM		Owner of Record:

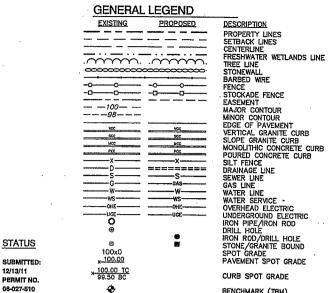

8/2/2014 SUBMITTED: 1/17/12 PERMIT NO. CA201210761 DATED:

DATED

8/2/2013

EXPIRATION

2/21/12 EXPIRATION: 2/12/16

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5724 M

BENCHMARK (TBM) DOUBLE POST SIGN SINGLE POST SIGN WELL TEST PIT PERC TEST TREES AND BUSHES UTILITY POLE LIGHT POLES DRAIN MANHOLE SEWER MANHOLE SEWER MANHOLE HYDRANT WATER GATE WATER SHUT OFF REDUCER SINGLE GRATE CATCH BASIN DOUBLE GRATE CATCH BASIN TEANSCODUED DOUBLE GRATE CATCH BASIN TRANSFORMER CULVERT W/WINOWALLS CULVERT W/FLARED-END SECTION CULVERT W/FLARED-END SECTION CULVERT W/FLARED-END STONE CHECK DAM DRAINAGE FLOW DIRECTION

RIPRAP FRESHWATER WETLANDS

STABILIZED CONSTRUCTION

CONCRETE

GRAVEL

SNOW STORAGE

PROJECT PARCEL OWN OF BARR TAX MAP 238, LOT 4

APPLICANT THE THREE SOCIOS, LLC 321D LAFAYETTE BOAD HAMPTON, NH 03842 BOOK 3937, PAGE 0522

TOTAL LOT AREA 80,273,55 SQ, FT. 1.84 ACRES

PLANNING BOARD APPROVAL BLOCK

IF, DURING CONSTRUCTION, IT BECOMES APPARENT THAT DEFICIENCIES EXIST IN THE APPROVED DESIGN DRAMINGS, THE CONNER SHALL BE REQUIRED TO CORRECT THE DEFICIENCIES TO MEET THE REQUIREMENTS OF THE REQUIATIONS AT NO EXPENSE TO THE TOWN.

IF. DURING CONSTRUCTION, IT BECOMES APPARENT THAT ADDITIONAL EROSION CONTROL MEASURES AR REQUIRED TO STOP ANY EROSION ON THE CONSTRUCTION SITE DUE TO ACTUAL SITE CONDITIONS, THE OWNER SHALL BE: REQUIRED TO INSTALL. THE AFECESARY EROSION PROTECTION AT INCEXPENSE TO TO

3. ALL MATERIALS AND METHODS OF CONSTRUCTION SHALL CONFORM TO TOWN REGULATIONS AND THE LATEST EDITION OF THE NEW HAMPSHIRE DEPARTMENT OF TRANSPORTATION'S STANDARD SPECIFICATIONS FOR ROAD AND BRIDGE CONSTRUCTION.

4. IN ACCORDANCE WITH TOWN REGULATIONS AND RSA 676:13, ALL IMPROVEMENTS SPECIFIED ON THESE SITE PLANS SHALL BE CONSTRUCTED, COMPLETED, INSPECTED AND APPROVED BY THE TOWN OF BARRINGTON PRIOR TO THE ISSUANCE OF A CERTIFICATE OF OCCUPANCY.

IN ACCORDANCE WITH BARRINGTON SITE PLAN REVIEW REGULATIONS AND RSA 676:12, ALL OFF-SITE IMPROVEMENTS SPECIFIED ON THESE SITE PLANS SHALL BE CONSTRUCTED, COMPLETED, INSPECIFIED AN APPROVED BY THE TOWN OF BARRINGTON (AND/OR THE NHDOT, IF APPLICABLE) PRIOR OF A CERTIFICATE OF OCCUPANCY.

A WAIVER TO SECTION 4.8.2.3 DRIVEWAYS OF THE SITE PLAN REGULATIONS HAS BEEN GRANTED TO THIS PROJECT TO ALLOW THE CONSTRUCTION OF A ONE-WAY ENTRANCE DRIVEWAY WITHIN 150' OF THE DRIVEWAY ACCESS TO BARRINGTON TAX MAP 238 / LOT 5.

COVER SHEET TROPIC STAR CONVENIENCE CALEF HIGHWAY (RTE. 125), BARRINGTON, NH THE THREE SOCIOS, LLC 321D LAFAYETTE ROAD, HAMPTON, NH 03842

DRAWING No.



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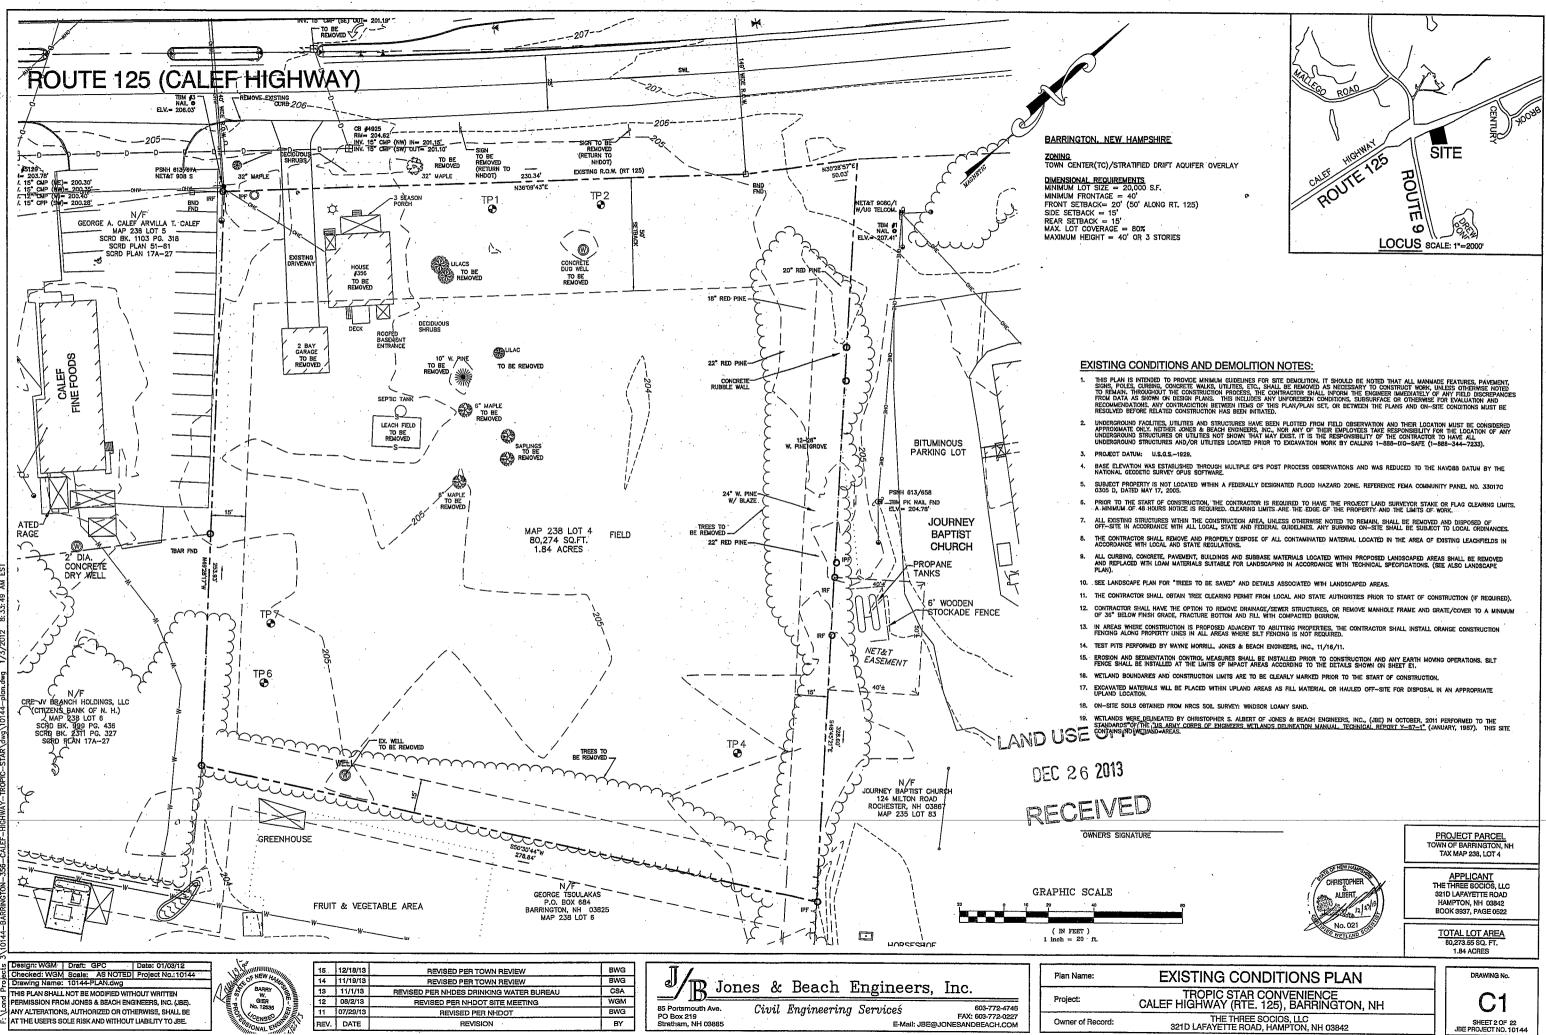
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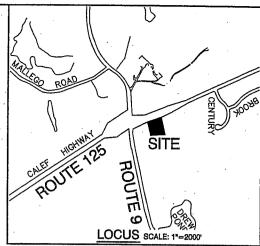
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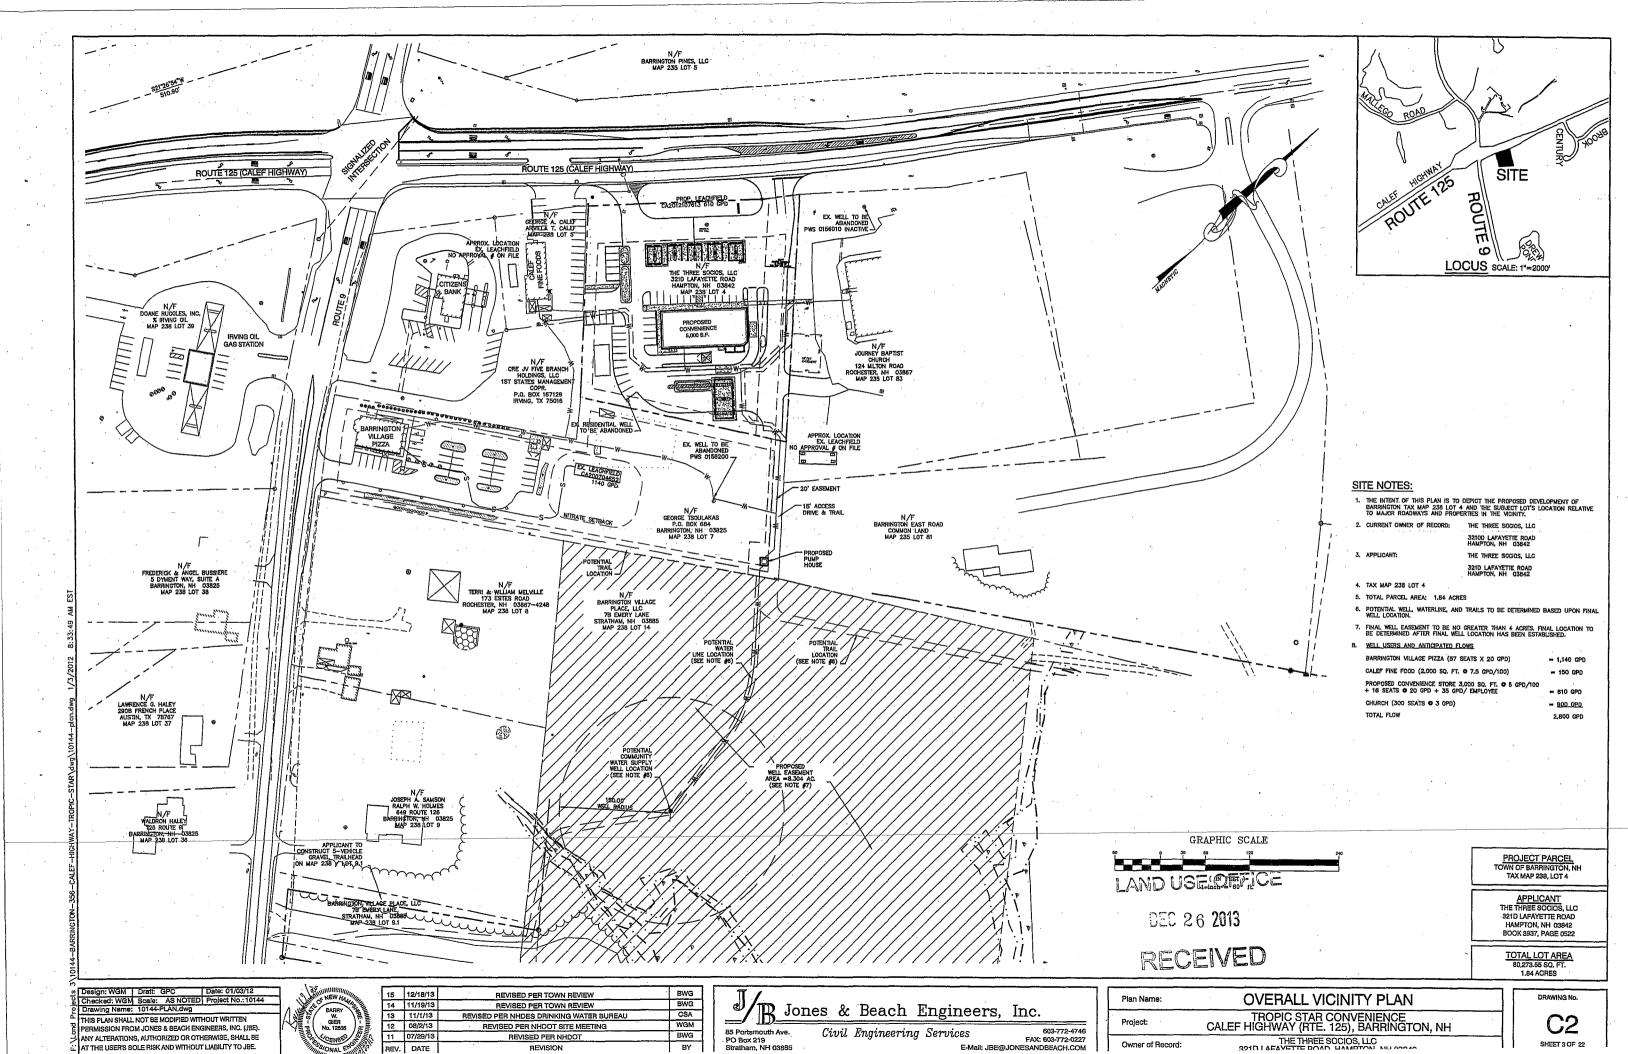
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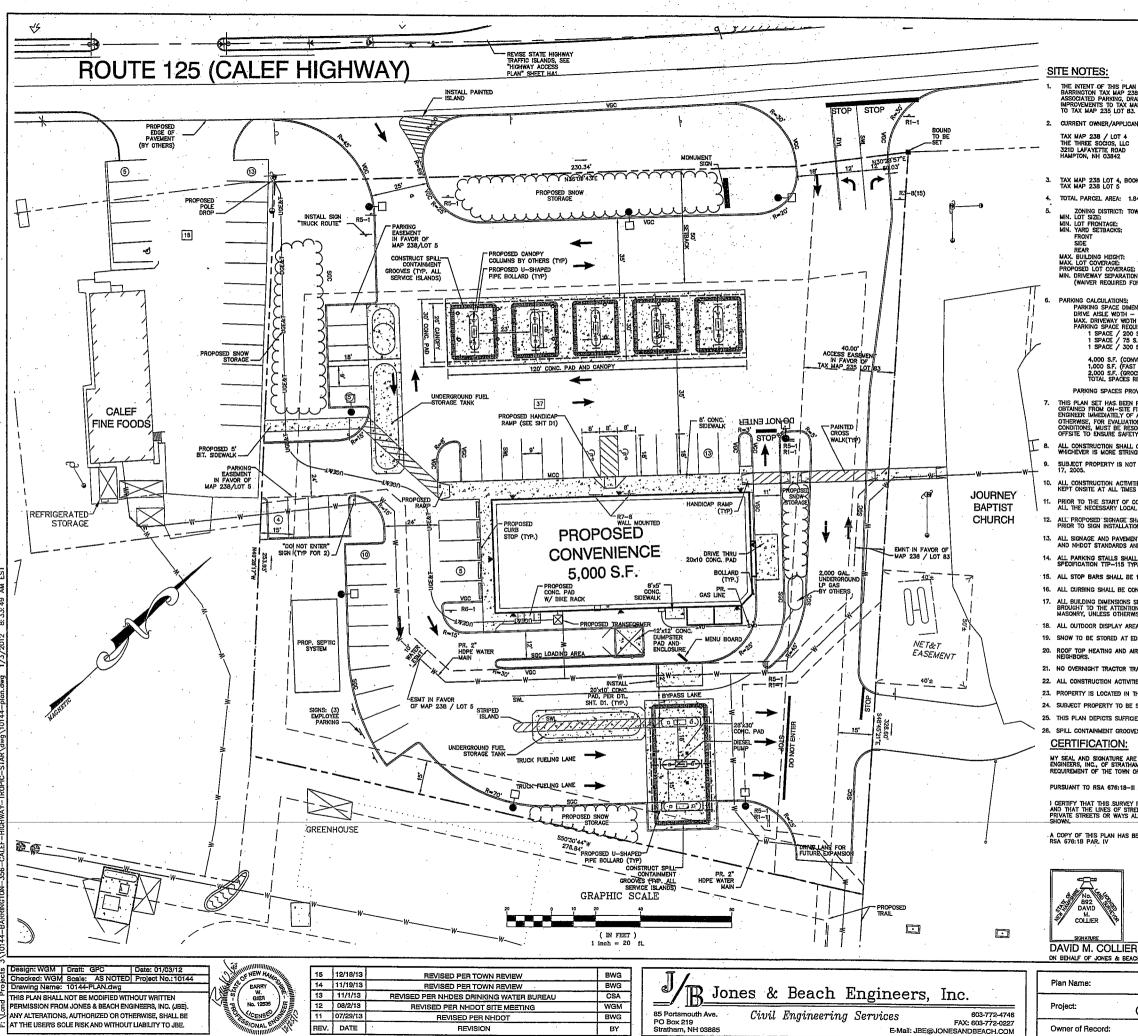
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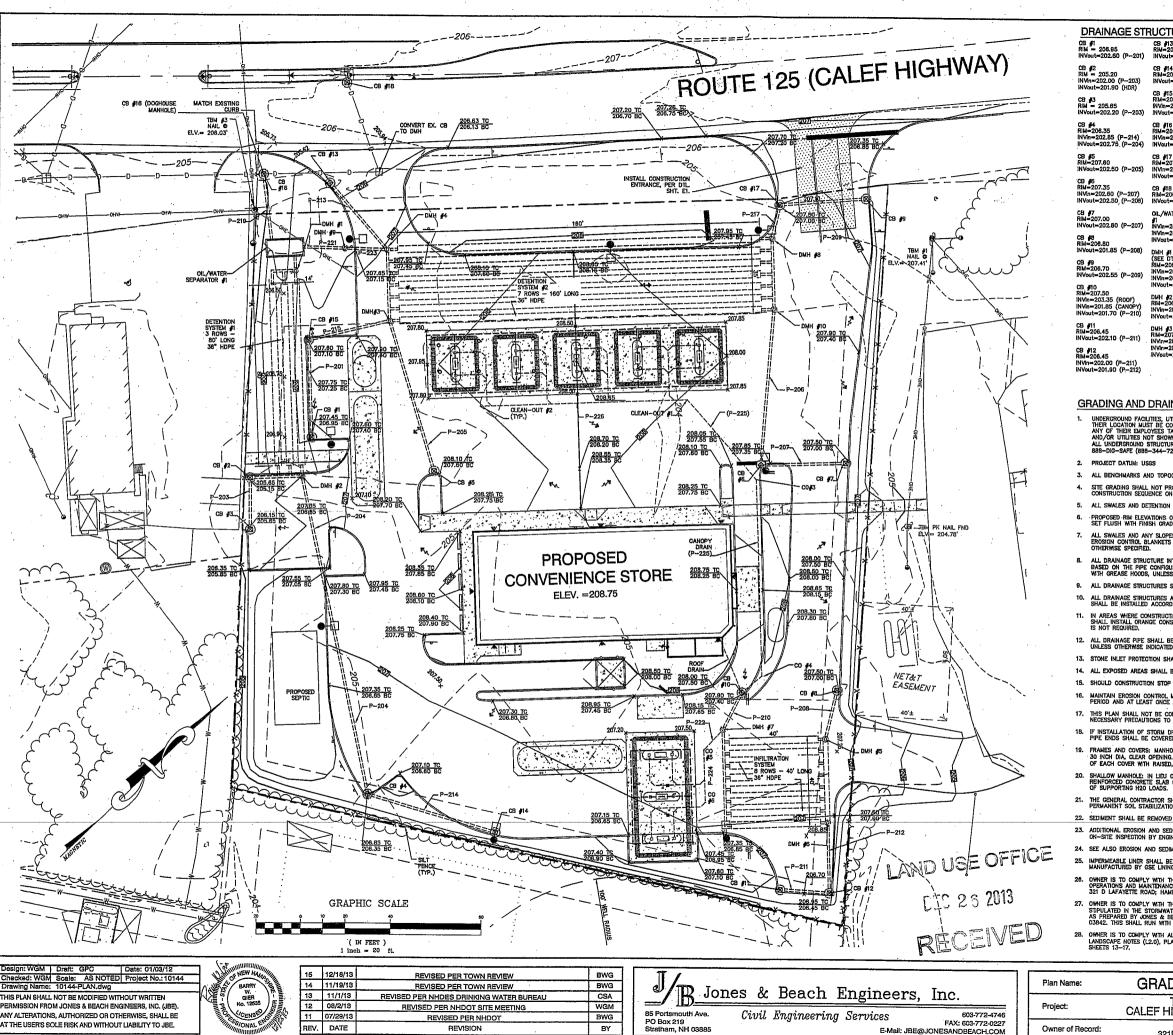








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AN IS TO DEPICT THE PROPOSED DEVELOPMENT OF 238 LOT 4 WITH A 5,000 SQ.FT, CONVENIENCE STORE, NAP 238 LOT 5 PARKING, AND DRIVE INTERCONNECTION 3. CANT OF RECORD: TAX MAP 238 / LOT 5 CALEF, GEORGE & ARVILLA (2) 1/2 INT IS MALLEGO GEOLOMIG TRUST BARRINGTON, NH 03825 COK 3937 PAGE 0522 1.84 AGRES TOWN CENTER (TC) 20,000 40' 50' (RT 125) 16' 16' 16' 16'	ARRA ROAD ARRA ROAD
52: 75.0% 10N: 75' For Existing Driveway Locations)	
$\begin{array}{l} \text{MENSIONS} = 9^{\circ}\text{X1B}^{\circ} \\ = 24^{\circ} \\ \text{ITH} = 30^{\circ} \\ \text{OUIREMENTS:} \\ \text{INO S.F. CONVENIENCE (LOT 4).} \\ \text{IS S.F. FAST FOOD (LOT 4)} \\ \text{IS S.F. RATE FOOD (LOT 4)} \\ \text{INO S.F. RATERY (LOT 5)} \\ \text{MVENIENCE) / 200 = 20 \\ \text{SPACES REQUIRED (LOT 4)} \\ \text{INOCRNY / 300 = 7 SPACES (LOT 5)} \\ \text{INCURED = 40 \\ \text{SPACES (LOT 5)} \\ \end{array}$	OWNERS SIGNATURE - MAP 238 / LOT 4
ROWDED = 55 IN PREPARED BY JONES & BEACH ENGINEERS, INC., FOR. FIELD SURVEY AND EXISTING MUNICIPAL RECORDS. THR F ANY FIELD DISCREPANCY FROM DATA AS SHOWN ON IT TION AND RECOMMENDATIONS. ANY CONTRALICION BETS USED BEFORE RELATED CONSTRUCTION HAS BEEN INIT ETY AND GEFY THE LAW.	MUNICIPAL AND STATE APPROVALS AND FOR CONSTRUCTION BASED ON DATA OUGHOUT THE CONSTRUCTION PROCESS, THE CONTRACTOR SHALL INFORM THE HE DESIGN PLANS, INCLUDING ANY UNFORESEN CONDITIONS, SUBSURFACE OR MEDI TENS ON THIS PLAN/PLAN SET, OR BETWEEN THE PLANS AND ON-SITE ATED. CONTRACTOR TO ALWAYS CONTACT DIG SAFE PRIOR TO DIGGING ONSITE OR
	nd NHDOT Standard specifications for road and Bridge construction, NZARD ZONE. Reference fema community panel No. 33017C 0305 D, dated May
SHALL CONFORM WITH THE TOWN ZONING REGULATIONS, I TION. NENT MARKINGS SHALL BE IN ACCORDANCE WITH THE LAT AND SPECIFICATIONS (NON-REFLECTORIZED PAYEMENT MA ALL BE SEPARATED USING 4" WIDE SOLID STRIPES. STRI TYPE 1, IN A COLOR OF WHITE. IE 18" IN WOTH IN A COLOR OF WHITE. ALL TRAFFIC ARP CONSTRUCTED WITH A MINIMUM RADIUS OF 2', UNLESS OT S SHALL BE VERIFIED WITH THE ARCHITECTURAL AND STR ION OF THE ENGINEER AND OWNER PRIOR TO THE START WASE NOTED. REAS SHALL BE WERIFIED WITH THE ARCHITECTURAL AND STR EDGE OF PAVEMENT AND IN A NEAT AND ORDERLY F/ EDGE OF PAVEMENT AND IN A NEAT SHOWN ON THE PLAY AIR CONDITIONING UNITS (RTU'S) SHALL BE DESIGNED TO TRALLER PARKING SHALL BE ALLOWED ON THE PREMISES. ITRES SHALL BCOFORM TO LABOR DOCUPATIONAL SAFTY I THE STRATIFIED DRIFT AQUIFER OVERLAY DISTRICT AND E SERVICED BY ON-SITE SEPTIC AND COMMUNITY WELL ICIENT CUEING (AT ORDERING BOARD) FOR TEN (10) VEHI VVES SHALL BE SIZED TO CONTAIN FIVE (5) GALLONS MIN	PING SHALL HAVE TWO COATS OF PAINT, ALKYD BASIN SYNTHETIC RESIN, FEDERAL ROWS SHALL BE PAINTED IN A COLOR OF WHITE. THERWISE NOTED. UIDTURAL PLANS PROVIDED BY THE OWNER, ANY DISCREPANCIES SHOULD BE I OF CONSTRUCTION. BUILDING DIMENSIONS AND AREAS TO BE TO OUTSIDE OF ASHION. NS, OR TRUCKED OFFSITE TO AN APPROVED SNOW DUMPING LOCATION. VENT UPWARDS AND AIR INTAKES SHALL BE DIRECTED AWAY FROM ABUTTING . NO TRUCK HORN BLOWING SHALL BE ALLOWED ON THE PREMISES. 'AND HEALTH ADMINISTRATION (OSHA) RULES AND REGULATIONS. STORAGE TANKS MUST COMPLY WITH THE TOWNS ZONING ORDINANCE. ICLES, FROM ORDERING BOARD TO DRIVE ALONG FRONT OF BUILDING. HIMUM PER DISPENSER, PER NHDES ADMINISTRATIVE RULE ENV-WM 1401.28V.
RE AFFIXED TO THIS PLAT ON THE BEHALF OF JONES & HAM, NH, FOR THE SOLE PURPOSE OF SATISTYING THE I OF BARRINGTON'S RECORDATION OF APPROVED SITE PL/ HII AND RSA 672:14	BEACH ANS.
Y PLAT IS NOT A SUBDIVISION PURSUANT TO THIS TITLE REETS AND WAYS SHOWN ARE THOSE OF PUBLIC OR ALREADY ESTABLISHED AND THAT NO NEW WAYS ARE	
been filed with the town of barrington planning LAND USE OFF	BOARD PLANNING BOARD
DEC 26 2013 RECEIVE	D
SITE PLAN	DRAWING No.
TROPIC STAR CONVE CALEF HIGHWAY (RTE. 125), I THE THREE SOCIOS, 321D LAFAYETTE ROAD, HAMP	ENIENCE BARRINGTON, NH C3



DRAINAGE STRUCTURES: CB #13 RIM=205.50 INVout=202.35 (P-213) CB #14 RIM=206.25 INVout=203.15 (P-214) CB #15 RIM=207.10 INVin=202.55 (P-201) INVout=202.45 (P-215)

CB #16 RiM=205.40 INVin=200.85 (P-216) ""Vout=200.85 (EX. 15")

CB #17 RIM=207.00 INVin=202.35 (I INVout=202.25

CB #18 RIM=205.15 "Wout=201.90 (EX. 15") OL/WATER SEPARATOR /1 NVin=201.25 (P−220) NVin=201.25 (P−221) NVout=201.00 (P−219)

DMH #1 (SEE DTL. SHT. D2) ME=206.75 NVin=201.90 (HDR) NVin=201.40 (UNDER)

DMH #2 RIM=206.00 INVin=202.00 (P--204) INVout=201.90 (HDR)

DMH **#3** RIM≈207.60 INVIn=202.15 (P-205 INVIn=202.15 (P-215) INVout=202.05 (HDR)

DMH #4 RIM=207.05 INVIn=202.15 INVIn=202.05 INVIn=201.55 (P-213) (HDR) (UNDER) 5 (P-223) NVout=201.45 DMH #5 RIM=207.15 INVin=201.60 (P--208) INVout=201.50 (HDR)

DMH #6 RIM=208.95 INVin=201.60 (P-212) INVout=201.50 (HDR)

DMH #7 RIM=207.40 iNVin=201.60 (P-217) INVout=201.50 (HDR)

DMH #8 RIM=207.30 INVin=202.15 INVout=202.0

DMH #9 (SEE DTL_SHT. D2) RIM=207.85 INVIn=201.35 (P-223) INVout=201.35 (P-221)

DMH #10 RIM=207.60 INVin=202.15 (P-206)

P-201 43' - 15" HDPE S=0.005 FT/FT P-203 23' - 15" HDPE S=0.005 FT/FT

P-204 144' - 15° HDPE S≈0.005 FT/FT

P-205 69' -- 15" HDPE S=0.005 FT/FT

P-206 69' - 15" HDPE S=0.005 FT/FT

P-207 38' - 15" HDPE S=0.005 FT/FT

P-208 22' - 15" HDPE S=0.010 FT/FT

P-209 38' - 15" HDPE S=0.005 FT/FT

P-210 18' - 15" HDPE S-0.005 FT/FT P-211 22' - 15" HDPE S=0.005 FT/FT

P-212 31' - 15" HDPE S=0.010 FT/FT

P-213 39' - 15" HDPE S≈0.005 FT/FT

P-214 59' - 15" HDPE S=0.005 FT/FT

P-215 37' - 15" HDPE S=0.008 FT/FT P-217 15' - 15" HDPE S=0.005 FT/FT

P-219 30' - 15" HDPE S=0.005 FT/FT

P-220 7 - 15" HDPE S=0.005 FT/FT

P-221 19' - 15" HDPE S=0.010 FT/FT

P-222 (CANOPY 12' - 8" HDPE S-0.010 FT/FT

P-223 19' - 15" HDPE S=0.005 FT/FT

P-224 (CANOPY 23' - 8" HDPE S=0.010 FT/FT

P--225 (CANOPY) 156' - 8" HDPE S=0.008 FT/FT

P-226 (CANOP) 92" - 8" HDPE S=0.010 FT/FT

Roof Drain 35' 8" Hdpe S=0.010 FT/FT
co #1 INV=203.10 (P-225) INV=203.10 (P-226)
CO #2 INV≈204.00 (P-226)
CO #3 INV=202.73 (P-225)
CO #4 INV=202.04 (P-225)
CO #5 INV=202.30 (P-222)
CO #6 INV=202.55 (P-224)

GRADING AND DRAINAGE NOTES:

UNDERGROUND FACILITIES, UTILITIES AND STRUCTURES HAVE BEEN PLOTTED FROM FIELD OBSERV THER LOCATION MUST BE CONSIDERED APPROXIMATE ONLY. NETHER JONES & BEACH ENGINEER AN' OF THEM BRICYDES THACE RESPONSIBILITY FOR THE LOCATION OF ANY UNDERGROUND ST ALL UNDERGROUND SHOWN THAT MAY EXIST. IT IS THE RESPONSIBILITY OF THE CONTRACTOR BRE-DIM-SHE (BBB-LUCL-TST) MAO/GN UTILITIES LOCATED PRIOR TO EXCAVATION WORK BY C

ALL BENCHMARKS AND TOPOGRAPHY SHOULD BE FIELD VERIFIED BY THE CONTRACTOR

SITE GRADING SHALL NOT PROCEED UNTIL EROSION CONTROL MEASURES HAVE CONSTRUCTION SEQUENCE ON SHEET ET.

5. ALL SWALES AND DETENTION PONDS ARE TO BE STABILIZED PROPOSED RIM ELEVATIONS OF DRAINAGE STRUCTURES ARE APPROXIMATE. FINAL ELEVATIONS ARE TO BI

l swales and any slopes greater than 3:1 shall be stabilized with north American green 575 Nosion control blankets (or an equivalent approved in writing by the engineer), unless

ALL DRAINAGE STRUCTURE INTERIOR DIAMETERS (4' MIN) SHALL BE DETERMINED BY THE MANUFACTUR BASED ON THE PIPE CONFIGURATIONS SHOWN ON THESE PLANS. CATCH BASINS SHALL HAVE 3' DEEP WITH GREASE HOODS, JULESE OTHERWISE NOTED.

9. ALL DRAINAGE STRUCTURES SHALL BE PRECAST, UNLESS OTHERWISE SPECIFIED

ALL DRAINAGE STRUCTURES AND STORM SEWER PIPES SHALL MEET HEAVY DUTY TRAFFIC H20 LOADING AND SHALL BE INSTALLED ACCORDINGLY.

IN AREAS WHERE CONSTRUCTION IS PROPOSED ADJACENT TO ABUTTING PROF SHALL INSTALL CRANGE CONSTRUCTION FENCING ALONG PROPERTY LINES IN IS NOT RECINED

ORATED REINFORCED CONCRETE PIPE (RCP) OR APPROVED FOLIAL STONE INLET PROTECTION SHALL BE PLACED AT ALL CATCH BASINS, SEE DETAIL

ALL EXPOSED AREAS SHALL BE SEEDED AS SPECIFIED WITHIN 3 DAYS OF FINAL GRADING

SHOULD CONSTRUCTION STOP FOR LONGER THAN 3 DAYS, THE SITE SHALL BE SEEDED AS SPECI

16. MAINTAIN EROSION CONTROL MEASURES AFTER EACH RAIN EVENT OF 0.5" OR GREATER IN A 24 HOUR PERIOD AND AT LEAST ONCE A WEEK. 17. THIS PLAN SHALL NOT BE CONSIDERED ALL INCLUSIVE, AS THE GENERAL CONTRACTOR S NECESSARY PRECAUTIONS TO PREVENT. SEDIMENT FROM LEAVING THE SITE.

IF INSTALLATION OF STORM DRAINAGE SYSTEM SHOULD BE INTERRUPTED BY WEATHER OR NIGHTFALL, THI PIPE ENDS SHALL BE COVERED WITH FILTER FABRIC.

Ames and covers: Manhole Frames and covers shall be of heavy duty design and provide Inch dia, Glear Opening. The word "Drain" shall be cast into the center of the upper fa Each cover with raised, 3' letters.

SHALLOW MANHOLE: IN LIEU OF A CONE SECTION, WHEN MANHOLE DEPTH IS LESS THAN 6 FEET, REINFORCED CONCRETE SLAB COVER MAY BE USED HAVING AN ECCENTRIC ENTRANCE OFENING A OF SUPPORTING HZO LOADS.

21. THE GENERAL CONTRACTOR SHALL BE RESPONSIBLE TO TAKE WHATEVER MEAN: PERMANENT SOIL STABILIZATION.

22. SEDIMENT SHALL BE REMOVED FROM ALL SEDIMENT BASINS BEFORE THEY ARE 25% FULL ADDITIONAL EROSION AND SEDIMENT CONTROL MEASURES SHALL BE INSTALLED, IF DEEMED NECESSARY BY ON-SITE INSPECTION BY ENGINEER AND/OR REGULATORY OFFICIALS.

24. SEE ALSO EROSION AND SEDIMENT CONTROL SPECIFICATIONS ON SHEET E1.

IMPERMEABLE LINER SHALL BE 30 MIL THICK HDPE GSE HD SMOOTH GEOME MANUFACTURED BY GSE LINING TECHNOLOGIES, LLC. OR APPROVED EQUAL

26. OWNER IS TO COMPLY WITH THE STIPULATIONS OF THE STORWHATER MANAGEMENT OPERATIONS AND MANTENANCE MANUAL AS PREPARED BY JONES & BEACH, ING. 3210 LAFATETE ROAD, HAMPTON, NH 03842 THIS SHALL RUN WITH THE LAND.

27. OWNER IS TO COMPLY WITH THE LANDSCAPE, AS WELL AS DRAINAGE SCHEDULE MAINTENANCE, STIPULATED IN THE STORWATER MANAGEMENT/SPILL PREVENTION OPERATIONS AND MAINTENAN AS PREPARED BY JONES & BEACH, INC., FOR THE THREE SOCIOS, 321 D LAFAYETTE ROAD; HA 03842, THIS SHALL RUN WITH THE LAND.

OWNER IS TO COMPLY WITH ALL NOTES AND SPECIFICATIONS AS SHOWN ON PLAN SHEETS TITLED: LANDSCAPE NOTES (12.0), PLANS (L 3.0), DETAILS (L4.0 AND 4.1), AND SPECS (L5.0), AS SHOWN SHEETS 13-17.


GRADING AND DRAINAGE PLAN


TROPIC STAR CONVENIENCE CALEF HIGHWAY (RTE. 125), BARRINGTON, NH

THE THREE SOCIOS, LLC 321D LAFAYETTE ROAD, HAMPTON, NH 03842

DRAWING No



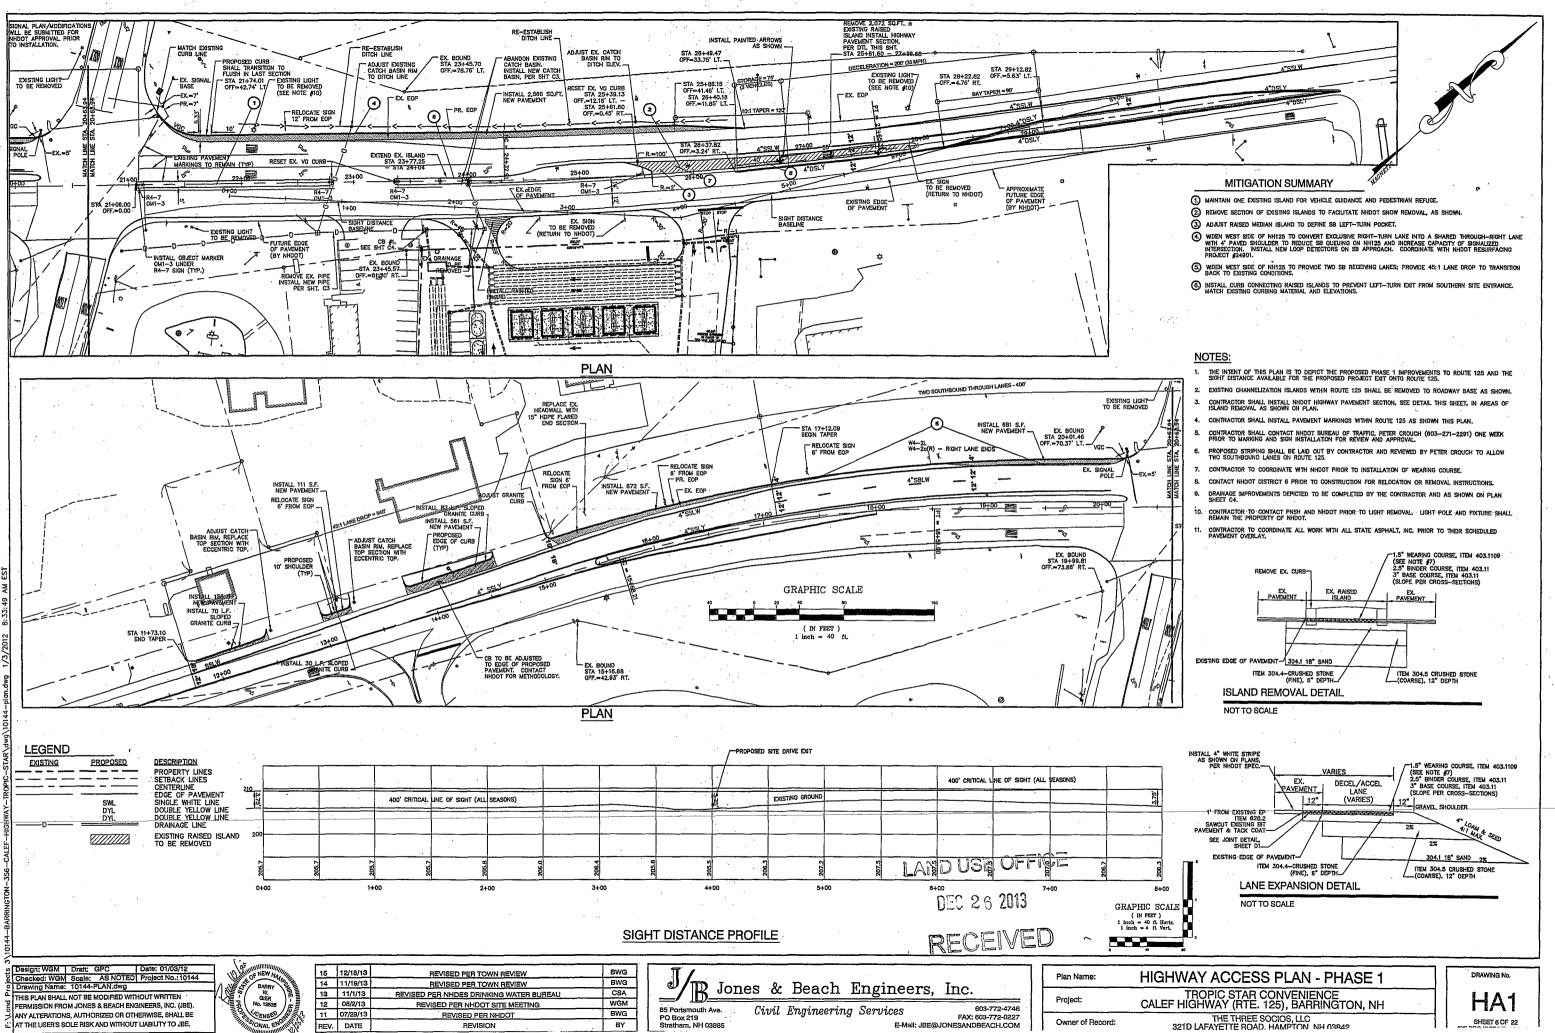

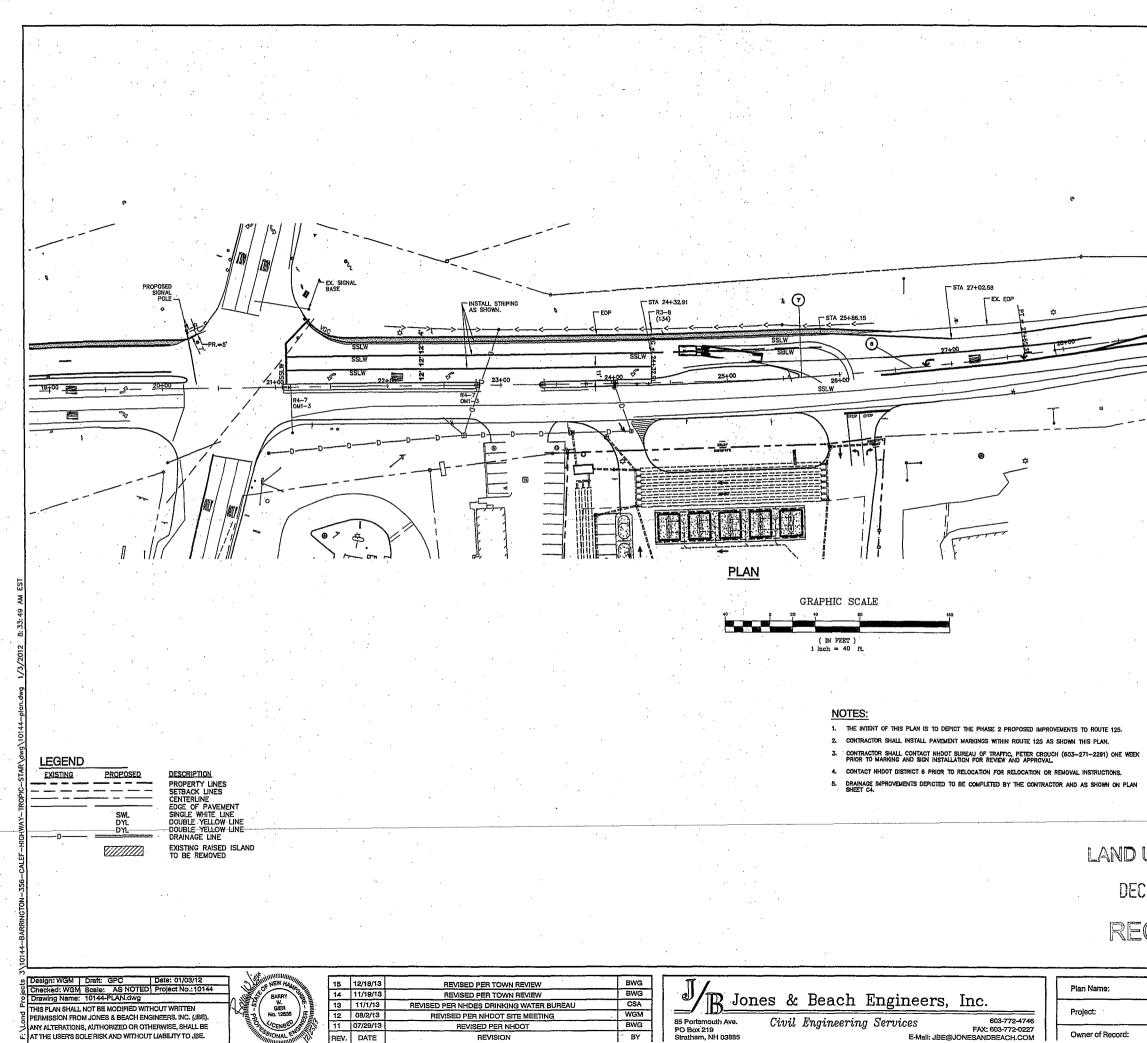


MITIGATION SUMMARY PROVIDE WIDENED CENTER LANE TO FACILITATE LEFT-TURN DEPARTURES FROM SITE DRIVEWAY (TWO-STAGE GAP-ACCEPTANCE PROCESS). 8. INSTALL EXCLUSIVE LEFT-TURN LANE ON NH125 FOR SB VEHICLES ENTERING SITE. LAND USE OFFICE

DEC 26 2013

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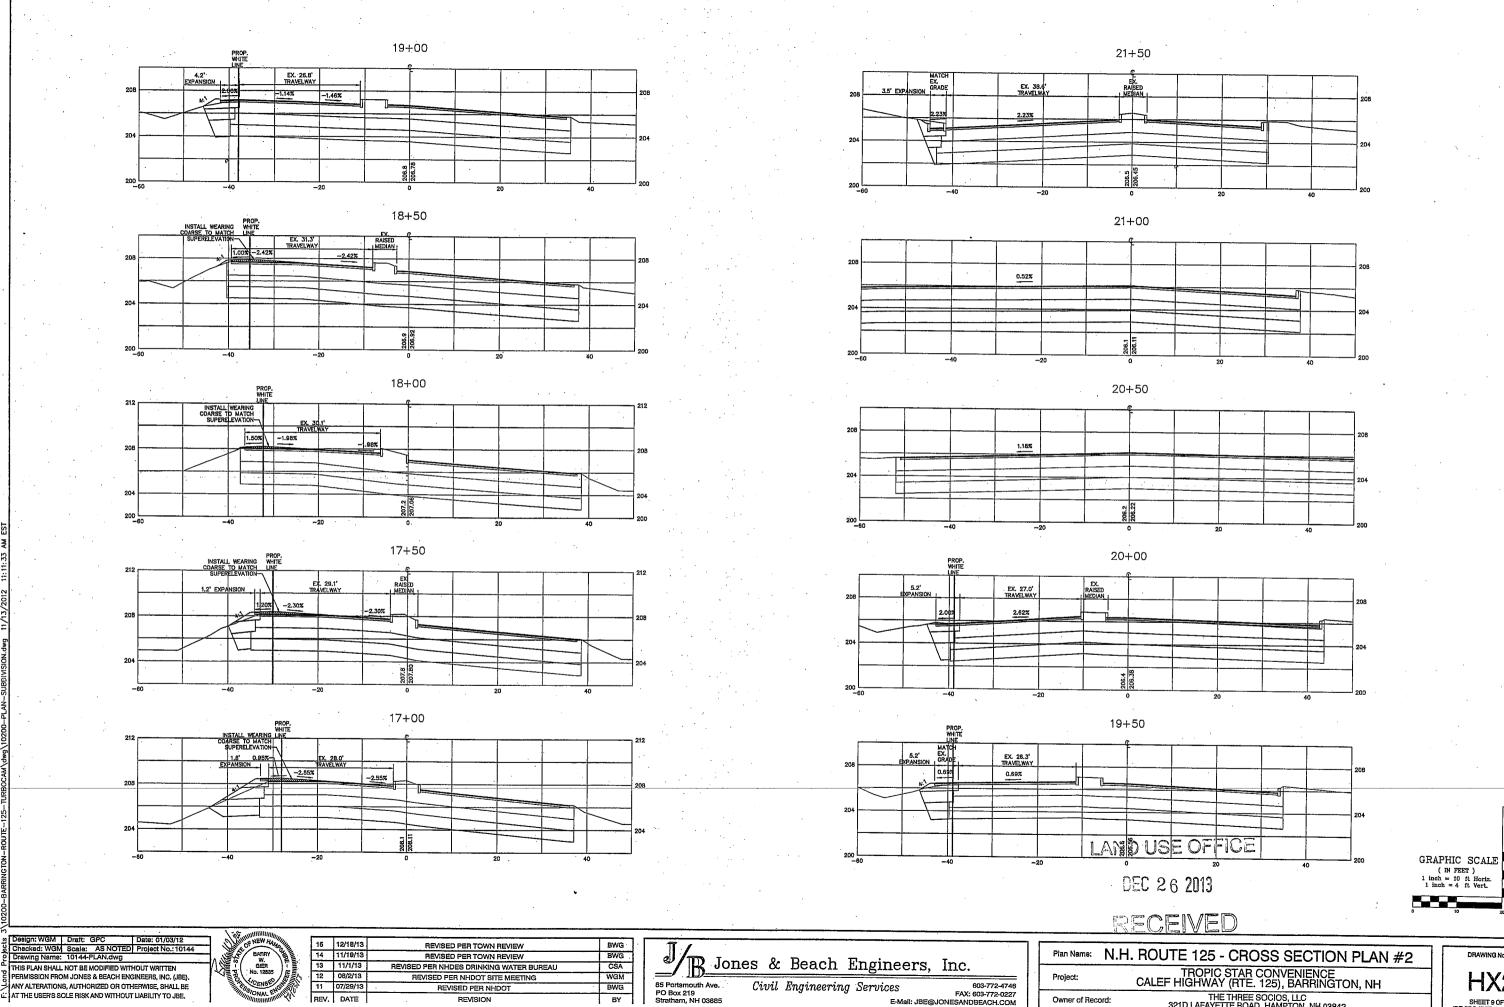
HIGHWAY ACCESS PLAN - PHASE 2 TROPIC STAR CONVENIENCE CALEF HIGHWAY (RTE. 125), BARRINGTON, NH DRAWING No.



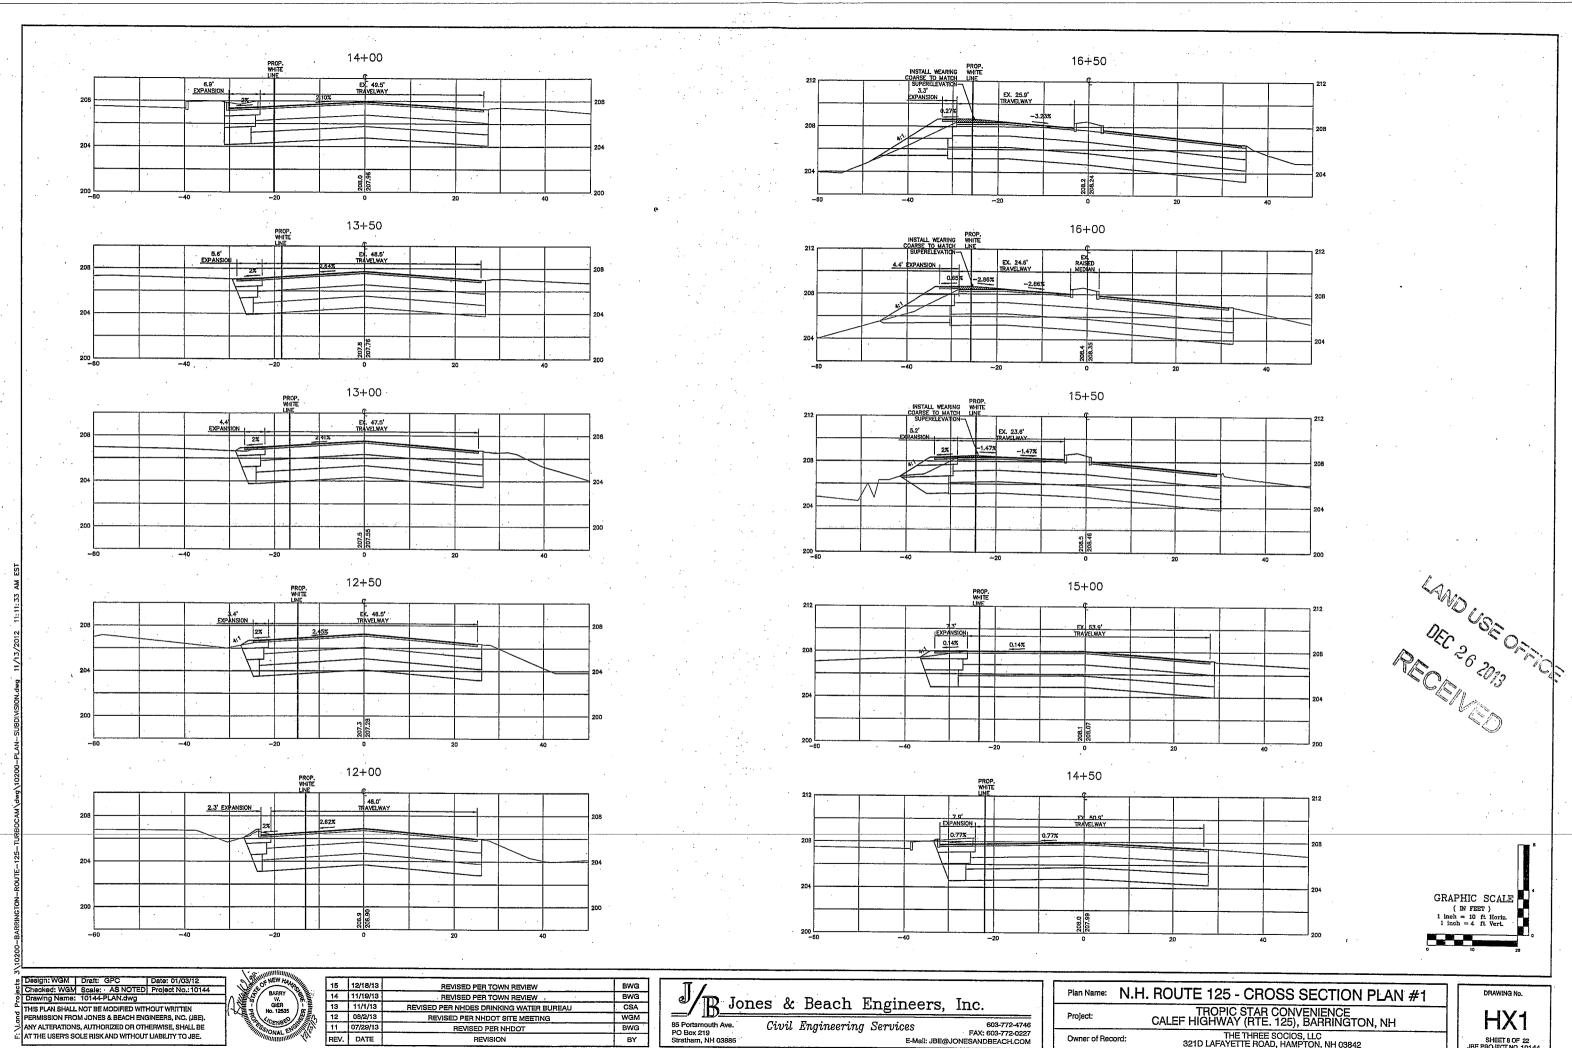


THE THREE SOCIOS, LLC 321D LAFAYETTE ROAD, HAMPTON, NH 03842


SHEET 8 OF 22 JBE PROJECT NO. 10144




DRAWING No. HX2

SHEET 9 OF 22

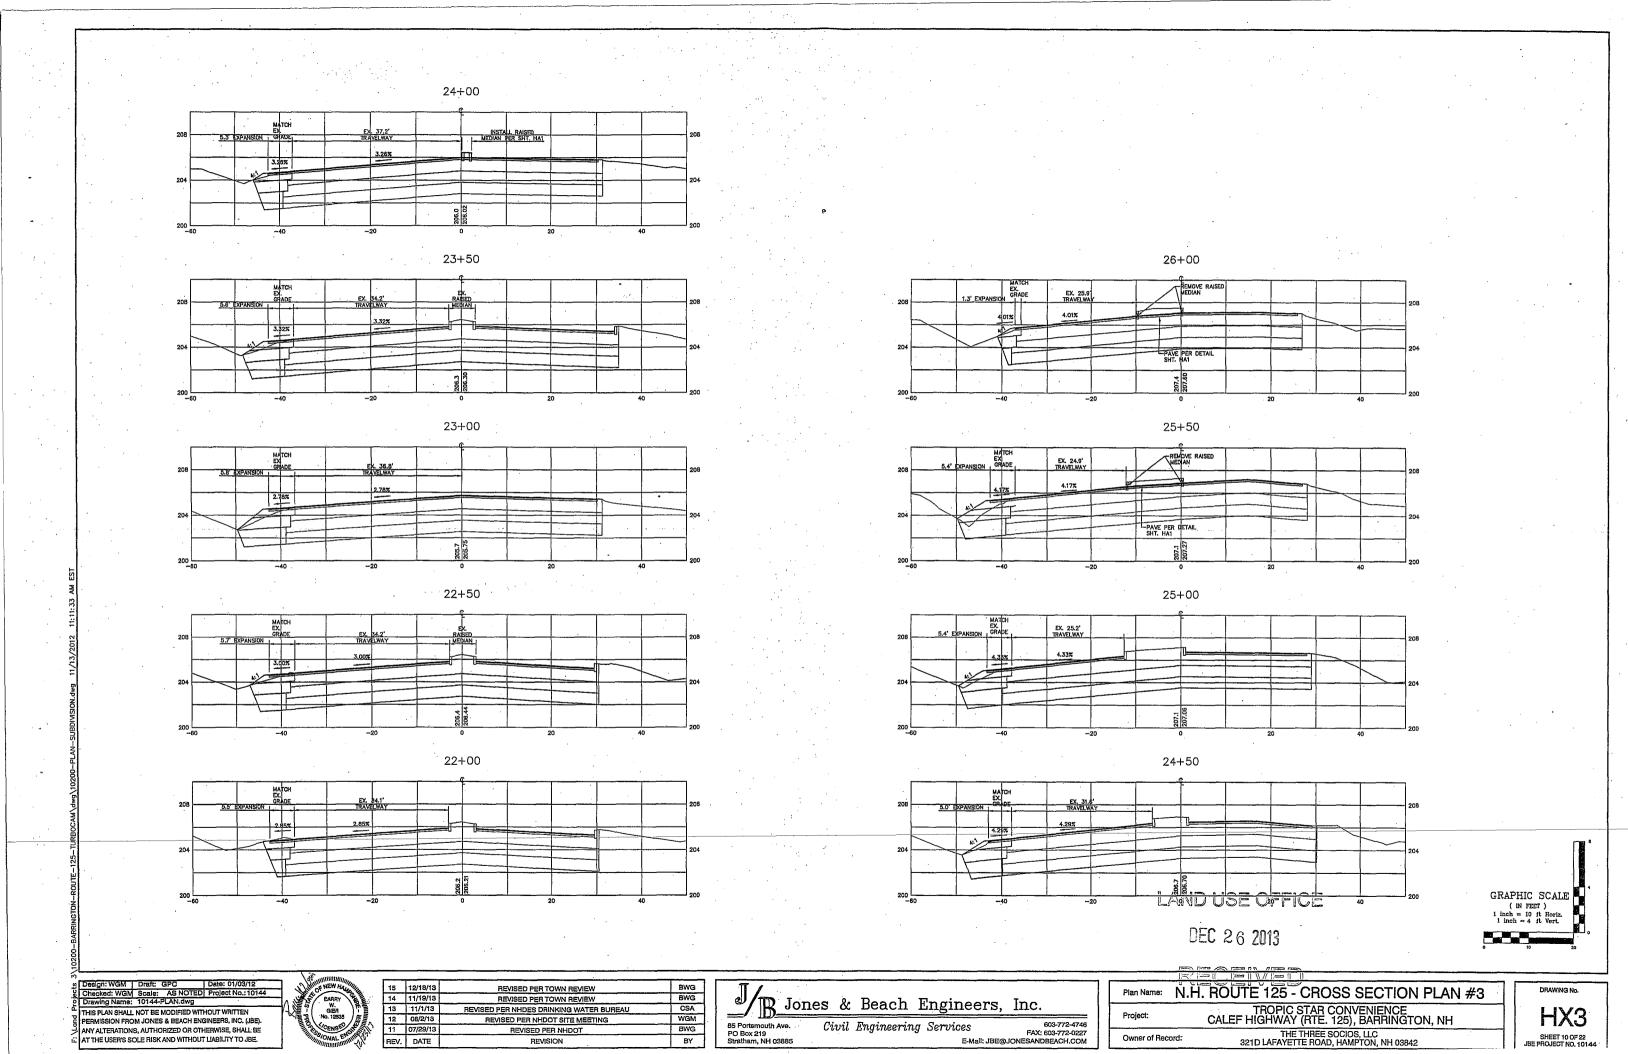

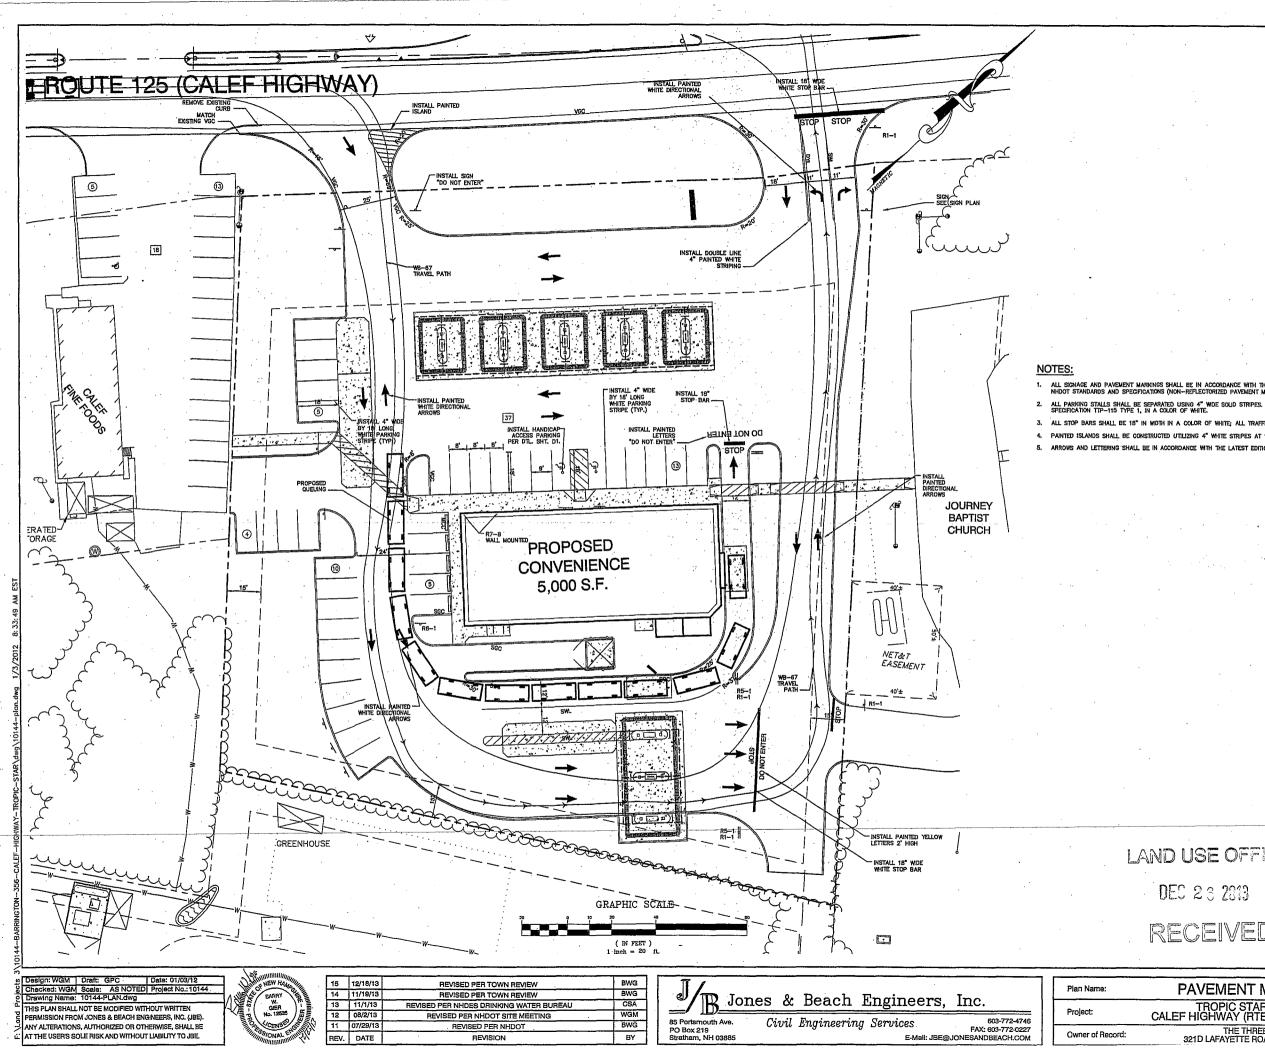

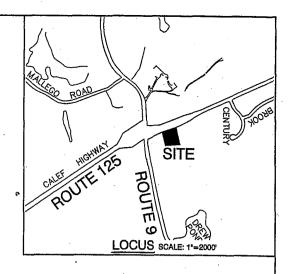


1. ALL SIGNAGE AND PAVEMENT MARKINGS SHALL BE IN ACCORDANCE WITH THE LATEST EDITION OF THE MANUAL ON UNIFORM TRAFFIC CONTROL DEVICES (M.U.T.C.D.) AND NHDOT STANDARDS AND SPECIFICATIONS (NON-REFLECTORIZED PAVEMENT MARKINGS), UNLESS OTHERWISE NOTED.

3. ALL STOP BARS SHALL BE 18" IN WIDTH IN A COLOR OF WHITE; ALL TRAFFIC ARROWS SHALL BE PAINTED IN A COLOR OF WHITE;

4. PAINTED ISLANDS SHALL BE CONSTRUCTED UTILIZING 4" WHITE STRIPES AT 1"-6" O.C. AT 45 DEGREES.

5. ARROWS AND LETTERING SHALL BE IN ACCORDANCE WITH THE LATEST EDITION OF THE STANDARD HIGHWAY SIGNS AND

AND USE OFFICE	PLANNING BOARD APPROVAL BLOCK	
DEC 23 2813	· .	
RECEIVED		
PAVEMENT MARKING PLAN	DRAWING No.	
TROPIC STAR CONVENIENCE CALEF HIGHWAY (RTE. 125), BARRINGTON, NH	M1	
THE THREE SOCIOS, LLC 321D LAFAYETTE ROAD, HAMPTON, NH 03842	SHEET 11 OF 22 JBE PROJECTING 10	

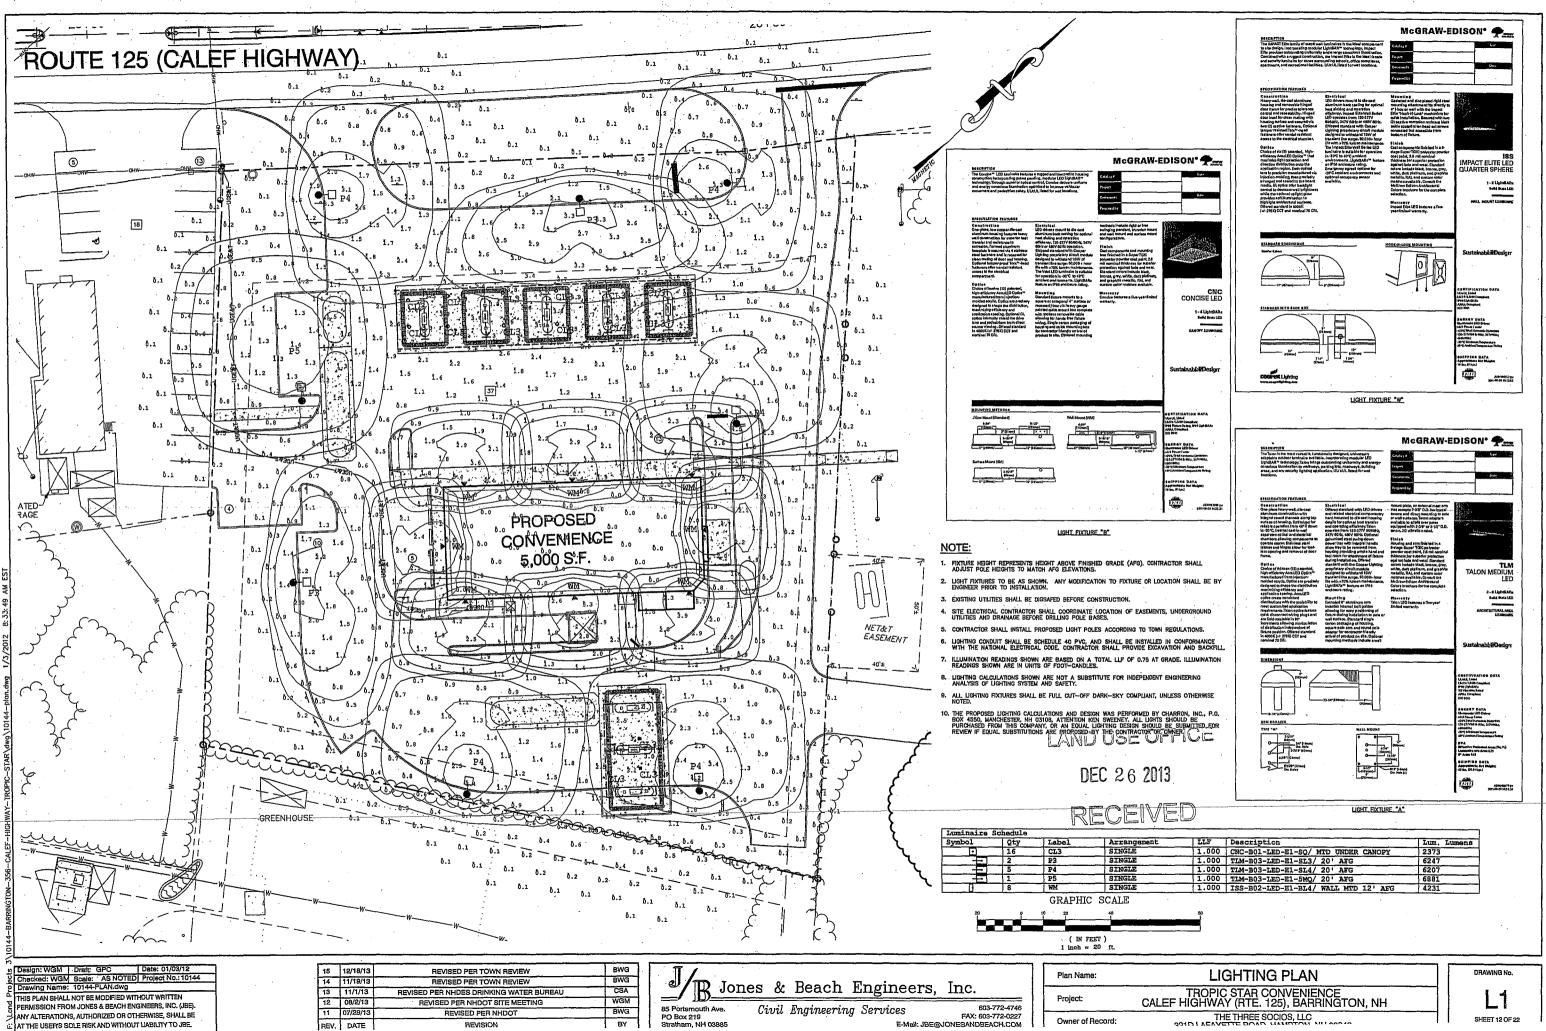

GENERAL PROJECT NOTES

- 1. ALL WORK SHALL BE DONE IN ACCORDANCE WITH THESE PLANS, DETAILS, AND SPECIFICATIONS, AND PER ALL APPLICABLE CODES AND REQUIREMENTS.
- 2. THE CONTRACTOR SHALL CAREFULLY INSPECT THE SITE AND VERIFY ALL CONDITIONS AND DIMENSIONS PRIOR TO PROCEEDING WITH ANY WORK DESCRIBED HEREIN. THE CONTRACTOR SHALL NOTIFY THE LANDSCAPE ARCHITECT OF ANY DISCREPANCIES WITH THESE DOCUMENTS PRIOR TO NNING ANY CONSTRUCTION.
- 3. THE CONTRACTOR SHALL CARRY ALL WORKER'S COMPENSATION, PUBLIC LIABILITY, AND PROPERTY DAMAGE INSURANCE AS REQUIRED BY THE OWNER.
- 4. HOLD HARMLESS AND INDEMNIFICATION CLAUSE THE CONTRACTOR SHALL AGREE THAT IN ACCORDANCE WITH GENERALLY ACCEPTED CONSTRUCTION AGREE THAT IN ACCORDANCE WITH GENERALLY ACCEPTED CONSTRUCTION PRACTICES, THE CONTRACTOR SHALL BE REQUIRED TO ASSUME SOLE AND COMPLETE RESPONSIBILITY FOR JOB SITE CONDITIONS DURING THE COURSE OF CONSTRUCTION OF THE PROJECT. INCLUDING SAFETY TO ALL PERSONS AND PROPERTY; THAT THIS REQUIREMENT SHALL BE MADE TO APPLY CONTINUOUSLY AND NOT BE LIMITED TO NORMAL WORKING HOURS; AND THAT THE CONTRACTOR SHALL DEFEND, INDEMNIFY, AND HOLD THE LANDSCAPE ARCHITECT HARMLESS STOLADAY AND ALL INDEMNIFY, AND HOLD THE LANDSCAPE ARCHITECT HARMLESS STACL DEPEND, INDEMNIFT, AND HOLD THE LANDSCAPE ARCHITECT HARMLESS FROM ANY AND ALL LIABILITY; REAL OR ALLEGED, IN CONNECTION WITH THE PERFORMANCE OF WORK ON THIS PROJECT, EXCEPTING FOR LIABILITY ARISING FROM THE SOLE NEGLIGENCE OF THE LANDSCAPE ARCHITECT.
- 5. DAMAGE RESPONSIBILITY CONTRACTOR SHALL ASSUME FULL RESPONSIBILITY FOR ANY DAMAGE IMPOSED, INTENTIONALLY OR ACCIDENTALLY, TO EXISTING UTILITIES, BUILDINGS, OR OTHER AMENITIES, DUE TO THE ACTIONS OF THE CONTRACTOR, CONTRACTOR'S EMPLOYEES; AND/OR CONTRACTOR'S SUB CONTRACTOR, CONTRACTOR'S EMPLOYEES; AND/OR CONTRACTOR'S SUB CONTRACTORS, CONTRACTOR SHALL AT ALL TIMES PROTECT HIS WORK FROM DAMAGE AND THEFT AND REPLACE ALL DAMAGE OR STOLEN PARTS AT HIS EXPENSE UNTIL THE WORK IS ACCEPTED IN WRITING FROM THE OWNER.
- 6. UNAUTHORIZED CHANGES TO PLANS THE LANDSCAPE ARCHITECT PREPARING THESE PLANS SHALL NOT BE RESPONSIBLE FOR, OR LIABLE FOR, UNAUTHORIZED CHANGES TO OR USES OF THESE PLANS. ALL CHANGES TO THE PLANS MUST BE IN WRITING AND MUST BE APPROVED BY THE LANDSCAPE ARCHITECT PRIOR TO THE COMMENCEMENT OF ANY WORK
- 7. REVISED LANDSCAPE PLANS MUST BE SUMBITTED FOR APPROVAL IF ANY REVISIONS ARE MADE TO THE DEVELOPMENT PLAN OR PLAT FOR PAVING, GRADING, OR IMPROVEMET PLANS.
- 8. THE CONTRACTOR SHALL APPLY, OBTAIN, AND PAY FOR ALL REQUIRED PERMITS TO COMPLETE THE SCOPE OF WORK
- 9. TRADE COORDINATION CONSTRUCTION AND INSTALLATION OF ALL ITEMS WITHIN THESE DOCUMENTS SHALL REQUIRE CLOSE COORDINATION BETWEEN TRADES INVOLVED IN UNDERGROUND AND UTILITY INSTALLATION, AND TREE LOCATION. CONTRACTOR SHALL BE: RESPONSIBLE TO INSURE PROPER COORDINATION BETWEEN TRADES TO INSURE AND AVOID CONSTRUCTION DELAYS OR DAMAGE TO ANY IMPROVEMENTS OR LITILITIES.
- 10. UNDERGROUND SERVICE ALERT CONTRACTOR SHALL NOTIFY DIG SAFE SYSTEM, INC. 72 HOURS PRIOR TO DIGGING AT 1-888-DIG-SAFE. THE CONTRACTOR SHALL EXERCISE EXTREME CARE IN WORKING NEAR-EXISTING UTILITIES. THE CONTRACTOR SHALL VERIFY THE LOCATION AND CONDITION OF ALL UTILITIES. PRIOR TO CONSTRUCTION.
- 11. INSPECTIONS THE CONTRACTOR SHALL BE RESPONSIBLE FOR NOTIFYING THE MUNICIPAL REPRESENTATIVE AT LEAST 48 HOURS IN ADVANCE PRIOR TO ANY REQUIRED MUNICIPAL INSPECTION.
- 12. THE CONTRACTOR SHALL NOTIFY THE LANDSCAPE ARCHITECT AT LEAST 48 HOURS IN ADVANCE PRIOR TO ANY REQUIRED OR DESIRED INSPECTION (602) 391-7715.
- 13. THESE DRAWINGS AND SPECIFICATIONS ARE PROPERTY AND COPYRIGHT OFHOWARD SNYDER. THESE DRAWINGS SHALL NOT TO BE USED ON ANY OTHER WORK EXCEPT BY WRITTEN AUTHORIZATION FROM HOWARD SNYDER.
- 14. WRITTEN DIMENSIONS TAKE PREFERENCE OVER SCALED DIMENSIONS AND SHALL BE VERIFIED ON THE JOB SITE, ANY DISCREPANCIES SHALL BE BROUGHT TO THE ATTENTION OF THE LANDSCAPE ARCHITECT PRIOR TO THE COMMENCEMENT OF
- 15. ALL QUANTITIES INDICATED ON THE PLANS ARE PROVIDED AS A COURTESY ONLY. CONTRACTOR SHALL BE RESPONSIBLE FOR VERIFYING THE QUANTITIES SHOWN BY CONDUCTING A INDEPENDENT QUANTITY TAKE OFF.
- 16. THE LANDSCAPE ARCHITECT SHALL DECIDE ALL QUESTIONS RELATING TO THE INTERPRETATION OF THE DRAWINGS AND THE ACCEPTABLE FULFILLMENT OF THE CONTRACT DOCUMENTS
- 17. THE CONTRACTOR SHALL MAINTAIN THE PREMISES CLEAN AND FREE OF EXCESS EQUIPMENT, MATERIALS, AND RUBBISH INCIDENTAL OF HIS WORK AT ALL TIMES INCLUDING WEEKENDS AND HOLIDAYS, ALL RUBBLE, TRASH, OR DISPOSABLE ITEMS RESULTING FOR THE DEMOLITION OF CONSTRUCTION SHALL BE DISPOSED OF IN A LEGAL, LAWFUL, AND SAFE MANNER TO AN APPROVED DISPOSAL SITE.
- 18. PLANT MATERIAL TO BE APPROVED BY THE LANDSCAPE ARCHITECT PRIOR TO INSTALLATION. ALL TREES SHALL HAVE A NUMBERED TAG.
- 19. ALL PLANT MATERIAL TO BE STAKED BY THE LANDSCAPE CONTRACTOR AND APPROVED BY THE LANDSCAPE ARCHITECT PRIOR TO ANY HOLES BEING DUG.
- 20. ALL GRADES TO BE APPROVED BY THE LANDSCAPE ARCHITECT PRIOR TO THE INSTALLATION OF ANY PLANT MATERIAL
- 21. LANDSCAPE CONTRACTOR SHALL BE RESPONSIBLE FOR PROVIDING ALL FINISHED GRADES
- 22. THE LANDSCAPE CONTRACTOR SHALL VERIFY BERM AND RETENTION BASIN LOCATIONS SHOWN ON THESE PLANS WITH THOSE ON THE CIVIL ENGINEERING PLANS. SHOULD A DISCREPANCY EXIST BETWEEN THE PLANS, THIS OFFICE SHALL BE NOTIFIED IMMEDIATELY.
- 23. ALL DECIDUOUS TREES TO BE UNCONDITIONALLY GUARANTEED FOR ONE YEAR AFTER INSTALLATION.
- 24. LANDSCAPE CONTRACTOR IS RESPONSIBLE FOR PROVIDING POSITIVE DRAINAGE AWAY FROM ALL BUILDINGS DURING THE FINISH GRADING PROCESS.
- 25. NO SLOPES TO EXCEED 4:1 IN LANDSCAPE AREAS.
- 26. UNDER NO CIRCUMSTANCES SHALL ANY TREE BE PLANTED WITHIN 6' OF ANY BUILDING WITHOUT THE EXPRESS WRITTEN APPROVAL OF THE LANDSCAPE ARCHITECT. TREES MUST BE LOCATED AT LEAST 7' FROM A SEVER LINE EASEMENT CENTERLINE, PLANT MATERIALS WITH INTRUSIVE ROOT SYSTEMS SHALL NOT BE PLACE WITHIN DRAINAGE BASINS WITH ENGINEERED BOTTOMS.

27. ALL PLANT MATERIAL WITHIN SIGHT VISIBILITY TRIANGLES SHALL BE PLACED SO AS NOT TO INTERFERE WITH A VISIBILITY PLANE DESCRIBED BY TWO HORIZONTAL LINES LOCATED 30 INCHES AND 72 INCHES ABOVE FINISHED GRADE OF THE

28. IT IS RESPONSIBILITY OF THE LANDSCAPE CONTRACTOR TO INFORM THE LANDSCAPE ARCHITECT/OWNER OF ANY PLANT MATERIAL CONCERNS BASED ON PLANTING SEASON (E.G. WINTER, SUMMER). SHOULD THE LANDSCAPE CONTRACTOR HAVE ANY CONCERNS ABOUT PLANT MATERIAL DUE TO HEAT/FROST OR EXPOSURE, HE SHALL REQUEST A SUBSTITUTION OR DELAY IN PLANTING. ONCE PLANTED, ALL PLANT MATERIAL IS SUBJECT TO SPECIFIED WARRANTIES.

	PLANT LEG	END	· .		LANDSCAPE NOTES
	EXISTING TREES	SIZE	NOTES	QTY.	1. AREAS OF ORGANIC MULCH WITHOUT SHALL NOT EXCEED DIMENSIONS OF M
ᡷᢆᡷᠫ	Decidious Tree to Remain Reference Civil Survey for Ad	Varies ditional Informati	ion	· · · · · · · · · · · · · · · · · · ·	MEASURED BETWEEN PLANT CANOPIE
. هما کم	DECIDIOUS TREES	•			2. A SINGLE TRUNK TREE'S CALIPER SIZE 4-INCHES, SHALL BE DETERMINED BY THE TRUNK 6-INCHES ABOVE FINISHED
$\sum_{i=1}^{n}$	Betula populifolia	SIZE 19" Ball	NOTES Multi-trunk		3. A TREES CALIPER SIZE, FOR SINGLE T
لم کما	Gray Birch Earth Ball Sizes: 15,19,23,27,;			2 5" 3" Cal	DIAMETER GREATER THAN 4-INCHES, S SMALLEST DIAMETER OF THE TRUNK 1
XX	Fraxinius pennsylvanica	23" Ball	npor 0120. 1 ; 110 ;2.	A	ADJACENT TO THE TRUNK.
Ψ	White Ash Earth Ball Sizes: 15,19,23,27,		liper Size: 1",1.5",2."	,2.5",3" Cal.	4. A MULTIPLE TRUNK TREE'S CALIPER S LOCATION THAT THE TRUNK SPLITS OF GRADE IF ALL TRUNKS ORIGINATE FRC
(+)	Liquidambar styraciflus	27" Ball		3	5. AREA WITHIN THE SIGHT DISTANCE TR
\bigcup	Sweetgum Earth Ball Sizes: 15,19,23,27,:	31 Ball Dia.= Ca	liper Size: 1",1.5",2."	.2.5".3" Cal.	SIGNS, OR OTHER VISIBILITY OBSTRUC FEET. TREES WITHIN THE SAFETY TRIA
ڊ • ^ک	Pyrus calleryana 'Bradford' Bradford Pear	23" Ball		3	BEGINS AT 7 FEET IN HEIGHT UPON INS FROM NEAREST STREET LINE ELEVATI
$\tilde{\mathcal{M}}$	Earth Ball Sizes: 15,19,23,27,	31 Ball Dia.≕ Cal	liper Size: 1",1.5",2."	,2.5",3" Cal.	6. RETENTION/DETENTION BASINS SHALL APPROVED CIVIL PLANS, ANY ALTERAT
(\cdot)	Quercus palustris Pin Oak	19" Ball	:	5	(ADDITIONAL FILL, BOULDERS, ECT.) SH STAFF REVIEW AND APPROVAL.
\smile	Earth Ball Sizes: 15,19,23,27,	31 Ball Dia.= Cal	liper Size: 1",1.5",2."	,2.5",3" Cal.	7. ALL RIGHTS-OF-WAY ADJACENT TO TH MAINTAINED BY THE PROPERTY OWNE
	CONIFER TREES	SIZE	NOTES	QTY	8. NO LIGHTING IS APPROVED WITH THE
2 . S	Thuja occidentalis 'Hoveyi'	15" Ball		10	9. NEW LANDSCAPING, INCLUDING SALVA
w	Eastern Arborvitae	31 Ball Dia.= Cal	lper Size: 1".1.5".2."	.2.5".3" Cal.	INDICATED TO REMAIN, WHICH IS DEST CONSTRUCTION SHALL BE REPLACED
	Juniperus virginiana	23' Bali	•	6	PRIOR TO THE ISSUANCE OF THE CERT ACCEPTANCE TO THE SATISFACTION C
Thurst	Eastern Redcedar Earth Ball Sizes: 15,19,23,27,3	31 Ball Dia.= Cal	iper Size: 1",1.5".2."	2.5".3" Cal.	
00000 A 3	Tsuga canadensis	23' Bali		7	· .
2000000	Eastern Hemlock Earth Ball Sizes: 15,19,23,27,3	31 Ball Dia.= Cal	iper Size: 1".1.5".2."	2.5".3" Cal.	
					•
	SHRUBS	SIZE	NOTES	QTY	
\odot	Buddleja davidil Butterfly Bush	1 Gallon		38	
\bigcirc	Cornus serica Red Osler Dogwood	1 Gallon		15	
(\triangle)	llex glabra	5 Gallon	· · ·	·.9.	
Ø	Vaccinium corymbosum	1 Gallon		31	•
\bigotimes	Vibumum opulus	1 Gallon		37	
9	Highbush Cranberry				
	GRASSES	SIZE	NOTES	QTY	
8	Helictotrichon sempervirens Blue Oat Grass	1 Gallon		56	
0	Miscanthus sinensis 'Huron Su Malden Grass Variety	nset 5 Gallon		28	•
**	Molinia caerulea 'Variegata' Striped Purple Moor Grass	1 Gailon		42	
-	Curber Fulble Moot Glass				· · · · ·
	GROUNDCOVERS	SIZE	NOTES	QTY	
B	Astilbe chinensis pumila False Goat's Beard	. 1 Galion	9"-12"	53	
	Penstemon newberryi Penstemon	1 Gallon	9"-12" ht.	56	
	Seasonal Annuals Annual flower varieties	Flats/Trays	Plant no more	235 sq. ft.	
12222223	Annual nower varieties		than 6" o.c.		•
	VINES	SIZE	NOTES	OTY	
~ x	VINES Clematis montana	SIZE 1 Gallon	NOTES	QTY 4	

	:		
	TURF AND SEED MIX		QT
	Kentucky Bluegrass Hydroseed		6,255 S.F.
	Wildflower Seed Mix Refer Detail13/Sheet L4.1 for Specification		5,135 S.F.
	LANDSCAPE MATERIALS		QT
ALT TO - DATE ON - 10	Bark Mulch Shreddied Hemlock Bark Mulch	4" depth all planting	14,456 S.F.

Landscape Border

Annodized steel header

LAND USE OFF DEC 26 2013 RECEIVED

968' LN. FT.

IK TREE'S CALIPER SIZE IS MEASURED AT 6" ABOVE THE THE TRUNK SPLITS ORIGINATES, OR 6" ABOVE THE FINISHED JNKS ORIGINATE FROM THE SOIL.

- D APPROVAL
- E PROPERTY OWNER.
 - PROVED WITH THE SUBMITTAL

NC MULCH WITHOUT PLANT MATERIALS/ GROUNDCOVERS ED DIMENSIONS OF MORE THAN 7 FEET IN ANY ONE DIRECTION, EEN PLANT CANOPIES AND/OR COVERAGE.

TREE'S CALIPER SIZE, THAT IS TO BE EQUAL TO OR LESS THAN BE DETERMINED BY UTILIZING THE SMALLEST DIAMERTER OF HES ABOVE FINISHED GRADE ADJACENT TO THE TRUNK.

SIZE, FOR SINGLE TRUNK TREES THAT ARE TO HAVE A ER THAN 4-INCHES, SHALL BE DETERMINED BY UTILIZING THE ER OF THE TRUNK 12 INCHES ABOVE FINISHED GRADE

SIGHT DISTANCE TRIANGLE IS TO BE CLEAR OF LANDSCAPING, VISIBILITY OBSTRUCTIONS WITH A HEIGHT GREATER THAN 2 IN THE SAFETY TRIANGLE SHALL HAVE A CANOPY THAT IN HEIGHT UPON INSTALLATION. ALL HEIGHTS ARE MEASURED TREET LINE ELEVATION.

NTION BASINS SHALL BE CONSTRUCTED SOLELY FROM THE PLANS. ANY ALTERATION OF THE APPROVED DESIGN BOULDERS, ECT.) SHALL REQUIRE ADDITIONAL FINAL PLANS

A ADJACENT TO THIS PROPERTY SHALL BE LANDSCAPED AND

, INCLUDING SALVAGED PLANT MATERIAL, AND LANDSCAPING AIN, WHICH IS DESTROYED, DAMAGED, OR EXPIRED DURING HALL BE REPLACED WITH LIKE SIZE, KIND, AND QUANTITY JANCE OF THE CERTIFICATE OF OCCUPANCY / LETTER OF HE SATISFACTION OF THE INSPECTION SERVICES STAFF.

AMORY LAND DESIGN, LLC. **26B STRONG STREET** NEWBURYPORT, MA 01950-2324

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CE.	APPROVED PLANNING BOARD	
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LANDSCAPE NOTES OWARI .2.0 28 CIE

TROPIC STAR CONVENIENCE


Coordination and Approva Howard Snyder

11-011.00


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DELTA ISSUE TITLE

22nd, 2013

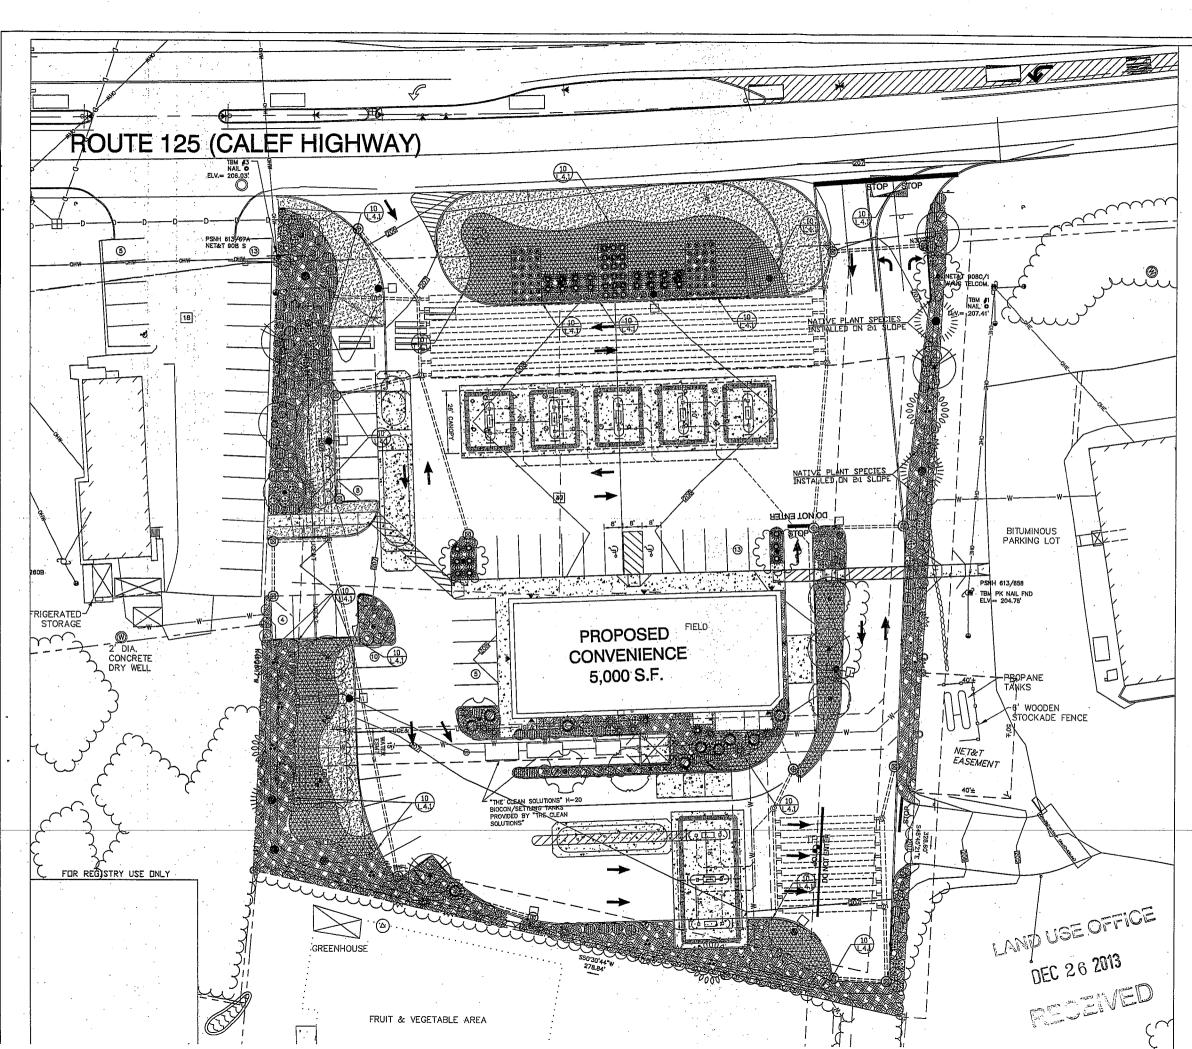

		EES SIZE NOTE	S QTY	AMORY LAND DESIGN, LLC. 26B STRONG STREET NEWBURYPORT, MA 01950-2324
_ \ گر	Decidious Tree to Ref Reference Civil Burve	nain Varies y for Additional Information		
1	DECIDIOUS TR Betula populitolia Gray Birch Earth Balt Sizee: 15,11	19° Bali Muti-In 9,23,27,31 Bali Dia.= Caliper Size: 1*	unk 4 ,1.5",2.",2.5",3" Cal.	
	White Ash Earth Ball Street: 15,11 Liquidamber styracifu	9,23,27,31 Ball Dis.= Calipor Size; 1*,	. 1	
ا چ	Bweetgum Earth Ball Sizes: 16,10 Pyrus calleryana 'Brad	9,23,27,31 Bali Dis.= Caliper Siza; 1, lioro' 23° Bali	15",2.",25",3" Cal. 3	
	Earth Ball Stree: 15,16 Quercus palustris Pin Oak	9,23,27,31 Ball Dia,= Caliper Size: 1*, 19* Ball 9,23,27,31 Ball Dia,= Caliper Size: 1*,	5	
	CONIFER TREE		10	
Con the second	Tauga canadensia	23' Bali),23,27,31 Bali Dia.= Caliper Bize; 1*, 23' Bali	7	
	SHRUBS),23,27,31 Ball Dia.= Caliper Size: 1*, SIZE NOTES		· · · · · ·
	Buddleja davidi Butlerfly Bush Cornus serica Red Osler Dogwood	1 Gallon 1 Gallon	38	
1 2	Add Other Dogwood Hex glabra Inkberry Veccintum corymbosur	5 Gallon	9	
	Highbush Blueberry Viburnum opulus Highbush Cranberry	1 Gallon	31	
	GRASSES Helictotrichon sempery Bue Cat Grass		56	
4	Miscanthus sinensis "H Maiden Grass Variety Mointa caerulea 'Varie Striped Purple Moor G	gata' 1 Gallon	28 42	
	GROUNDCOVER Astillo chinensia pumli Feise Goat's Beerd		53	
	Penstemon newberryi Penstemon Sessonal Annuais Annual flower varieties	Fiata/Traya Plant no	mone 235 sq. ft.	
ď	VINES Clematis montena Clematis	SIZE NOTES 1 Gallon	<u>QTY</u> 4	
料既然	TURF AND SEED		QTY 6,256 S.F. 6,135 S.F.	· · ·
	LANDSCAPE MAT		QTY	
	Shraddad Hemiock Bar Landscape Border Annodized steel header	rk Mulch all plentis		
				• • • •
				• • • • • • • • • • • • • • •
	Detention Bestn Area	,	5,185 S.F.	
				<u>0' 10' 20' 40' NORTH</u>
	•			TROPIC STAR CONVENIENCE
		:		Project Address Collat Highway (Bourle 155) Boarbylon, New Yomgote Project Issue Dates: December 22nd 2013 Project Humber: 11-01150 Project Hamber: 2007address and Approval
	<u> </u>	APPROVED		Beviewed By: Howard Styder DELTA ISSUE TITLE DATE
	PI	LANNING BOARD		
		<u> </u>		HOWARD PLAN
			······································	
	DATE:			14 of 21

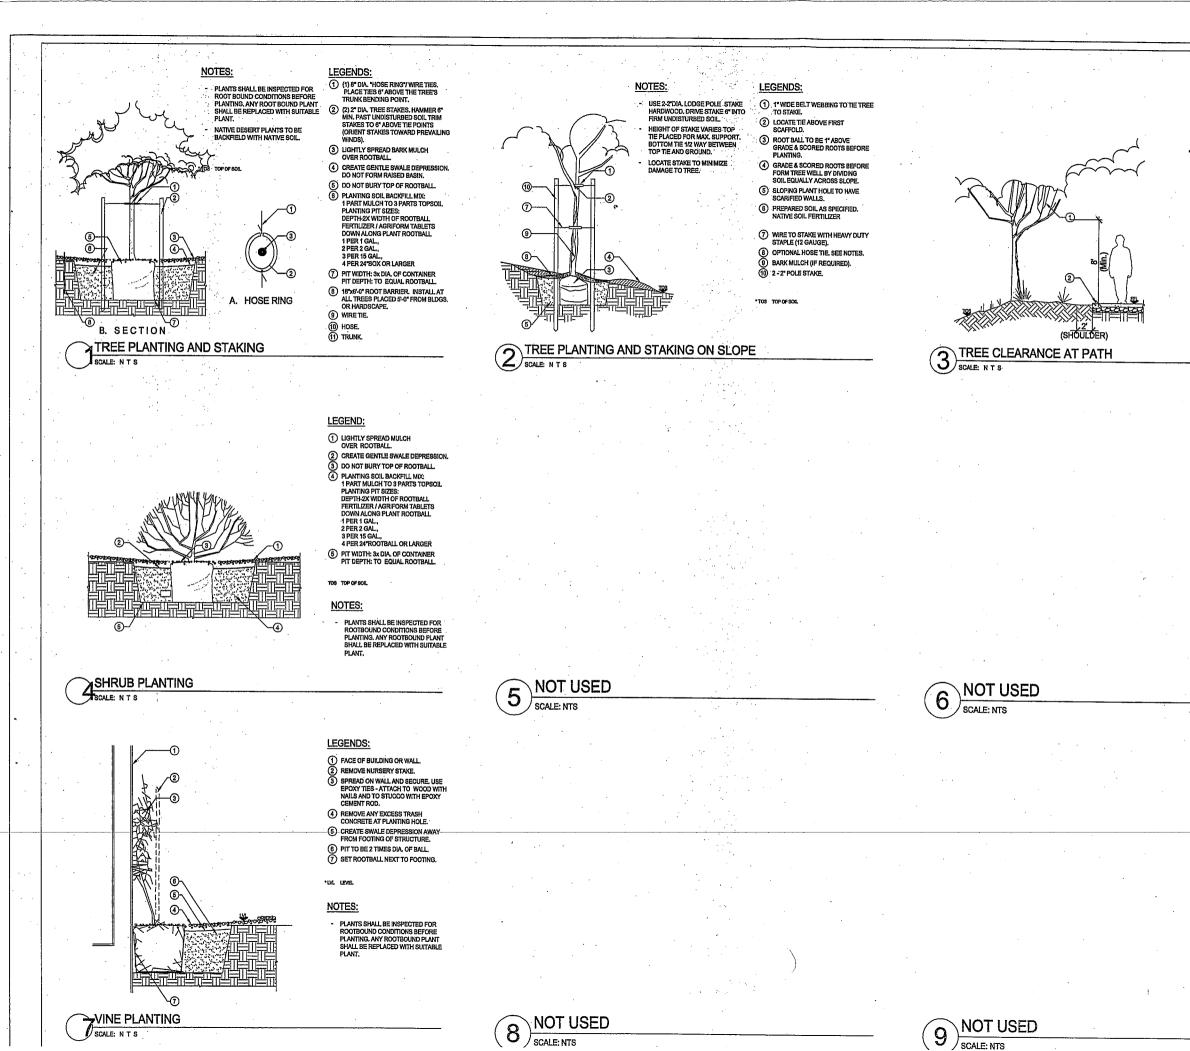

AMORY LAND DESIGN, LLC. 26B STRONG STREET NEWBURYPORT, MA 01950-2324

KEY:


CONCRETE PATHWAY/ BRICK WALKWAY


• FFL FINISH FLOOR LINE

TOS TOP OF SOIL

NOTES:

MAINTENANCE TO KEEP A MINIMUM 8'-0" CLEARANCE FROM PATH TO TREE CANOPY, TRIM AS NECESSARY,

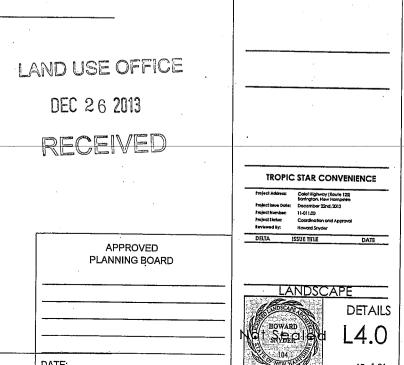

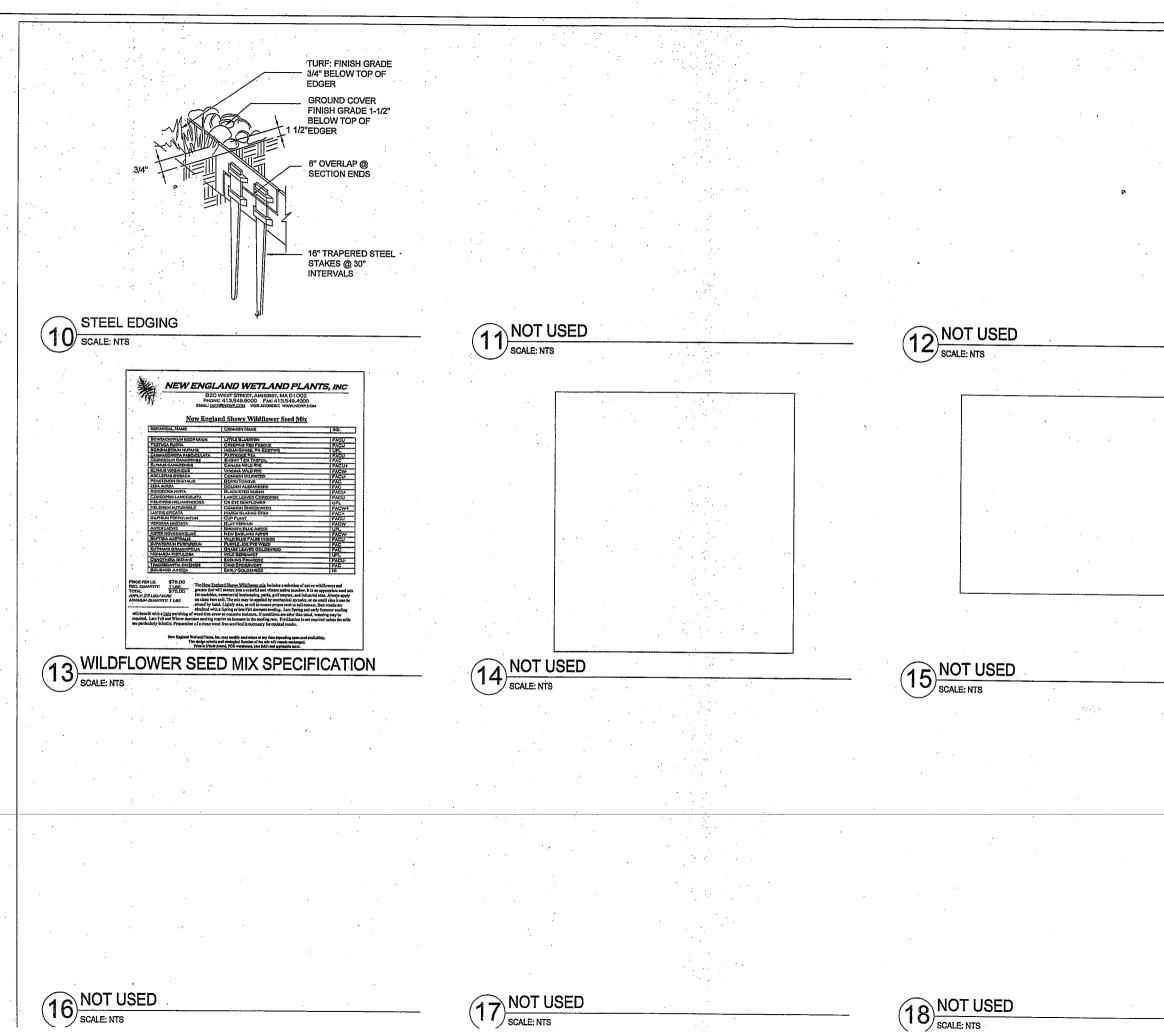

	AMORY LAND DESIGN, LLC.
	AMORY LAND DESIGN, LLC. 26B STRONG STREET NEWBURYPORT, MA 01950-2324
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- OFFICE	· · · · · · · · · · · · · · · · · · ·
LAND USE OFFICE	
DEC 26 2013	
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RECEIVED	
	Projeci Addresc Cold Highway (Routo 123) Bartington, New Hampphila
	Project insue Date: December 22nd, 2013 Project Number: 11-011.00 Project Status: Coordination and Approval
	Reviewed By: Howard Snyder DELTA ISSUE TITLE DATE
APPROVED PLANNING BOARD	
	DETAILS
	HOWARD I A T
	Not Stepled L4.1
DATE	DE NEW HAS

LANDSCAPE SPECIFICATIONS

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1.1 <u>Site Inspection</u>; Bidder is required to inspect site and thoroughly inform themselves of existing conditions. It is the responsibility of the bidder to inform the Landscape Architect of discrepancies between existing conditions and those shown on drawings prior to beginning construction.

1.2 <u>Project Completion;</u> shall be defined as the date construction is complete and the maintenance period begins.

1.3 <u>Guarantee Period:</u> Time defined in these attached documents during which the Contractor is responsible for the health and replacement of plant material.

1.4 <u>Work Experience</u>: The landscape contractor, with their bid submittal shall provide written verification of three (3) years demonstrative ability to perform the work specified herein. Past work shall be of eimilar type, scale and quality.

1.5 <u>Demage and Responsibility</u> Contractor shall assume full responsibility for any damage imposed, accidentally or intentionally, to existing utilities, buildings, or other amenities, due to the actions of the contractor, contractor enployees, and contractor's sub contractors. Contractor is required to protect work from damage and theit and replace all damage or stolen parts until the work is accepted in writing from the owner, without additional cost to the owner.

1.6 Unauthorized changes to plans: The Landscape architect preparing these plans is not responsible for, or liable for unauthorized changes to or used of these plans. All changes to the plans must be in writing and must be approved by the Landscape Architect and submitted to the Planning Board and Conservation Comission for approval prior to the commencement of any work.

1.7 <u>Permits:</u> The contractor's responsibility to apply, obtain, and pay for all required permits to complete the scope of work.

1.8 <u>Trade Coordination</u>: Construction and installation of items within these documenta requires close coordination between trades involved in underground / utility installation and the location of improvements. Contractor is responsible to insure proper coordination between trades to ensure and avoid construction delays or damage to any improvements or utilities.

1.9 <u>Underground service alert:</u> Contact Dig Safe System, Inc. 72 hours prior to digging at 1-888-Dig-Safe. The contractor shall exercise extreme care in working near existing utilities. Verify the location and condition of utilities prior to construction. Pot holing required will be at no additional cost to owner.

1.10 <u>Insurance</u>: The contractor shall carry worker's compensation, public liability, and property damage insurance as required per local code and owner's agreement.

1.11 Hold harmless and Indemnification clause; Contractor assumes sole and complete responsibility for the job sits conditions during the course of construction of the project. Including setted to all persons and property This requirement applies continuously and not limited to normal working hours, and harmless from any and all liability, real or alleged. In connection with the performance of work on the project, excepting for liability arising from the sole negligence of the Landscape Architect.

1.12 <u>Inspections</u>: The contractor is responsible for notifying the municipal representative prior to any required municipal inspection. The contractor shall notify the Landscape Architect at least 48 hours in advance prior to any required or desired inspection at (976) 764-6155. These drawings and specifications are property and copyright of Amory Land Design, LLC. These drawings shall not be used on any other work except by written authorization from Amory Land Design, LLC. Contact: Howard Snyder, RLA at (978) 764-6155.

1.13 <u>Dimensions</u>: The written dimension takes preference over acale dimensions and verified on the job site. Discrepancies must be brought to the attention of the Landscape Architect prior to the commencement of work.

1.14 <u>Questions:</u> The Landscape Architect decides all questions relating to the interpretation of the drawings and the acceptable fulfillment of the contract.

1.15 Job Site: Maintain the premises clean and free of excess equipment materials and rubbish incidential of the work at all times including weekends and holidays. Dispose rubbis, trash, or items resulting from the demolition of construction in a legal, lawful and safe manner to an approved disposel alte.

2.0 WORK SPECIFIED HEREIN

2.1 <u>Included litems</u>: The work specified within this section includes labor, materials, equipment and services necessary to complete the improvements detailed and specified, including the following work nessonably incidental thereto. The Contractor shall be responsible for the following work unless otherwise specified on the plans.

2.2 <u>Coordination</u>: Coordinate the Imgation work, if any, to insure successful Integration with the landscaping.

2.2.1 <u>Grading</u>: Responsible for finish grade ± (.1) tenth of a foot beyond the related grading and drainage plans, Coordinate with civil plans, if exist.

2.2.2 <u>Soli Preparation</u>: Soli condition and fine rake prior to planting lawns, ground cover, seeding and decomposed granite installation.

3.0 SAMPLES & TESTS

3.1 <u>Soll Tests</u>: The Landscape Architect reserves the right to take and analyze samples of materials for conformity to specifications at any time. Contractor shall furnish samples upon request by Landscape Architect. Rejected materials shall be immediately removed from the site and replaced at the Contractor's expense. Cost of testing of materials not meeting-specification is the Contractor's expense.

4.0 COORDINATION AND RESPONSIBILITY

4.1 <u>Collaboration with Trades;</u> Coordinate and cooperate with other trades working on the site for successful completion of the project.

4.2 <u>Site knowledge</u>: Before commencing work on the site, become thoroughly acquainted with layout of all underground utilities and structures over the entire site. All requisite repairs to correct damage caused by work of this Section shall be at the Contractor's expense.

4.3 Existing material: Protect and maintain existing plant material and associated elements not indicated for removal as necessary to ensure survival.

4.4 <u>Pre-construction Conference</u>; A pre-construction conference is required prior to work. The Contractor, and related subcontractors together the Owner's representative and Landscape Architect are given an opportunity to review plans beginter before any work to performed. The purpose of this conference is to discuss the project in detail, including scheduling of work, site preparation, interpretation of documents and to answer questions that may arise. Unless followed up in writing, verbal authorizations or acknowledgment by anyone present are not be binding. It is the responsibility of the contractor to notify the owner and Landscape Architect 10 days prior before a date requested for the conference.

5.0 STANDARDS

5.1 <u>Quantity</u>: Quantities on plant list, if shown, are for reference purposes only. Contractor is responsible for installing all plant materials shown on the plans. If shown, quantities are provided for estimating or City approval purposes only, and are not to be considered accurate for bidding. All significant differences between the site and the drawings shall be reported to the Landscape Architect Immediately upon determining seld discrepancies. Failure to do so, require the Contractor to make additional plantings to file spaces, or other chances determined by the Landscape Architect and plantings to file spaces, or other thances determining to the contractor accurate for the contractor accurates.

5.2 <u>Plent Material Substitution</u>; At the time of bidding, the Contractor shall verify the ability to purchase all plant materials required to complete this work. Upon award of bide, the Contractor shall make arrangements with his suppliers for adequate and properly sized materials as specified on the plans. If perceived shortage is determined either at time of bidding, or upon award of contract, the supplier may employ one of the following methods.

5.2.1 <u>Contract Growing of Materials</u>: When required on the construction documents, and sufficient lead time allows, plants shall be contract grown. Specified minimum time of six months per container, prior to moving into larger sizes, shall be waived, provided adequate roots develop throughout the container to hold the soil together upon removal from the contract cast with the Owner prior to growing shall be stipulated to and agreed upon as a separate contract cast with the Owner prior to commencing any work toward contract cast with the Owner prior to commencing any work toward contract cast.

5.2.2 Substitution of Materials: If the above method proves inadequate, plant aubstitutions approval is required from the Owner/Landscape Architect. The Contractor can make recommendations to the Landscape Architect, in writing, for consideration. The substitutions must be make with the same eized container material, Substitutions will not be considered prior to bidding. The Contractor must provide a list of suppliers searched to the Landscape Architect to wellable. If recorded are the landscape of the lands

5.3 <u>Nomenclature</u>: If specific plant material is in question provide copies of the project's order forms to verify with the Landscape architect. The landscape architect will determine if any plant rejections occur. If requested, make plant material corrections at no expense to the owner. Names of plant materials on the plans are in accordance with the American Nursery and Landscape Association and/or as specified in the plant list.

5.4 Quality & Sizer, The quality and size of all plant materials shall be based upon the American Nursery and Landscape Association Accepted Standards for size, shape and calipor unless specified otherwise on the plans. Rejected materials shall be removed from the site, and replaced immediately the decision of the Landscape Architect shall be final. Container grown plants shall have been grown in containers or boxes for a minimum of six months, except when the plants hold the entire rootball together upon removal from the containers, without being root-bound. "Climatized" non-Massachusettes grown plants for at least four weeks in partial shade, during the summor months, pictor declivery to the site. These shall have straight trunks throughout their height, except multi-funked specified material. Any the with weak trunks inception or not.

5.5 <u>Plant Material Procurement</u>. Purchase trees, shrube, vines and groundcovers within 30 days of contract award by the owner. Forward written verification that this has taken place to the Owner and Landscape Architect. All storage and maintenance costs is borne by the Contractor.

5.6 <u>Inspection</u>. All plant materials are subject to acceptance or reject by the Landscape Architect. Notify the Landscape Architect after delivery of plant materials. The Landscape Archited will visit the alke, determine the quality of stored materials, and notify the Contractor of all rejected materials.

5.7 <u>Product Delivary. Storage & Hendling</u>. All plant materials delivered to the be planted as soon as practical, after hispection and approval. Keep all sun sensitive plant materials out of full sun during summer months. Delivery, maintenance and installation of all plant materials is the sole responsibility of the Contractor, and they shall make all arrangements for proper labor to avoid delays and rejection of plant materials which have been on-site too long without planting or installation.

6.0 MATERIALS

6.1 <u>Mulcin</u>: Use organic, well-rotted, decomposed bark fiber, (wood chips not acceptable) materials with no fillers or agents save for the balance of nitrogen-adding ingredients. Ph shall range from 6.8 to 7.2; molsture content shall be 30 to 40% by weight, and nutrients shall comply with the following minimum requirements by volume: Nitrate Nitrogen - 1.5%; Organic Nitrogen - 3.65%; Phosphorus - 1.14%; Potassium - 1.19%; Iron - 0.84%. Delivery to site shall be either bulk or marked bags. Acceptable products is dye-free "Hemicok Mulch" or accreved equal.

6.2 <u>Sand:</u> Shell be course, granular concrete sand or grout sand (not mortar or silica sand), conforming to ASTM C-33, thoroughly and uniformly washed, entirely free of oil or other deleterious substances.

 6.3 <u>Fertilizer/Hormones:</u> Apply Superthrive root stimulant as directed by manufacture at the time of installation. Provide a second applications a week later. Add 0/10/10 skowrelease tablet fertilizer and sulfur granular per manufacture specifications to the plant pit hack fill.

8.5 <u>Topsoli</u>: Mend soil free from non-organic refuse, noxicus weeds, nut grass, thomy clay, clods, roots and all material toxic to plant growth. Excavation may need to extend past the first 6° of soil on the site. Topsoli shall compty with MASSDct specifications.

6.6 <u>Planting Pit Backfill</u>: Use native top soil material generated from plant pit excervation with said amenibles evenly mixed in. Do not physically compact material, only water compact material in 2th always at a fune.

6.6.1 <u>Native Top Soll Dressing</u>: Produced from on-site top soll. Generate during original site grading, coordinate with general contractor as required. Harvest the first 6* of native land to product material. Screen material aver only 4* minus product.
6.7 <u>Tree Staking, Guving & Bracing</u>: Stake 15-gal. and larger nursery trees shown on the

6.7.1 <u>Lodge Pole Staking:</u> Stakes shall be a 2* diameter round knot free Pine "lodge pole", length as required below, and installed as follows: Stakes immediately adjacent to, but in no case through, the noto ball, penetrating at least 8° into undisturbed soli, and aligned vertically. The stake alignment should not interfere with the existing branch structure of the tree. Install stakes as follows: 15-gel. -2 ea. 8' long pole; 24* and 30* drum laced root ball size -2 ea. 12' long stakes;

6.7.2 <u>Guying & Bracinci</u>, 38° root balli sized trees and larger size apply guying and bracing method. Use three guy wrins with ground stakes (see details on plans). Attach #8 gauge guy wire to a #5 ribbed bar 36° long with a drilled hole completely through the ground takko, and securing the wire with two mechanical dampe per wire. Use #12 gauge plastic coated guy wire for fastening trees to stake. Attach wire to trees at the lowest branches, encased with 24° rubber hoses, and clamped with at least two clamps. Use only rubber hosing, no plastic. Allow 4° min. clearance around the turnks of 36° box trees or larger. Set the ground stakes an appropriate distance from the tree to provide an approximate angle of 45 degrees between the ground and wire.

6.8 <u>Headens</u>: See plans and details for type of header and installation specifications. All headers shall be mounted with their tops flush with sidewalks, kept 1 1 slove finished grades of decomposed granits. Use continuous curves and statisht find forms free of wiggles and dips. Notify the Landscape Architect 48 hours in advance for the opportunity to verify form work/layout prior to pour. Landscape architect reserves the right to reject any material thought to be improperly installed.

6.9 <u>Stone</u>: Provide material vold of lump and free of foreign substances. Use type and size specified on plans and in details. One color shall be used for the entire work, and shall be obtained from a single source.

6.10 Lawn Materials

р **р**

6.10.1 Sod: Kentucky Blugrass or as specified on the plans. Sod shall be warranted by grower to be weed-free, insect-free, disease, and toxin-free. No growth reducing chemical or condition shall be acceptable. Sod material to be provided from one source. Plant sod cut and harvested must be stacked, delivered and installed within 24 hours of initial harvest-cut. Any aod delivered to site must have accompring invoke/delivery dickets infloring time of cut; quantity delivered and any other pertinent information requested by Project Manager. Installation of cut and delivered sod shall commence immediately upon delivery.

7.0 PLANT INSTALLATION

7.1 Contractor shall stake tree locations as shown on drawings. The Landscape Architect shall field check the layout location of plants and will direct the Contractor to adjust to exact position before excavation begins. Notify the Landscape Architect at lesst 48 hours prior to scheduling work.

7.2 Notify the Landscape Architect of rock calache, hard pan clay, and other obstructions which are encountered in the excavation of plant pits. Alternative planting locations may be selected by Landscape Architect.

7.3 Plants to alt in a 2 deep basin (barely visible) Do not provide swales around planting plis,

7.4 Plants injured or root ball broken during planting operations will be rejected, cut larger containers as required to remove plant material without injury.

7.5 All ground cover and mulch areas shall be treated with a pre-emergent and herbicides as outlined in Section 7.9.

7.6 Set finished grade 1-2" below tops of header, walks, etc. (Typical)

7.7 Broom sidewalks and paving daily during planting operation. Empty plant containers and debris are to be picked up and disposed of daily. Contractor's trash shall be removed from the site at the completion of work.

7.8 Weed control: Remove all weeds by mechanical methods or by spraying with "Round-up" or equal. Remove all weeds by mechanical methods or by repeating sprayings of Round-up or equal. Use Manage on nut grass infestation as required. A pre-emergent such as "Dacha" or equal, shall be used in all decomposed granita areas. Follow manufacturers recommendations for applications. Plastic liners shall not be allowed. It is the sole responsibility of the contractor to provide a clean and weed free environment for plant material until the end of the maintenance period.

8.0 INSTALLATION

8.1 <u>Soil Preparation:</u> The Contractor shall be solely responsible for removing all ABC, rocks or foreign objects larger than 1" from all planted areas. The Contractor shall visit the site, and work with the General Contractor to assure themselves this provision is complied with. In areas where turf will not be planted, they shall take proper precautions for the removal of any existing turf and other aggressive weeds.

8.2 <u>Shrubs & Trees:</u> Shall be installed in accordance with the foregoing specifications and the details shown on the plans. Plant pits shall always provide adequate growth volumes for new roots, and shall meet the following minimum standards, which may be increased on the details: Dig planting pits 1.1/2 times the width and the same height of the root ball. Buried rootball will not be accepted.

8.3 Learn Materials: Soil Preparation: Clear and grub area, then scarify and cuttivate to a minimum depth of 8⁺; then set to finish grade. During the operation, remove debts, including all stones over 1⁺; In any dimensions, and disposed of offsite. Next, provide chemical fertilizer, 16-20-0 composition, mechanically spread over the entire area at an average rate of 10 pounds par 1000 sq. R. Cuttivate tertilizer into the top sky index of a solution the Landscape Architect for inspect and sprove these area prior to planting.

Special handling and installation requirements are as follows: 1. All sod delivered shall be installed within the 24 hour hervest/in

All sod delivered shall be installed within the 24 hour harvestinstallation time frame.
 All sod installed shall be laid down using a steggered seam regimen, alternating each set of rows so no two ends of sod strip are adjacent to each other.
 Once installed sod is watered and all timmings and scraps are removed and disposed for all the remeas shall be power-rolled using a tleast a 500 pound weighted roller. All areas shall be rolled in perpendicular directions making contain all areas are rolled at least two times.

4. Commence infigation to installed turt as soon as possible. Any areas not receiving infigation water due to infigation design or installation problems, shall receive immediate hand watering attention by installation crew members and subsequently report problem to Project. Manager.

8.4 <u>Berms/Grading</u>: Earth berms shall be formed as indicated on the plans. Grading responsibility shall be work of the mass grading contractor unless specified otherwise on the construction documents. The Landscape Architect shall approve all grading based on assihilds, prior to any tree infigation and site improvements. The CAVI Engineer shall approve all grading and placed your drainage. Approvals must be obtained in writing prior to commending landscape work. Notify Landscape Architect at least 48 hours prior to scheduled work.

9.0 PRUNING AND REPAIR

9.1 Upon completion of the work of this Section, prune trees and shrubs if required or directed by the Landscape Architect, and injuries repaired. Limit amount of pruning to the minimum necessary to remove dead and injured twigs and branches. 10.0 GUARANTEE AND REPLACEMENT

10.1 Guarantee all lawns and planting for a period of 90 days from the date of final acceptance unless ditlewise noted. All lawns and planting shall be alive and in satisfac growth at the end of the guarantee period.

10.2 During the guarantee period, all plants shall be in a healthy, viable condition. Repl any plant not in a healthy condition when notified by the Landscape Architect. Should an difference of opinion arise over replacement, the Landscape Architect's decision is final.

10.3 Guarantee replacements for a period of 90 days from the date of final acceptance

10.4 The guarantee period for deciduous trees shall be in effect until all are showing ne growth the spring following planting provided the tree was installed just prior to it's doministage.

11.0 ACCEPTANCE OF WORK

11.1 After completion of all work and before the beginning of the maintenance period, notify the Landscape Architect to schedule the maintenance inspection. Provide on-site, complete set of as-builts for Landscape Architect review during the maintenance inspect.

11.2 Before scheduling the maintanance inspection, insure that all tests and work relate inigation is completed. The Landscape Architect shall be notified (14) days prior to scheduling inspection.

11.3 Insum that tree, shrub and ground cover quantities are according to plan and at correct spacings, and are in healthy substantially vigorous condition.

11.4 Irrigation system needs to be fully functional and complete on the data of inspectit for approval. Open all valve boxes and controllers to expose hardware for inspection jus prior to the arrival of the Landscape Architect/ Owner. Demonstrate the operation of all remote control valves from the controller, in sequence, and provide enough time for the Landscape Architect to inspect all areas being watered.

11.5 Should the Landscape Architect or Owner's representative determine the sits to be sufficiently incomplete or poorly installed, they reserve the right to postpone or extend the maintenance period until the project is in acceptable condition.

12.0 MAINTENANCE

12.1 Maintenance shall be for a period of 90 days from date of final acceptance unless noted otherwise.

12.2 Ground cover areas shall be maintained weekly for first thirty days, bi-weekly durin the remaining days, removing all weeds and grasses, and the-tuning the imigation syste to ensure adequate coverage while minimizing oversprey.

12.3 Lawns shall not be mowed until the height reaches 2 and 1/2* keeping all heavy objects off lawns until that time. Allow one day without water prior to mowing.

12.3.1 Lawns shall be fertilized at 30 day intervals with 5 lbs. of Ammonia Sulfate per 1 sq. ft. Contractor shall supply proof of these fertilizations prior to final acceptance by the Landscape Architect.

12.4 During the entire maintenance period, the Contractor shall be responsible for all weeding, spraying, fertilizing, moving, raking, aweeping, mulcihing, replanting and watar areas with proper amounts of watar to assure proper growth of all planted materials.

12.5 The maintenance period may be extended by the Landscape Architect if in their opinion the project is not being properly maintained during the designated period.


13.0 FINAL ACCEPTANCE


13.1 Notify the Landscape Architect at least 14 days in advance of their final inspection. All punch-list tisms generated from the 'Acceptance of Work' must be completed. The sith must be in perfect condition, with lawns mowed and timmed (clippings removed), plants areas free from weeds/grasses, all rafuse removed from planted areas, walks and drives clean and dry. The Contractor reprogram a final watering times and crycles of all aprinkle, impact areas after initial times were set during the construction process. List in writhing the watering schedules for the owner to present to his maintenance staff. If all is in order, or can be made so within 24 hours, the site will be accepted verbally at this time, or extended util such time as the site and be accepted. A 'Latter of Acceptance' from the Landscape Architect will be presented to the contractor within (14) days signing off each party from contracted collegations to the document's work accomplished. Should the projer the time. All additional time/cost involvement required additional affordance party from contracted at \$750.00 per low rule rules accepted.


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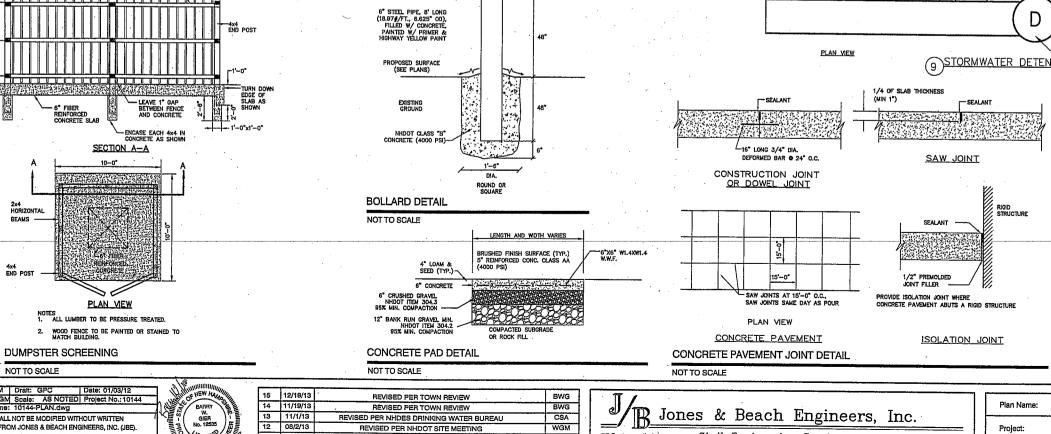
14 will be presented to the contractor within (14) days signing ad obligations to the document's work accomplished. Should laintenance, the Landscape Architect shall notify the involved nai time/cost involvement required by the Landscape Archite maintenance period will be the responsibility of the Contracto 5.00 per hour plus expenses.

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REVE	TROPIC STAR COMPANY
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	Project Number: Cord Highway (Route 123) Bornington, New Hompshie Project Issue Date: December 22nd, 2013 Project Number: 11-011.00
	Froject Number: 11-011.00 Project Skrive: Coordination and Approval Reviewed By: Howard Snyder
APPROVED	DELTA ISSUE TITLE DATE
PLANNING BOARD	
	SPECS



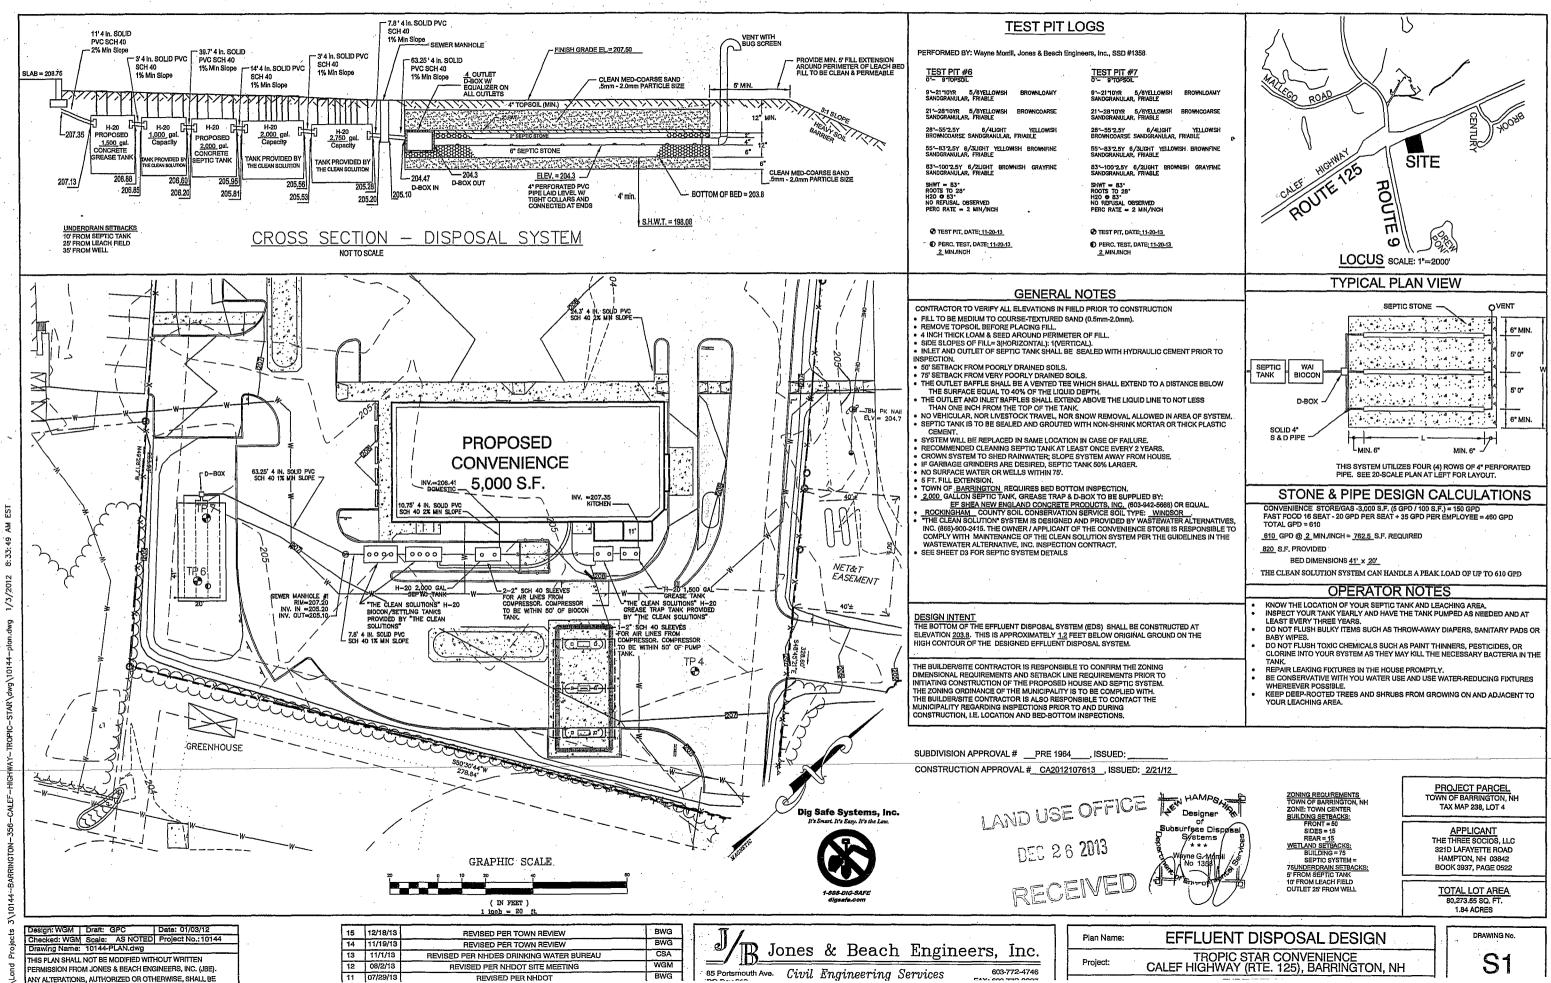

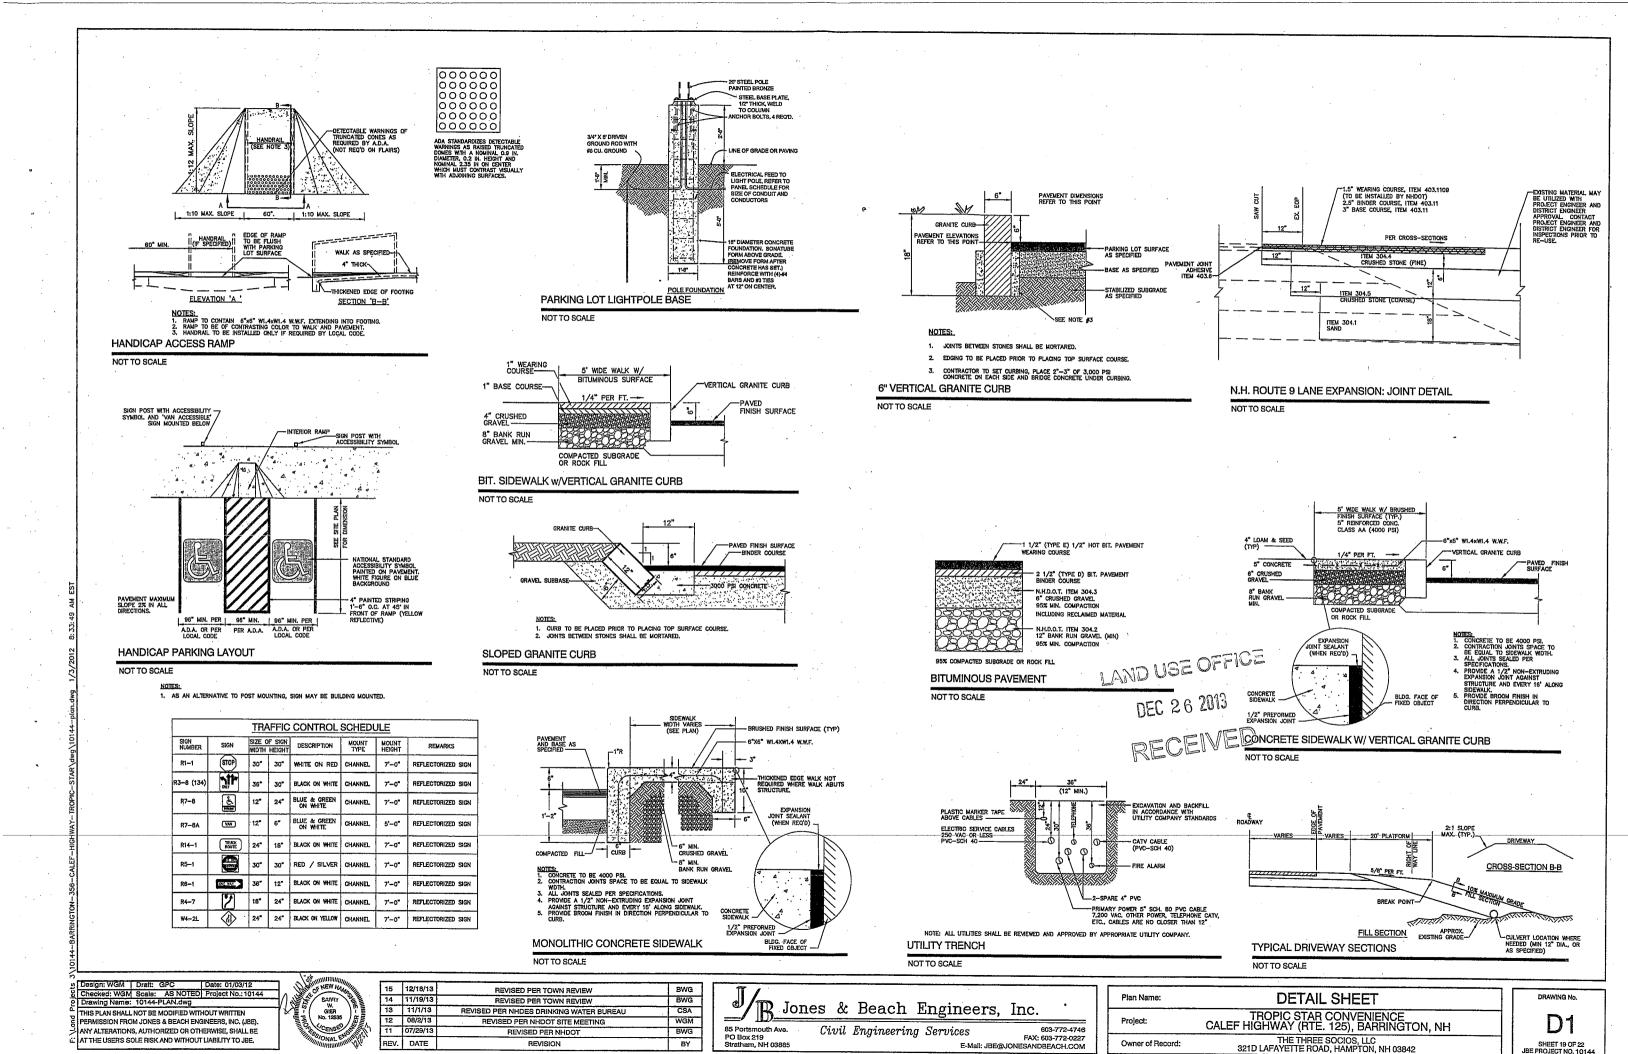

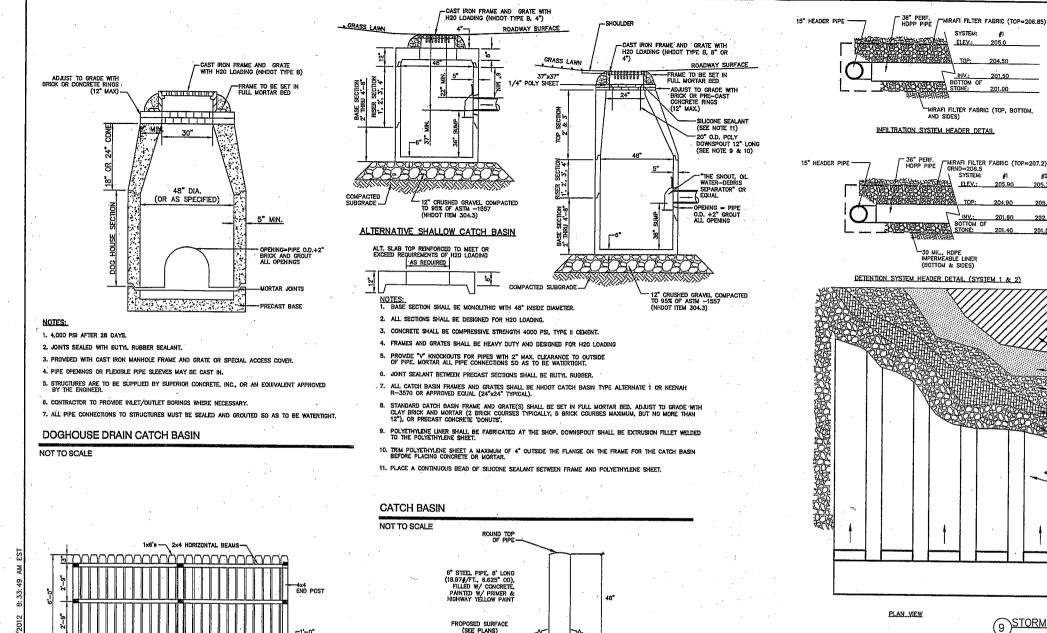

85 Portsmouth Ave.

Stratham, NH 03885

PO Box 219

BWG

BY

Civil Engineering Services

603-772-4746

FAX: 603-772-0227

E-Mail: JBE@JONESANDBEACH.COM

Checked: WGM Scale: AS NOTED Project No.: 10144 Drawing Name: 10144-PLAN.dwg

HIS PLAN SHALL NOT BE MODIFIED WITHOUT WRITTEN PERMISSION FROM JONES & BEACH ENGINEERS, INC. (JBF). ANY ALTERATIONS, AUTHORIZED OR OTHERWISE, SHALL BE AT THE USER'S SOLE RISK AND WITHOUT LIABILITY TO JBE.


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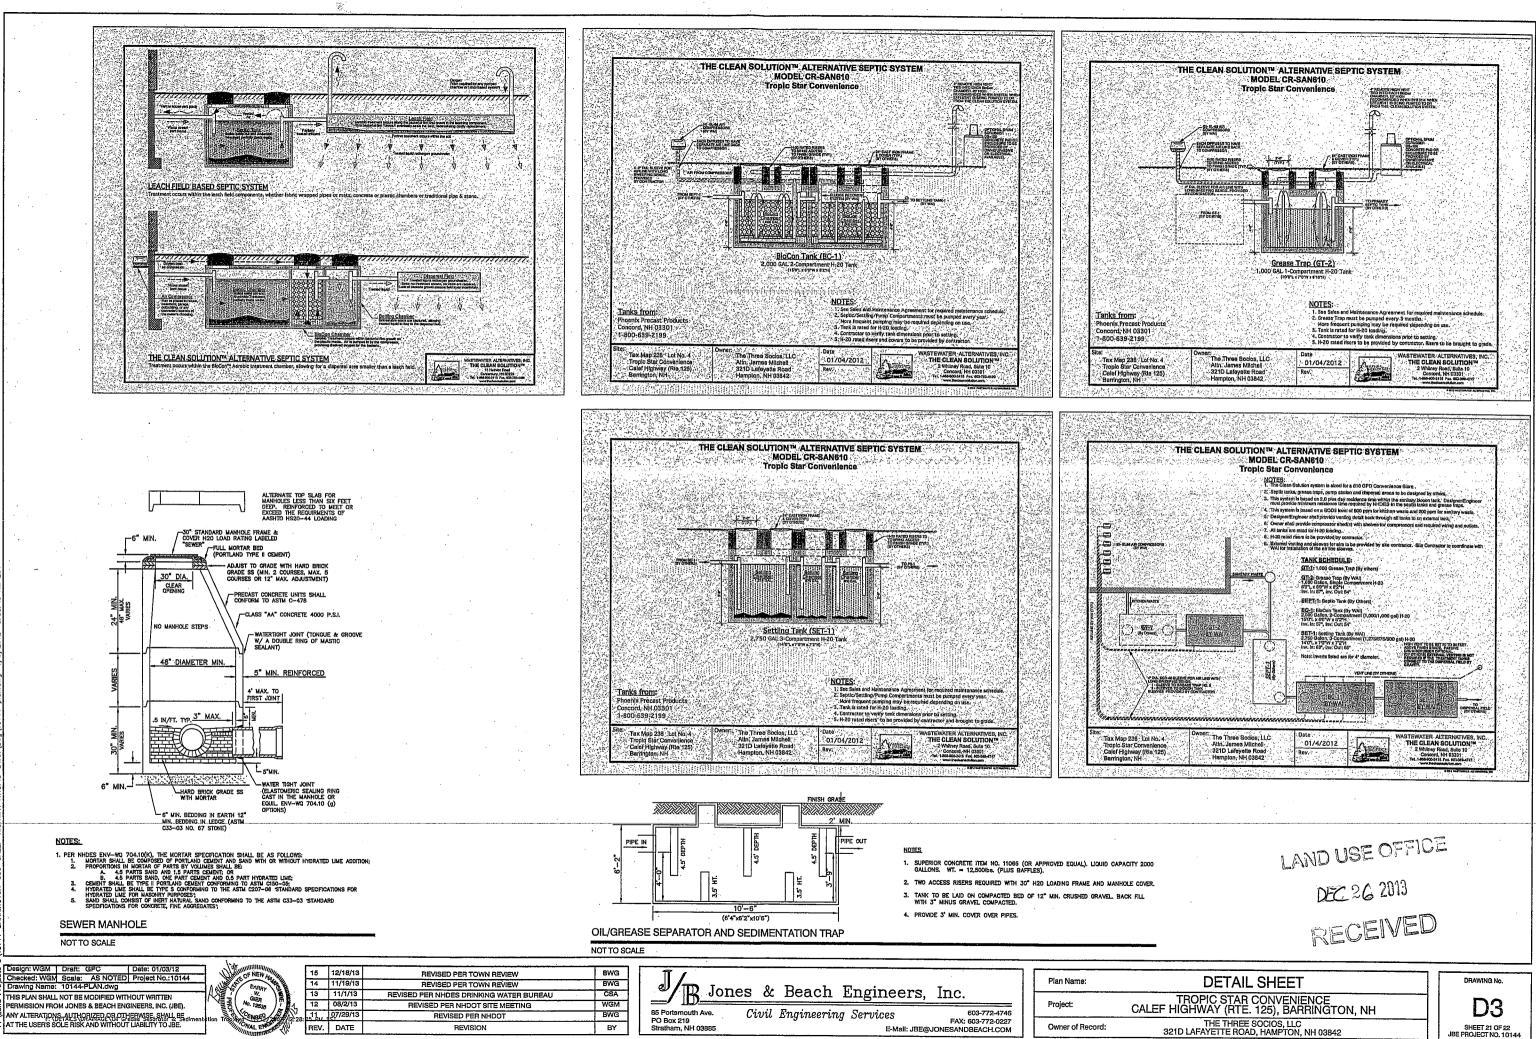
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BEV.

REVISED PER NHDOT

REVISION



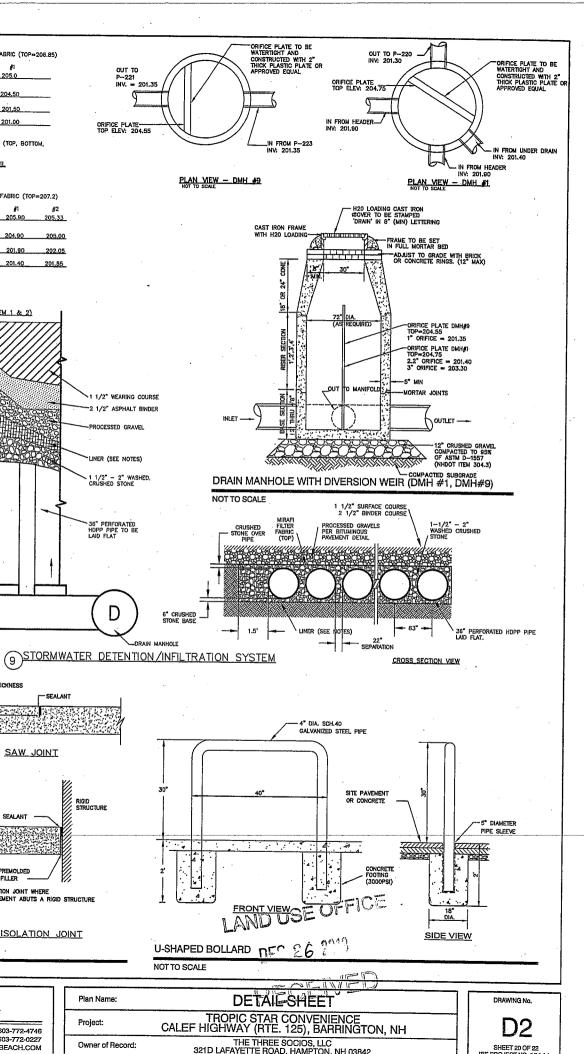

- TEMPORARY EROSION CONTROL NOTES THE SMALLEST PRACTICAL AREA OF LAND SHALL BE EXPOSED AT ANY ONE TIME. AT NO TIME SHALL AN AREA IN EXCESS OF THAT REQUIRED FOR CONSTRUCTION BE EXPOSED.
- . EROSION, SEDIMENT AND DETENTION MEASURES SHALL BE INSTALLED AS SHOWN ON THE PLANS AND AT LOCATIONS AS REQUIRED DIRECTED BY THE ENGINEER.
- All disturbed areas shall be returned to proposed grades and elevations. Disturbed areas shall be loamed with a minimum of 5° of screded organic loam and seeded with seed mixture 'C' at a rate not less than 1.10 pounds of seed per 1.000 s.P. of area (48 lbs. / Acre.)
- SLT FENCES AND OTHER BARRIERS SHALL BE INSPECTED EVERY SEVEN CALENDAR DAYS AND WITHIN 24 HOURS OF A RAINFALL OF 0.5" OR OREATER. ALL DAMAGED AREAS SHALL BE REPAIRED, AND SEDIMENT DEPOSITS SHALL PERIODICALLY BE REMOVED AND DISPOSED OF.
- AFTER ALL DISTURBED AREAS HAVE BEEN STABILIZED, THE TEMPORARY EROSION CONTROL MEASURES SHALL BE REMOVED AND THE AREA DISTURBED BY THE REMOVAL SMOOTHED AND RE-VEGETATED.
- AREAS MUST BE SEEDED AND MULCHED OR OTHERWISE PERMANENTLY STABILIZED WITHIN 3 DAYS OF FINAL GRADING, OR TEMPORARILY STABILIZED WITHIN 14 DAYS OF THE INITIAL DISTURBANCE OF SOIL
- ALL PROPOSED VEGETATE AREAS THAT DO NOT EXHIBIT A MINIMUM OF 85 PERCENT VEGETATIVE GROWTH BY DCTOBER 15, OR WHICH ARE DISTURED AFTER OCTOBER 15, SHALL BE STABILIZED BY SEEDING AND INSTALLING NORTH AMERICAN GREEN 575 ENOSING CONTROL BLANKETS (OR AN EQUIVALENT APPROVED IN WHITHING BY THE ENGINERT) ON SLOPES GREATE THAN 3-1, AN SEEDING AND PLACING 3 TO 4 TONS OF MULCH PER ACRE, SECURED WITH ANCHORED NETTING, ELSEWHERE, THE INSTALLATION OF EROSING CONTROL, BLANKETS OR MULCH AND NETHING SHALL NO IOCCUR OVER ACCUMULATED SNOW OR ON FROZEN GROUN AND SHALL BE COMPLETED IN ADVANCE OF THAW OR SPRING MELT EVENTS.
- ALL DITCHES OR SWALES WHICH DO NOT EXHIBIT A MINIMUM OF 85 PERCENT VEGETATIVE GROWTH BY OCTOBER 15, OR WHICH ARE DISTURBED AFTER OCTOBER 15, SHALL BE STABILIZED TEMPORARILY WITH STONE OR EROSION CONTROL BLANKETS APPROPRIATE FOR THE DESING FLOW CONDITIONS.
- AFTER NOVEMBER 15th, INCOMPLETE, ROAD OR PARKING SURFACES, WHERE WORK HAS STOPPED FOR THE WINTER SEASON, SHALL BE PROTECTED WITH A MINIMUM OF 3" OF CRUSHED GRAVEL PER NHOOT ITEM 304.3.

- AREA SHALL BE CONSIDERED STABLE IF ONE OF THE FOLLOWING HAS OCCURRED: BASE.COURSE GRAVELS HAVE BEEN INSTALLED IN AREAS TO BE PAVED; A MINIMUM OF BSY VEGETATED GROWTH HAS BEEN ESTABLISHED; A MINIMUM OF 3° OF NON-EROSIVE MATERIAL SUCH STORE OR RIPRAP HAS BEEN INSTALLED; OR EROSION CONTROL BLANKERS HAVE BEEN PROPERTY INSTALLED.
- IN ORDER TO ENSURE THE STABILITY OF THE SITE AND EFFECTIVE IMPLEMENTATION OF THE. SEDIMENT AND EROSION CONTROL MEASURES SPECIFIED IN THE PLANS FOR THE DURATION OF CONSTRUCTION, THE CONTRACTOR SHALL BE IN STRICT COMPLANCE WITH THE FOLLOWING INSPECTION AND MAINTENANCE REQUIREMENTS IN ADDITION TO THOSE CALLED FOR IN THE SIMPP: A A CERTIFIED PROFESSIONAL IN EROSION AND SEDIMENT CONTROL OR A PROFESSIONAL ENGINERY LICENSED IN THE STATE OF NEW HAMPSHIRE "(MONITOR") SHALL BE EMPLYED TO INSPECT THE STAFT OF ALTERATION OF TERRAIN ACTIVITIES UNTIL THE SITE IS IN FULL COMPLIANCE WITH THE SITE FROM THE STAFT OF ALTERATION OF TERRAIN ACTIVITIES UNTIL THE SITE IS IN FULL COMPLIANCE WITH THE SITE SPECIFIC PERMIT ("PERMIT").
- B. DURING THIS PERIOD, THE MONITOR'SHALL INSPECT THE SUBJECT SITE AT LEAST ONCE A WEEK, AND IF POSSIBLE, DURING ANY & INCH OR GREATER RAIN EVENT (LE. & INCH OF PRECIPITATION OR MORE WITHIN A 24 HOUR PERIOD). IF UNABLE TO BE PRESENT DURING SUCH A STORM, THE MONITOR SHALL INSPECT THE SITE WITHIN A 24 HOURS OF THIS EVENT.
- C. THE MONITOR SHALL PROVIDE TECHNICAL ASSISTANCE AND RECOMMENDATIONS TO THE CONTRACTOR ON THE APPROPRIATE DEST MANAGEMENT PRACTICES FOR EROSION AND SEDIMENT CONTROLS REQUIRED TO MEET THE REQUIREMENTS OF RSA 485 A:17.
- D. FUGITIVE DUST CONTROL IS REQUIRED TO BE CONTROLLED IN ACCORDANCE WITH ENV-A 1000, AND THE PROJECT IS TO MEET THE REQUIREMENTS AND INTENT OF RSA 430:53 AND AGR 3800 RELATIVE TO INVASIVE SPECIES.

- SEEDING SPECIFICATIONS
- GRADING AND SHAPIN
- ANDING AND SHAPING. A. SLOPES SHALL NOT BE STEEPER THAN 2:1 WITHOUT APPROPRIATE EROSION CONTROL MEASURES AS SPECIFIED ON THE PLANS (3:1 SLOPES OR FLATTER ARE PROFERRED). B. WHERE WOMNO WILL BE DONE, 3:1 SLOPES OR FLATTER ARE PROFUMENDED.

SEEDING MIXTURE 1/

- SEEDRED PREPARATION
 A. SURFACE AND SEEPAGE WATER SHOULD BE DRAINED OR DIVERTED FROM THE SITE TO PREVENT DROWNING OR WINTER KILLING OF THE PLANTS.
 B. STONES LARGER THAN 4 INCHES AND TRASH SHOULD BE REMOVED BECAUSE THEY INTERFERE WITH SEEDING AND FUTURE MAINTENANCE OF THE AREA. WHERE FEASIBLE, THE SOL SHOULD BE TILLED TO A DEPTH OF ABOUT 4 INCHES TO PREPARE A SEEDBED AND FERTILIZER AND LINE MIXED INTO THE SOLI-THE SEEDING SHOULD BE LEFT IN A REASONABLY FIRM AND SMOUTH CONDITION. THE LAST TILLAGE OPERATION SHOULD BE PERFORMED ACROSS THE SLOPE WHEREVER PRACTICAL
- 3. ESTABLISHING A. STAND.
 A. LINE AND FERTILIZER SHOULD BE APPLIED PRIOR TO OR AT THE TIME OF SEEDING AND INCORPORATED INTO THE SOLL TYPES AND AMOUNTS OF LINE AND FERTILIZER SHOULD BE BASED ON AN EVALUATION OF SOLL TESTS. WHEN A SOLL TEST IS NOT AVAILABLE, THE FOLLOWING MINIMUM AMOUNTS SHOULD BE APPLIED: AGRICULTURAL LIMESTONE, 2 TONS PER ACRE OR 100 LBS. PER 1,000 SQ.FT. NITROGEN(N), SO LBS. PER ACRE OR 1.1 LBS. PER 1,000 SQ.FT. PHOSPHATE(P205), 100 LBS. PER ACRE OR 2.2 LBS. PER 1,000 SQ.FT. POTASH(K20), 100 LBS. PER ACRE OR 2.2 LBS. PER 1,000 SQ.FT.

- (NOTE: THIS IS THE EQUIVALENT OF 500 LBS, PER ACRE OF 10-20-20 FERTILIZER OR 1,000 LBS, PER
- (NOISE INIS IS THE EQUIVALENT OF SUO LDS, PER ACRE OF TO-20-20 FERTILIZER CR 1,000 ELS, PER ACRE OF 5-10-10,5 SEED SHOULD BE SERIED UNIFORMLY BY THE METHOD MOST APPROPRIATE FOR THE SITE. METHODS INCLUDE BRADCASING, BUILIDIG AND YEARDSEEDING, WHERE BRADACSING IS USED, COVER SEED WITH 25 INCH OF SOL OR LESS, BY CULTIPACKING OR RAKING. REFER TO THE SEEDING GUIDE' AND SEEDING RATES TABLES ON THIS SHEET FOR APPROPRIATE SEED MIXTURES AND RATES OF SEEDING. ALL LEGUMES (CROWNETCH, BIRDSFOOT, TREFOL AND FLATFEA) UIST BE INCOLLATED WITH THER SPECIFIC INCOLLANT PRIOR TO THEIS NITEDUCINTO THE SITE. WHEN SEEDED AREAS ARE MULCHED, PLANTINGS MAY BE MADE FROM EARLY SPRING TO EARLY OCTOBER. WHEN SEEDED AREAS ARE MOT MULCHED, PLANTINGS SHOULD BE MADE FROM EARLY SPRING TO MAY 201-OR FROM AUGUST 10th TO SEPTEMBER 1st.

DROUGHTY

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FAIR

1/ refer to seeding mixtures and rates in table below. 2/ poorly drained soils are not desirable for use as playing area and athletic fields.

SEEDING GUIDE

POUNDS

20

 $\frac{2}{42}$

-24 IN APPENDIX FOR RECO

USE

STEEP CUTS AND FILLS, BORROW AND DISPOSAL AREAS

WATERWAYS, EMERGENCY SPILLWAYS, AND OTHER CHANNELS WITH FLOWING WATER.

LIGHTLY USED PARKING LOTS, ODD AREAS, UNUSED LANDS, AND LOW INTENSITY USE RECREATION SITES.

PLAY AREAS AND ATHLETIC FIELDS, (TOPSOIL IS ESSENTIAL FOR GOOD TURF.)

RAVEL PIT, SEE N

- MULCH A. HAY, STRAW, OR OTHER MULCH, WHEN NEEDED, SHOULD BE APPLIED IMMEDIATELY AFTER SEEDING. B. MULCH WILL BE HELD IN PLACE USING APPROPRIATE TECHNIQUES FROM THE BEST MANAGEMENT PRACTICE FOR MULCHING. HAY OR STRAW MULCH SHALL BE PLACED AT A RATE OF 90 LBS PER 1000 S.F.
- MAINTENANCE TO ESTABLISH A STAND. A. PLANTED AREAS SHOULD BE PROTECTED FROM DAMAGE BY FIRE, GRAZING, TRAFFIC, AND DENSE WEED

WELL DRAINED

GOOD GOOD GOOD

EXCELLENT

GOOD EXCELLENT

GOOD GOOD EXCELLENT

EXCELLENT

ODERATE

good Fair Excellent

EXCELLENT

GOOD EXCELLENT

GOOD FAIR EXCELLENT

EXCELLENT

ENDATION REGARDING RECLAMATION OF SAND

POUNDS PER 1.000 Sc. Ft.

0.45 0.45 0.05 0.95

0.35 0.25 0.35

0.75 0.95 OR 1.35

0,45

POORLY DRAINED

FAIR FAIR GOOD

POOR


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FAIR POOR FAIR

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WELL

A. PLANTED AREAS SHOULD BE PROTECTED FROM DAMAGE BY FIRE, GRAZING, TRAFFIC, AND DENSE WEED GROWTH.
 B. FERTILIZATION. NEEDS SHOULD BE DETERMINED BY ONSTE INSPECTIONS. SUPPLEMENTAL FERTILIZER IS USUALLY THE KEY TO FULLY COMPLEMENTE THE ESTAND BECAUSE MOST PERENNIALS TAKE 2 TO 3 YEARS TO BECOME FULLY ESTABLISHED.
 C. IN WATERWAYS, CHANNELS, OR SWALES WHERE UNIFORM FLOW CONDITIONS ARE ANTICIPATED, ANNUAL MOMING MAY BE NECESSARY TO CONTROL REQUIP OF WOODY VEGETATION.



LEXISTING GROUNI

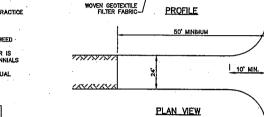STONE FOR STABILIZED CONSTRUCTION ENTRANCE SHALL BE 1 TO 2 INCH STONE, RECLAIMED STONE, OR RECYCLED CONCRETE EQUIVALENT.

50' Minimu

6" MIN.-


MOUNTABLE


PAVEMENT

- 2. THE LENGTH OF THE STABILIZED ENTRANCE SHALL NOT BE LESS THAN 50 FEET, EXCEPT FOR A SINGLE RESIDENTIAL LOT WHERE A 30 FOOT MINIMUM LENGTH WOULD APPLY."
- 3. THICKNESS OF THE STONE FOR THE STABILIZED ENTRANCE SHALL NOT BE LESS THAN & INCHES
- 4. THE WOTH OF THE ENTRANCE SHALL NOT BE LESS THAN THE FULL, WOTH OF THE ENTRANCE WHERE INGRESS OR EGRESS OCCURS, OR 10 FEET, WHICHEVER IS GREATER.

- 7. THE ENTRANCE SHALL BE MAINTAINED IN A CONDITION THAT WILL PREVENT TRACKING OR FLOWING OF SEDIMENT ONTO THE FUELC RIGHT-OF-WAY. THIS MAY RECURRE FERIODIC TOP DRESSING WITH ADDITIONAL STORE AS CONTIONS DEMONIO AND REPART AND/OR CLEAN OUT OF ANY MEASURES USED TO TRAP SEDIMENT. ALL SEDIMENT SPILED, WASHED, OR TRACKED ONTO THE FUELIC RIGHT-OF-WAY MUST BE REMOVED PROMPTLY.


STABILIZED CONSTRUCTION ENTRANCE

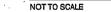

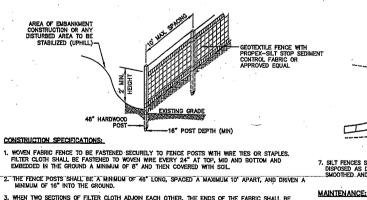

- 3. WHEN TWO SECTIONS OF FILTER CLOTH ADJOIN EACH OTHER, THE ENDS OF THE FABRIC SHALL BE OVERLAPPED 5°, FOLDED AND STAPLED TO PREVENT SEDIMENT FROM BY-PASSING.
- 4. MAINTENANCE SHALL BE PERFORMED AS NEEDED AND SEDIMENT REMOVED AND PROPERLY DISPOSED OF WHEN IT IS 6" DEEP OR VISIBLE 'BULGES' DEVELOP IN THE SILT FENCE.
- 5. PLACE THE ENDS OF THE SILT FENCE UP CONTOUR TO PROVIDE FOR SEDIMENT STORAG 6. SILT FENCE SHALL REMAIN IN PLACE FOR 24 MONTHS.

SILT FENCE NOT TO SCALE

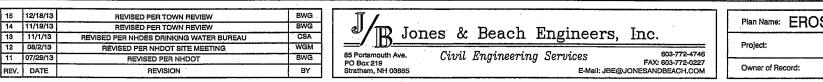

CONSTRUCTION SEQUENCE PRIVE TO THE START OF ANY ACTIVITY, IT IS THE RESPONSIBILITY OF THE SITE'S SITE DEVELOPER (OR OWNER) TO FILE A NOTICE OF INTENT (NO) FORM WITT THE ENVIRONMENTAL PROTECTION AGENCY (PA) IN ORDER TO GAIN COVERAGE UNDER THE NPDES PERMIT FOR STORM WATER DISCHARGES FROM CONSTRUCTION ACTIVITIES. A PRE CONSTRUCTION MEETING AT THE TOWNS DISCRETION IS TO BE HELD WITH ALL DEPARTMENT HEADS PRIVE TO TO THE START OF CONSTRUCTION.

WEILAND BOUNDARIES ARE TO BE CLEARLY MARKED PRIOR TO THE START OF CONSTRUCTION

CUT AND REMOVE TREES IN CONSTRUCTION AREA AS REQUIRED OR DIRECTED.

INSTALL SILT FENCING, HAY BALES AND CONSTRUCTION. ENTRANCES PRIOR TO THE START OF CONSTRUCTION. THESE ARE TO BE MAINTAINED UNTIL THE FINAL PAVEMENT SURFACING AND LANDSCAPING AREAS ARE ESTABLISHED,

CLEAR, CUT, GRUB AND DISPOSE OF DEBRIS IN APPROVED FACILITIES. THIS INCLUDES ANY REQUIRED DEMOLITION OF EXISTING STRUCTURES, UTILITIES, ETC.

CONSTRUCT AND/OR INSTALL TEMPORARY OR PERMANENT SEDIMENT AND/OR DETENTION BASIN(S) AS REQUIRED. THESE FACILITIES SHALL BE INSTALLED AND STABILIZED PRIOR TO DIRECTING RUN-OFF TO THEM.

STRIP LOAM AND PAVEMENT, OR RECLAIM EXISTING PAVEMENT WITHIN LIMITS OF WORK PER THE RECOMMENGINEER AND STOCKPILE EXCESS MATERIAL. STABILIZE STOCKPILE AS NECESSARY. DATIONS OF THE PROJECT

PERFORM PRELIMINARY SITE GRADING IN ACCORDANCE WITH THE PLANS

PREPARE BUILDING PAD TO ENABLE BUILDING CONSTRUCTION TO BEGIN

- INSTALL THE SEPTIC AND DRAINAGE SYSTEMS FIRST, THEN ANY OTHER UTILITIES IN ACCORDANCE WITH THE PLAN AND DETAILS, ANY CONFLICTS BETWEEN UTILITIES ARE TO BE RESOLVED WITH THE INVOLVEMENT AND APPROVAL OF THE ENGINEER.
- INSTALL INLET PROTECTION AT ALL CATCH BASINS AS THEY ARE CONSTRUCTED IN ACCORDANCE WITH THE DETAILS
- ALL SWALES AND DRAINAGE STRUCTURES ARE TO BE CONSTRUCTED AND STABILIZED PRIOR TO HAVING RUN-OFF DIRECTED TO THEM
- DAILY, OR AS REQUIRED, CONSTRUCT TEMPORARY BERMS, DRAINAGE DITCHES, CHECK DAMS, SEDIMENT TRAPS, ETC., TO PREVENT EROSION ON THE SITE AND PREVENT ANY SILTATION OF ABUTTING WATERS AND/OR PROPERTY.

PERFORM FINAL FINE GRADING, INCLUDING PLACEMENT OF 'SELECT' SUBGRADE MATERIALS

PAVE ALL PARKING LOTS AND ROADWAYS WITH INITIAL 'BASE COURSE'

RM ALL REMAINING SITE CONSTRUCTION (I.e. BUILDING, CURBING, UTILITY CONNECTIONS, ETC.).

LOAM AND SEED ALL DISTURBED AREAS AND INSTALL ANY REQUIRED SEDIMENT AND EROSION CONTROL FACILITIES (I.e. RIP RAP, EROSION CONTROL BLANKETS, ETC.).

FINISH PAVING ALL ROADWAYS AND PARKING AREAS WITH 'FINISH' COURSE

ALL ROADWAYS AND PARKING LOTS SHALL BE STABILIZED WITHIN 72 HOURS OF ACHIEVING FINISHED GRADE

20. ALL CUT AND FILL SLOPES SHALL BE SEEDED/LOAMED WITHIN 72 HOURS OF ACHIEVING FINISHED GRADE.

21. COMPLETE PERMANENT SEEDING AND LANDSCAPING

sign: WGM | Draft: GPC

Checked: WGM Scale: AS NOTED Project No.:10144 Drawing Name: 10144-PLAN.dwg

THIS PLAN SHALL NOT BE MODIFIED WITHOUT WRITTEI

PERMISSION FROM JONES & BEACH ENGINEERS, INC. (JBE).

ANY ALTERATIONS, AUTHORIZED OR OTHERWISE, SHALL BE

AT THE USER'S SOLE RISK AND WITHOUT LIABILITY TO JBE.

25; ALL-EROSION-CONTROLS-SHALL-BE-INSPECTED-WEEKLY-AND-AFTER-EVERY-HALF-INCH-OF-RAINFALL

REMOVE TEMPORARY EROSION CONTROL MEASURES AFTER SEEDING AREAS HAVE BEEN 75%-B5% ESTABLISHED AND SITE IMPROVEMENTS ARE COMPLETE. SMOOTH AND RE-VEGETATE ALL DISTURBED AREAS.

UNRY W. GIER No. 12535

CENS

12 08/2/13

REV. DATE

23. CLEAN SITE AND ALL DRAINAGE STRUCTURES, PIPES AND SUMPS OF ALL SILT AND DEBRIS

24. INSTALL ALL PAINTED PAVEMENT MARKINGS AND SIGNAGE PER THE PLANS AND DETAILS.

28. UPON COMPLETION OF CONSTRUCTION, IT IS THE RESPONSIBILITY OF THE CONTRACTOR TO NOTIFY ANY RELEVANT PERMITTING AGENCIES THAT THE CONSTRUCTION HAS BEEN FINISHED IN A SATISFACTORY MANNER.

3. TALL FESCUE CREEPING RED FESCUE CROWN VETCH OR FLAT PEA TOTAL 40 OR 55 TALL FESCU CREEPING RED FESCUE BIRDS FOOT TREFOIL TOTAL * -8-). TALL FESCUE FLAT PEA TOTAL 20 30 50 E. CREEPING RED FESCUE 1/ KENTUCKY BLUEGRASS 1/ TOTAL

MIXTURE

A. TALL FESCUE CREEPING RED FESCUE RED TOP TOTAL

1/ FOR HEAVY USE ATHLETIC FIELDS CONSULT THE UNIVERSITY ON NEW HAMPSHIRE COOPERATIVE EXTENSION TURF SPECIALIST FOR CURRENT VARIETIES AND SEEDING RATES.

0.45 0.20 1.10 0.45 1.15 1.15 2.30

. TALL FESCUE 3.60


SEEDING RATES

NOTE: TEMPORARY SEED NIX FOR STABILIZATION OF TURF SHALL BE WINTER RVE OR OATS AT A RATE OF 2.5 IBS. PER 1000 S.F. AND SHALL BE PLACED PRIOR TO OCTOBER 15th, IF PERMANENT SEEDING NOT. YET COMPLETE.

NOTES:

5. GEOTEXTILE FILTER FABRIC SHALL BE PLACED OVER THE ENTIRE AREA PRIOR TO PLACING THE STONE. FILTER FABRIC IS NOT REQUIRED FOR A SINGLE FAMILY RESIDENTIAL LOT.


All surface water that is flowing to or diverted toward the construction entrance shall be piped educatin the entrance. If piping is impractical, a stoke berm with 5:1 subject that can be crossed by vehicles may be substituted for the pipe.

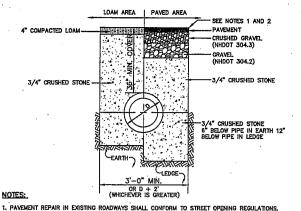

2. NEW ROADWAY CONSTRUCTION SHALL CONFORM WITH PROJECT AND TOWN SPECIFICATIONS 3. ALL MATERIALS ARE TO BE COMPACTED TO 95% OF ASTM D-1557

DRAINAGE TRENCH


NOT TO SCALE

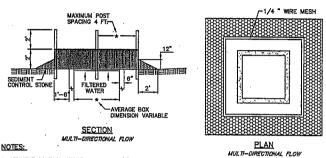

MULTI-1. SEDIMENT CONTROL STONE SHALL BE 3/4" WASHED STONE. 2. WRE MESH SHALL BE HARDWARE CLOTH 23 GAUGE MIN. AND SHALL HAVE 1/4 INCH MESH GPENINGS. 3. TOP OF MIRE MESH SHALL BE A MINIMUM OF ONE FOOT BELOW THE SHOULDER OR ANY DIMESION POINT. 4. STEEL POST SHALL BE 5 FT. IN HEIGHT, BE INSTALLED 1.5 FT. DEEP MINIMUM, AND BE: OF THE SELF-FASTERRET-RAGE. STEEL TYPE. 5. WOOD POST SHALL BE 6 FT. IN HEIGHT, BE INSTALLED 1.5 FT. DEEP MINIMUM, AND BE: OF MISSIENTER-MADE STEEL TYPE. 5. WOOD FOST SHALL BE 6 FT. IN HEIGHT, BE INSTALLED TO 1.5 FT. DEEP MINIMUM, AND BE: SINCHES IN DIAMETER. 6. POST SPACING SHALL BE A MAXIMUM OF 4 FT.

INLET PROTECTION

NOT TO SCALE

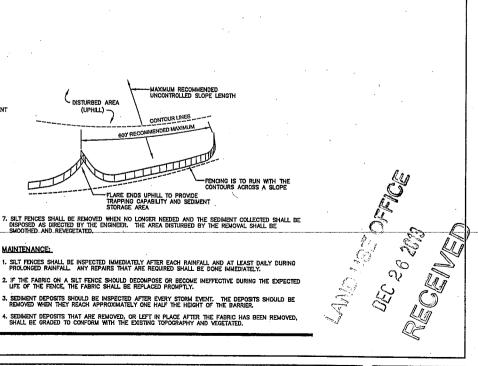


Plan Name: EROSION AND SEDIMENT CONTROL DETAILS TROPIC STAR CONVENIENCE CALEF HIGHWAY (RTE. 125), BARRINGTON, NH

THE THREE SOCIOS, LLC 321D LAFAYETTE ROAD, HAMPTON, NH 03842

E SHEET 22 OF 22 JBE PROJECT NO, 1014

DRAWING No.

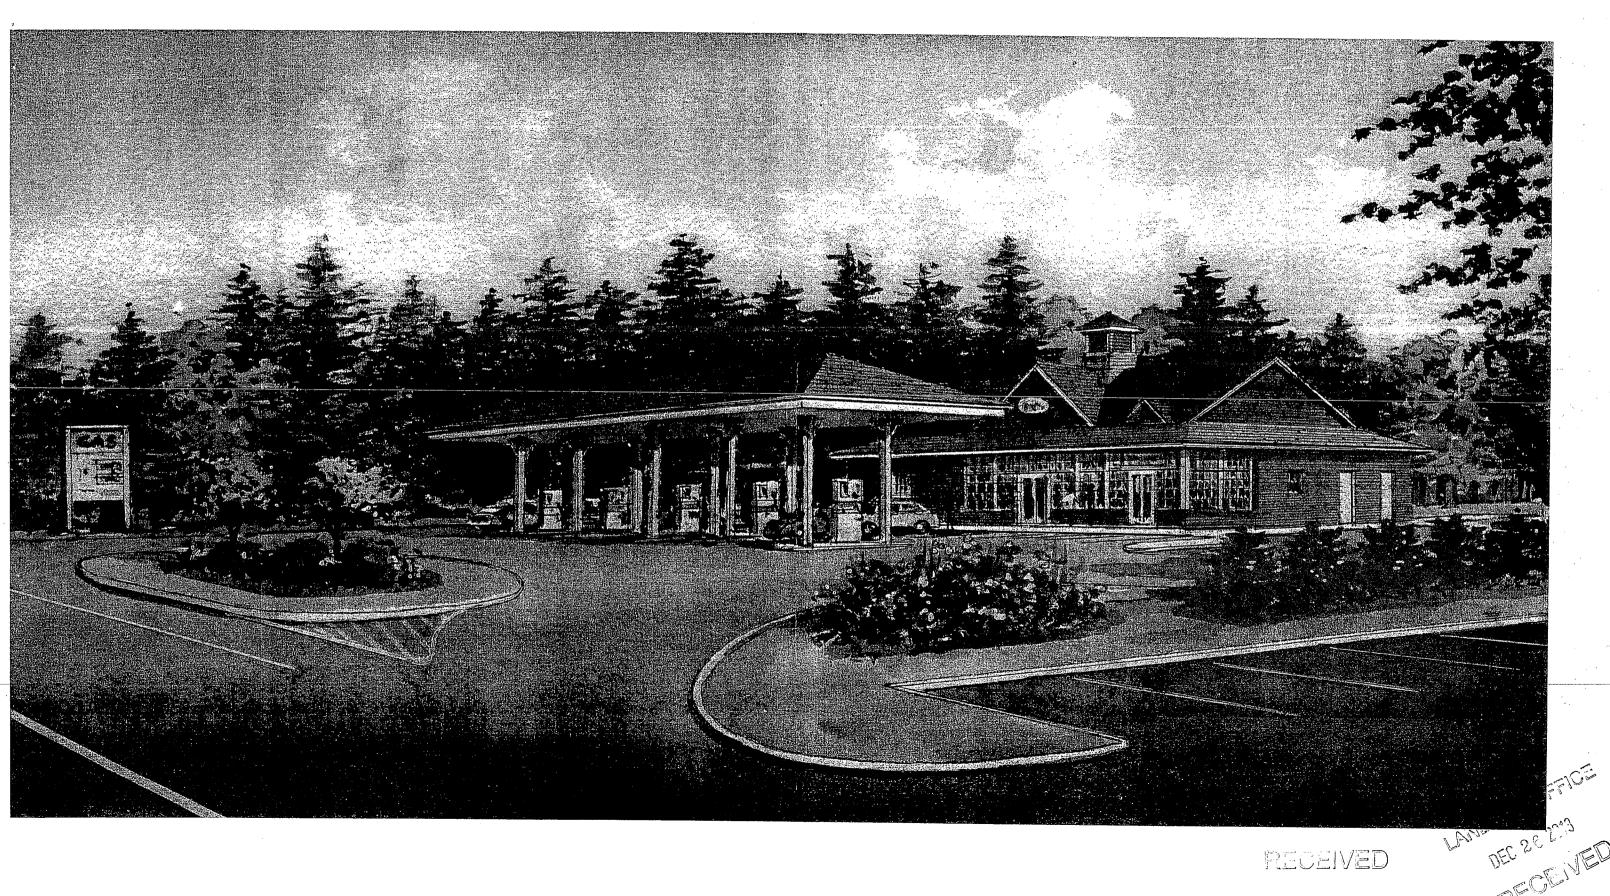

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